

FORM BR-III
(See Code 4.2 (4))
Form of Sanction

From

Chief Town Planner, Haryana-cum-Chairman,
Building Plan Approval Committee,
O/o Director, Town & Country Planning Department,
Haryana, Nagar Yojna Bhavan,
Madhya Marg, Sector 18, Chandigarh.
Tele-Fax: 0172-2548475; Tel.: 0172-2549851,
E-mail: tcpharyana7@gmail.com
Website www.tcpharyana.gov.in.

To

Elan Avenue Ltd. and other
(formerly known as Airmid Developers Ltd.),
15th floor, Two Horizon Center,
DLF Phase-V, Sector-43,
Golf Course Road, Gurugram-122002.

Memo No. ZP-1629/PA(DK)/2022/ 32388 Dated 26-10-2022

Subject: Approval of building plans for Group Housing Colony on area measuring 24.10 acres (Licence no. 80 of 2012 dated 17.08.2012) in Sector -106 Gurugram being developed by Elan Avenue Ltd. and others (earlier known as Airmid Developers Ltd.).

Reference your application dated 04.10.2022 for permission to erect the buildings in Group Housing Colony on area measuring 24.10 acres (Licence no. 80 of 2012 dated 17.08.2012) in Sector -106 Gurugram in accordance with the plans submitted with it.

Permission is hereby granted for the aforesaid construction subject to the provisions of the Punjab Scheduled Roads & Controlled Areas Restriction of Unregulated Development Act, 1963 and Haryana Building Code-2017, subject to the following amendments, terms and conditions:-

1. The plans are valid for a period of 2 years of the buildings less than 15.00 meters in height and 5 years for the multistoried buildings from the date of issuance of sanction, subject to validity of licenses granted for this scheme.
2. The structural responsibility of the construction shall be entirely of the owner/ supervising architect/ Engineer of the scheme.

Further that: -

- a) The building shall be constructed in accordance to the Structure Design by Structure Engineer and certified by Proof Consultant on prescribed FORM BR-V (A2).
 - b) All material to be used for erection of building shall conform to I.S.I. and N.B.C. standards.
 - c) No walls/ceiling shall be constructed of easily inflammable material and staircases shall be built of the fire resisting material as per standard specification.
 - d) The roof slab of the basement external to the buildings if any shall be designed/ constructed to take the load of fire tender up to 45 tones.
3. FIRE SAFETY:
- (i) The colonizer and the Supervising Architect of the project shall be entirely responsible for making provisions of fire safety and fire-fighting measures and shall abide by all fire safety bye laws.

- (ii) That you shall get approved the fire-fighting scheme in accordance with the Section 15 of the Haryana Fire Safety Act-2009 and directions issued by the Director, Haryana Fire Services, Haryana, before starting the construction work at site.
4. No addition and alteration in the building plans/ layout plan shall be made without the prior approval of DTCP. Further only figured dimensions shall be followed and in case of any variation in the plans, prior approval of DTCP shall be pre-requisite.
 5. That you shall furnish the service plan/ estimate of this scheme in accordance with approved building plans.
 6. Based on the actual estimated cost of internal development of the colony you shall furnish additional bank guarantee, if required.
 7. The revenue Rasta if any passing through the site shall be kept unobstructed.
 8. If any infringement of byelaws remains unnoticed, the Department reserves the right to amend the plan as and when any such infringement comes to its notice after giving an opportunity of being heard and the Department shall stand indemnified against any claim on this account.
 9. The layout showing the electric installation shall have to be got approved from the competent authority before execution of work at site.
 10. No person shall occupy or allow any other person to occupy any new building and before grant of occupation certificate, you shall apply for occupation certificate as per the provisions of Code 4.10 of the Haryana Building Code-2017 which shall be accompanied by certificates regarding completion of works described in the plans and it shall be accompanied by:
 - (i) Structural stability certificate duly signed by the recognized Architect & Structural Engineer.
 - (ii) A clearance from Fire Safety point of view from the competent authority.
 11. The provision of letter boxes for each dwelling unit shall be made at the ground floor of each building.
 12. The basements shall be used for parking and services as prescribed in the approved zoning plan and building plans. The parking lots proposed in the scheme shall be exclusively for the use of flat owners/residents of the group housing scheme. The parking lot shall not be leased out /transferred to any person who is not a flat owners /residents of the group housing complex.
 13. That you shall comply with the conditions laid down in the memo dated 13.10.2022 of Superintending Engineer, Infra-I, GMDA (Copy enclosed).
 14. That you shall comply with the conditions laid down in the Memo No. 10348 dated 19.09.2022 of Deputy Director, Directorate Fire Service, Haryana, Panchkula (Copy enclosed).
 15. GENERAL: -
 - (i) That you shall obtain the clearance/NOC as per the provisions of the Notification No. S.O. 1533 (E) Dated 14.9.2006 issued by Ministry of Environment and Forest, Government of India before starting the construction/execution of development works at site.

- (ii) That you shall strictly comply with the directions of MoEF Guidelines, 2010 while raising construction and comply with the instructions of Director, Town and Country Planning, Haryana, Chandigarh issued vide orders dated 14.5.2015 which is also available on the departmental website www.tcpharyana.gov.in.
 - (iii) That you shall submit the fire-fighting scheme duly approved in accordance with the section 15 of the Haryana Fire Safety Act 2009 and directions issued by Director, Urban Local Bodies Haryana before starting the construction work at site.
 - (iv) That you shall submit the approved Electrical Service Plan from competent authority and certificate to this effect that adequate arrangement has been put in place before grant of occupation certificate.
 - (v) That the rain water harvesting system shall be provided as per Central Ground Water Authority norms/Haryana Govt. notification as applicable.
 - (vi) That you shall use only Light-Emitting Diode lamps (LED) fitting for internal lighting as well as Campus lighting.
 - (vii) That you shall ensure the installation of Solar Photovoltaic Power Plant as per the provisions of order No. 22/52/2005-5Power dated 21.03.2016 issued by Haryana Government Renewable Energy Department.
 - (viii) That you shall strictly comply with the directions issued vide Notification No. 19/6/2016-5P dated 31.03.2016 issued by Haryana Government Renewable Energy Department.
 - (ix) That if any, site for Electric Sub Station is required, same will be provided by you in the colony.
 - (x) That provision of parking shall be made within the area earmarked /designated for parking in the colony and no vehicle shall be allowed to park outside the premises.
 - (xi) That you shall follow provisions of section 46 of 'The Persons with Disabilities (Equal Opportunities, protection of Rights and full Participation) Act, 1995' which includes construction of Ramps in public buildings, adaption of toilets for wheel chair users, Braille symbols and auditory signals in elevators or lifts and other relevant measures for Hospitals, Primary Health Centre and other medical care and rehabilitation units.
 - (xii) That you shall abide the terms and conditions of the Undertaking/Affidavit submitted in the office of Administrator, HSVP, Gurugram in compliance of Order dated 16.07.2012 of the Hon'ble High Court and shall not extract groundwater for construction purposes.
 - (xiii) That you shall abide by the policies issued by the Department regarding allotment of EWS flats time to time.
 - (xiv) That you shall not construct the building beyond 30.0 mtrs. without getting the valid NOC from AAI.
 - (xv) That you shall submit the scanned copy of the approved building plans in CD format within one week to this office from the issuance of this letter.
16. Environment: That you shall raise construction as per guidelines of MoEF-2010 issued regarding Building, Construction, Township and Area Development Projects.

17. In addition, you shall comply with the instructions of Director, Town & Country Planning, Haryana, Chandigarh issued vide order dated 14.05.2015, available on the Departmental Website www.tcpharyana.gov.in at URL [:https://tcpharyana.gov.in/Policy/Misc392%20A%20No.%2021%20of%202014%20Vardhaman%20Kaushik%20Vs.%20UOI_ors.pdf](https://tcpharyana.gov.in/Policy/Misc392%20A%20No.%2021%20of%202014%20Vardhaman%20Kaushik%20Vs.%20UOI_ors.pdf)

in compliance of the orders dated 10.04.2015 passed by Hon'ble National Green Tribunal in OA No. 21 of 2014, which are as under:

- (i) You shall put tarpaulin on scaffolding around the area of construction and the building. You are also directed that you shall not store any construction material particularly sand on any part of the street/roads.
- (ii) The construction material of any kind that is stored in the site will be fully covered in all respects so that it does not disperse in the Air in any form.
- (iii) All the construction material and debris shall be carried in the trucks or other vehicles which are fully covered and protected so as to ensure that the construction debris or the construction material does not get dispersed into the air or atmosphere, in any form whatsoever.
- (iv) The dust emissions from the construction site should be completely controlled and all precautions taken in that behalf.
- (v) The vehicles carrying construction material and construction debris of any kind should be cleaned before it is permitted to ply on the road after unloading of such material.
- (vi) Every worker working on the construction site and involved in loading, unloading and carriage of construction material and construction debris shall be provided with mask to prevent inhalation of dust particles.
- (vii) Every owner and or builder shall be under obligation to provide all medical help, investigation and treatment to the workers involved in the construction of building and carry of construction material and debris relating to dust emission.
- (viii) It shall be the responsibility of every owner/builder to transport construction material and debris waste to construction site, dumping site or any other place in accordance with rules and in terms of Hon'ble NGT order dated 10.04.2015 referred above.
- (ix) All to take appropriate measures and to ensure that the terms and conditions of the Hon'ble NGT order dated 10.04.2015 referred above in OA No. 21 of 2014 and the earlier orders passed in said case should strictly comply with by fixing sprinklers, creations of green air barriers.
- (x) Compulsory use of wet jet in grinding and stone cutting.
- (xi) Wind breaking walls around construction site.
- (xii) That you shall ensure that least dust has emitted into air/atmosphere and all steps are taken to prevent the same.
- (xiii) That all the builders, who are building commercial, residential complexes which are covered under the EIA Notification of 2006, shall provide green belt around the building that they construct and compliance of the same shall be

ensured prior to issuance of occupancy certificate. The width of green belt will be kept 1.5 meter along boundary wall within site, along periphery.

- (xiv) If any person, owner and or builder is found to be violating any of the conditions stated in this order and or for their non-compliance such person, owner, builder shall be liable to pay compensation of ₹ 50,000/- per default in relation to construction activity at its site and ₹ 5,000/- for each violation during carriage and transportation of construction material, debris through trucks or other vehicles, in terms of Section 15 of the NGT Act on the principle of Polluter Pay. Such action would be in addition not in derogation to the other action that the Authority made take against such builder, owner, person and transporter under the laws in force.
- (xv) All the owners/builders shall ensure that C & D waste is transported in terms of this order to the site in question only and due record in that behalf shall be maintained by the builders, transporters and NCR of Delhi.
- (xvi) It is made clear that even if constructions have been started after seeking Environmental Clearance under the EIA notification 2006 and after taking other travel but is being carried out without taking the preventive and protective environmental steps as stated in above said order dated 10.04.2015 passed by NGT and MOEF guidelines, 2010, the State Government, SPCB and any officer of any Department as afore-stated shall be entitled to direct stoppage of work.
18. As per the condition of the licence, you were required to convey ultimate power load requirement to the Department. The same may be supplied within a month from the issuance of this letter.
19. That you shall deposit the balance amount of Labour Cess in future, time to time as per progress in construction at site.
20. That the colonizer shall transfer the land forming part of sector road, service roads, green belts and 24/18 mtr. wide road as the case may be, shall be transferred within a period of 30 days, in favour of the Govt from the date of approval of building plan.

This sanction will be void abnatio, if any of the conditions mentioned above are not complied with.

DA/As above & One set of Building Plans.

H. Sharma.

(Hitesh Sharma)

Senior Town Planner (M)HQ

Member Secretary

For: Chief Town Planner, Haryana-cum-Chairman,
Building Plan Approval Committee,
Town & Country Planning Department,
Haryana, Chandigarh.

Endst. No. ZP-1629/PA(DK)/2022/_____ Dated:- _____

A copy is forwarded to the following for information:-

1. Haryana State Pollution Control Board, Panchkula with the request that the compliance of the instructions issued by NGT be monitored and strict compliance to be ensured.

2. MD, HVPNL, Planning Directorate, Shakti Bhawan, Sector-6, Panchkula with request to assess the power utility site requirement as per ultimate power load requirement.
3. Administrator, HSVP, Gurugram.
4. Senior Town Planner, Gurugram.
5. Superintending Engineer, Infra-I, GMDA.
6. District Town Planner, Gurugram along with one set of approved building plans.
7. District Town Planner (E), Gurugram.
8. Nodal Officer, website updation.
9. Deputy Director, Directorate Fire Service, Haryana, Panchkula.

Encl: as above

(Hitesh Sharma)
Senior Town Planner (M)HQ
Member Secretary
For: Chief Town Planner, Haryana-cum-Chairman,
Building Plan Approval Committee,
Town & Country Planning Department,
Haryana, Chandigarh.


GROSS - A									
1a	=	1	X	9.250	X	1.700	=	15.725	SQM
1b	=	1	X	0.650	X	3.300	=	2.145	SQM
1c	=	1	X	12.850	X	11.175	=	143.246	SQM
1d	=	1	X	13.825	X	12.600	=	174.305	SQM
1e	=	1	X	5.950	X	6.625	=	39.419	SQM
1f	=	1	X	3.650	X	4.375	=	15.959	SQM
1g	=	1	X	2.300	X	0.350	=	0.770	SQM
1h	=	1	X	0.650	X	1.050	=	0.683	SQM
1i	=	1	X	0.350	X	0.650	=	0.228	SQM
						TOTAL	=	415.309	SQM

FAR AREA OF STILT FLOOR		
	=	GROSS-A
	=	415.309
TOTAL	=	415.309

NON FARSTILT AREA (TOWER-15)		
	=	GROUND COVERAGE
	=	1241.725
TOTAL	=	826.416


NO OF CAR ACHEIVABLE OF (TOWER-15)		
	=	826.416
	=	28
OR SAY	=	30

SCHEDULE OF WORKS				
ITEM	DESCRIPTION	QUANTITY	UNIT	AMOUNT
01	CONCRETE WORK			
02	FORMWORK			
03	REINFORCEMENT			
04	PAINTING			
05	GLASS CURTAIN WALL			
06	MECHANICAL WORK			
07	ELECTRICAL WORK			
08	PLUMBING WORK			
09	LANDSCAPING			
10	FINISHES			
11	CONCRETE WORK			
12	FORMWORK			
13	REINFORCEMENT			
14	PAINTING			
15	GLASS CURTAIN WALL			
16	MECHANICAL WORK			
17	ELECTRICAL WORK			
18	PLUMBING WORK			
19	LANDSCAPING			
20	FINISHES			

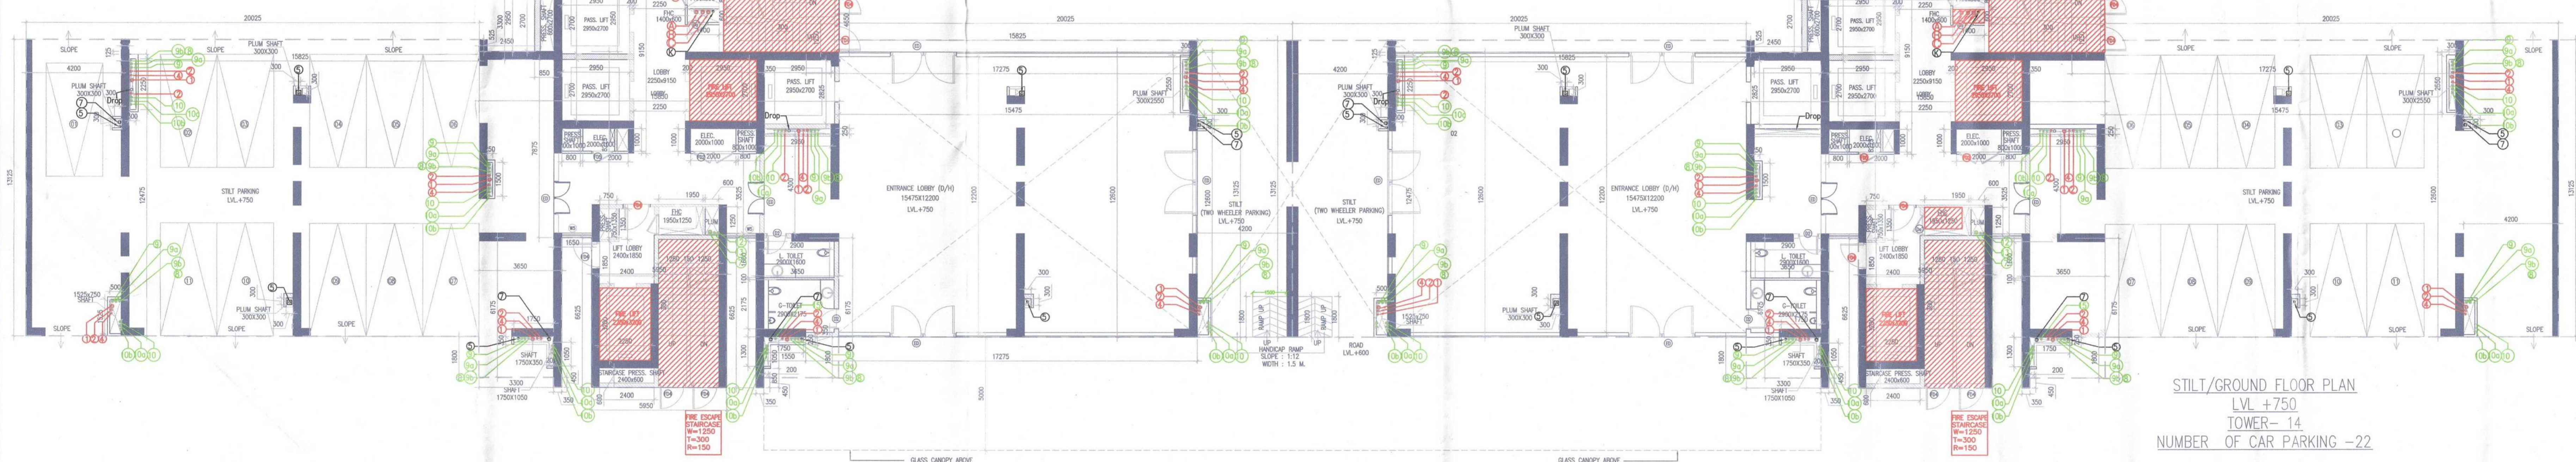


STILT/GROUND FLOOR PLAN
LVL +750
TOWER-15
NUMBER OF CAR PARKING -22

STILT/GROUND FLOOR PLAN
LVL +750
TOWER-14
NUMBER OF CAR PARKING -22

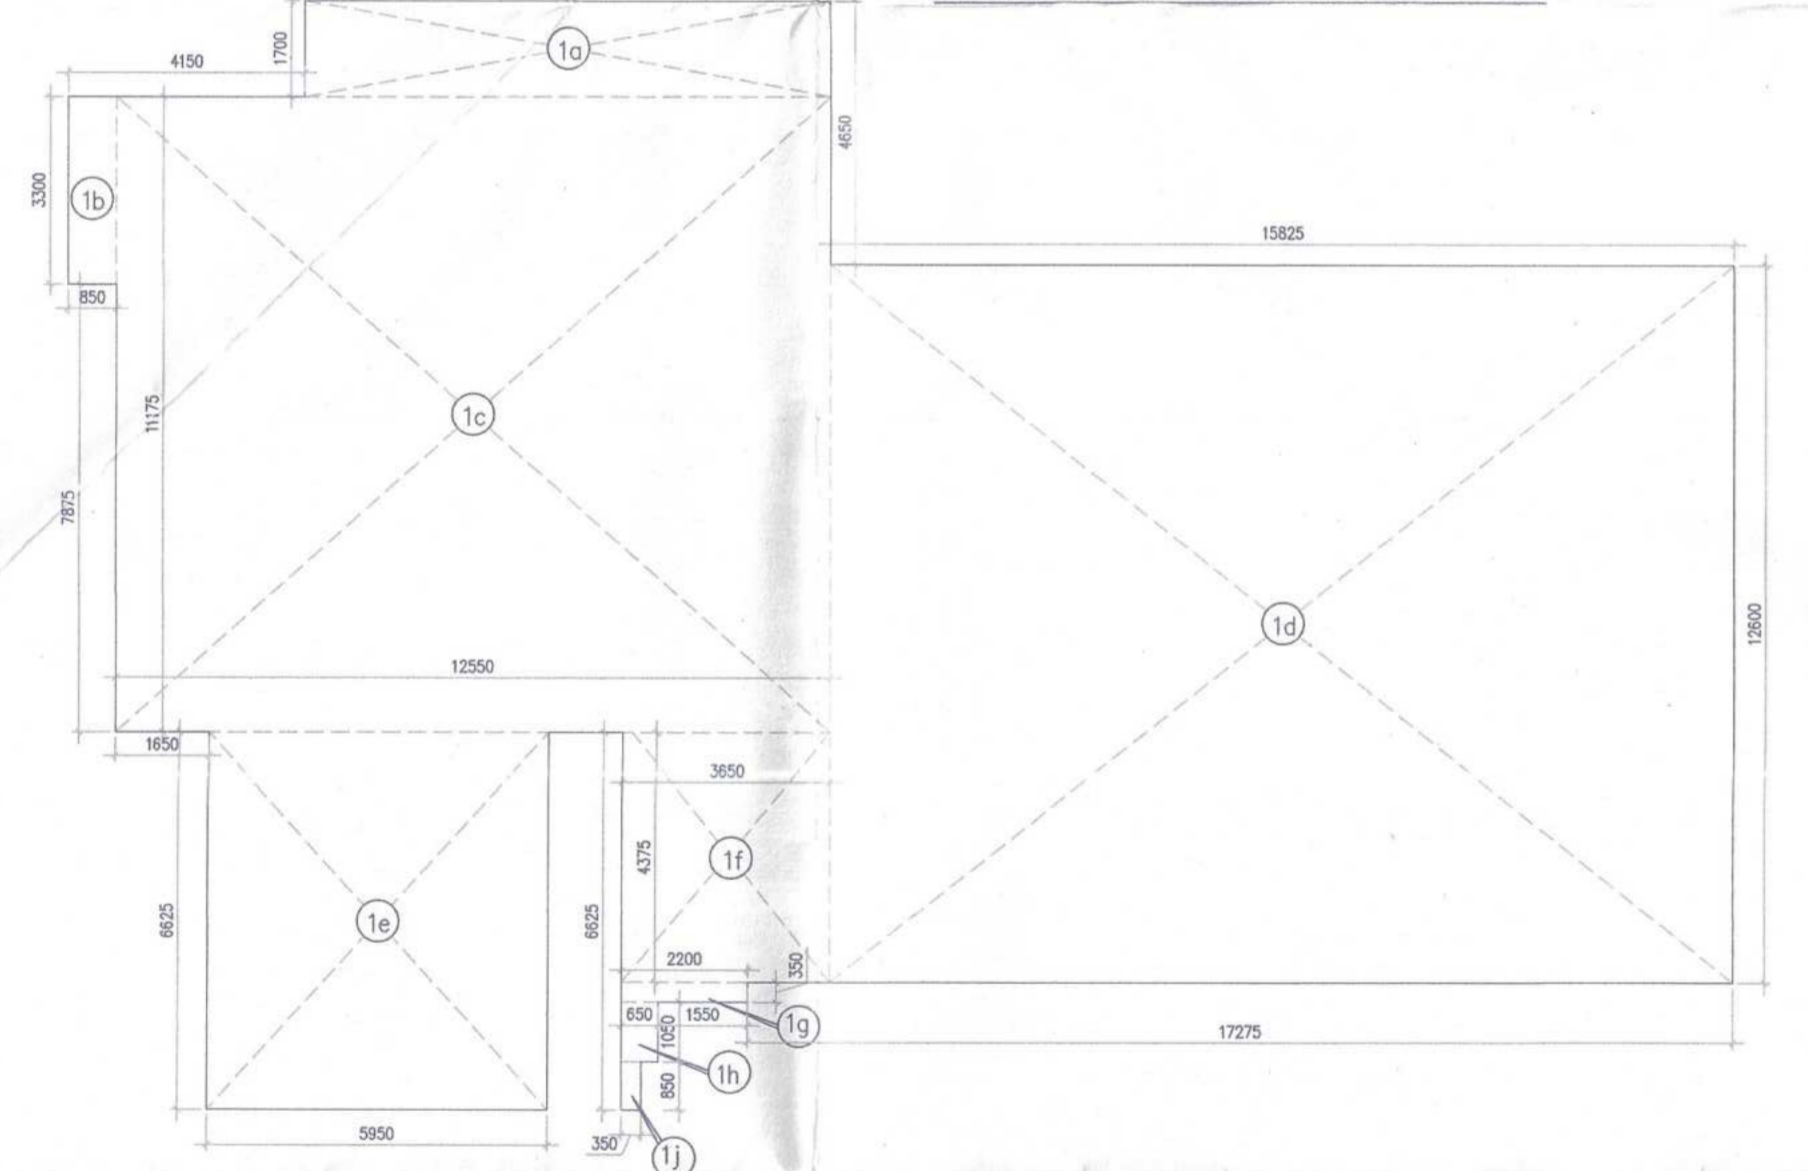

STILT FLOOR
TOWER-14 & 15

GROUND COVERAGE (TOWER-14 & 15)									
GROSS - A	=	2	X	20.025	X	13.125	=	525.656	SQM
1	=	2	X	3.650	X	6.175	=	45.078	SQM
2	=	2	X	0.350	X	0.450	=	0.315	SQM
3	=	1	X	5.950	X	6.625	=	39.419	SQM
4	=	1	X	15.850	X	8.225	=	130.366	SQM
5	=	1	X	13.400	X	2.950	=	39.530	SQM
6	=	1	X	0.425	X	1.700	=	0.723	SQM
7	=	1	X	8.900	X	4.635	=	41.252	SQM
8	=	1	X	5.575	X	3.300	=	18.398	SQM
9	=	1	X	1.8	X	0.350	=	0.630	SQM
10	=	1	X	13.125	X	22.875	=	300.234	SQM
11	=	1	X	20.025	X	5.000	=	100.125	SQM
12	=	1	X	20.025	X	5.000	=	100.125	SQM
						TOTAL	=	1241.725	SQM
GROUND COVERAGE						=	GROSS - A		
ADD REFUGE AREA (PROVIDED)						=	1241.725	SQM	
TOTAL GROUND COVERAGE						=	1291.440	SQM	

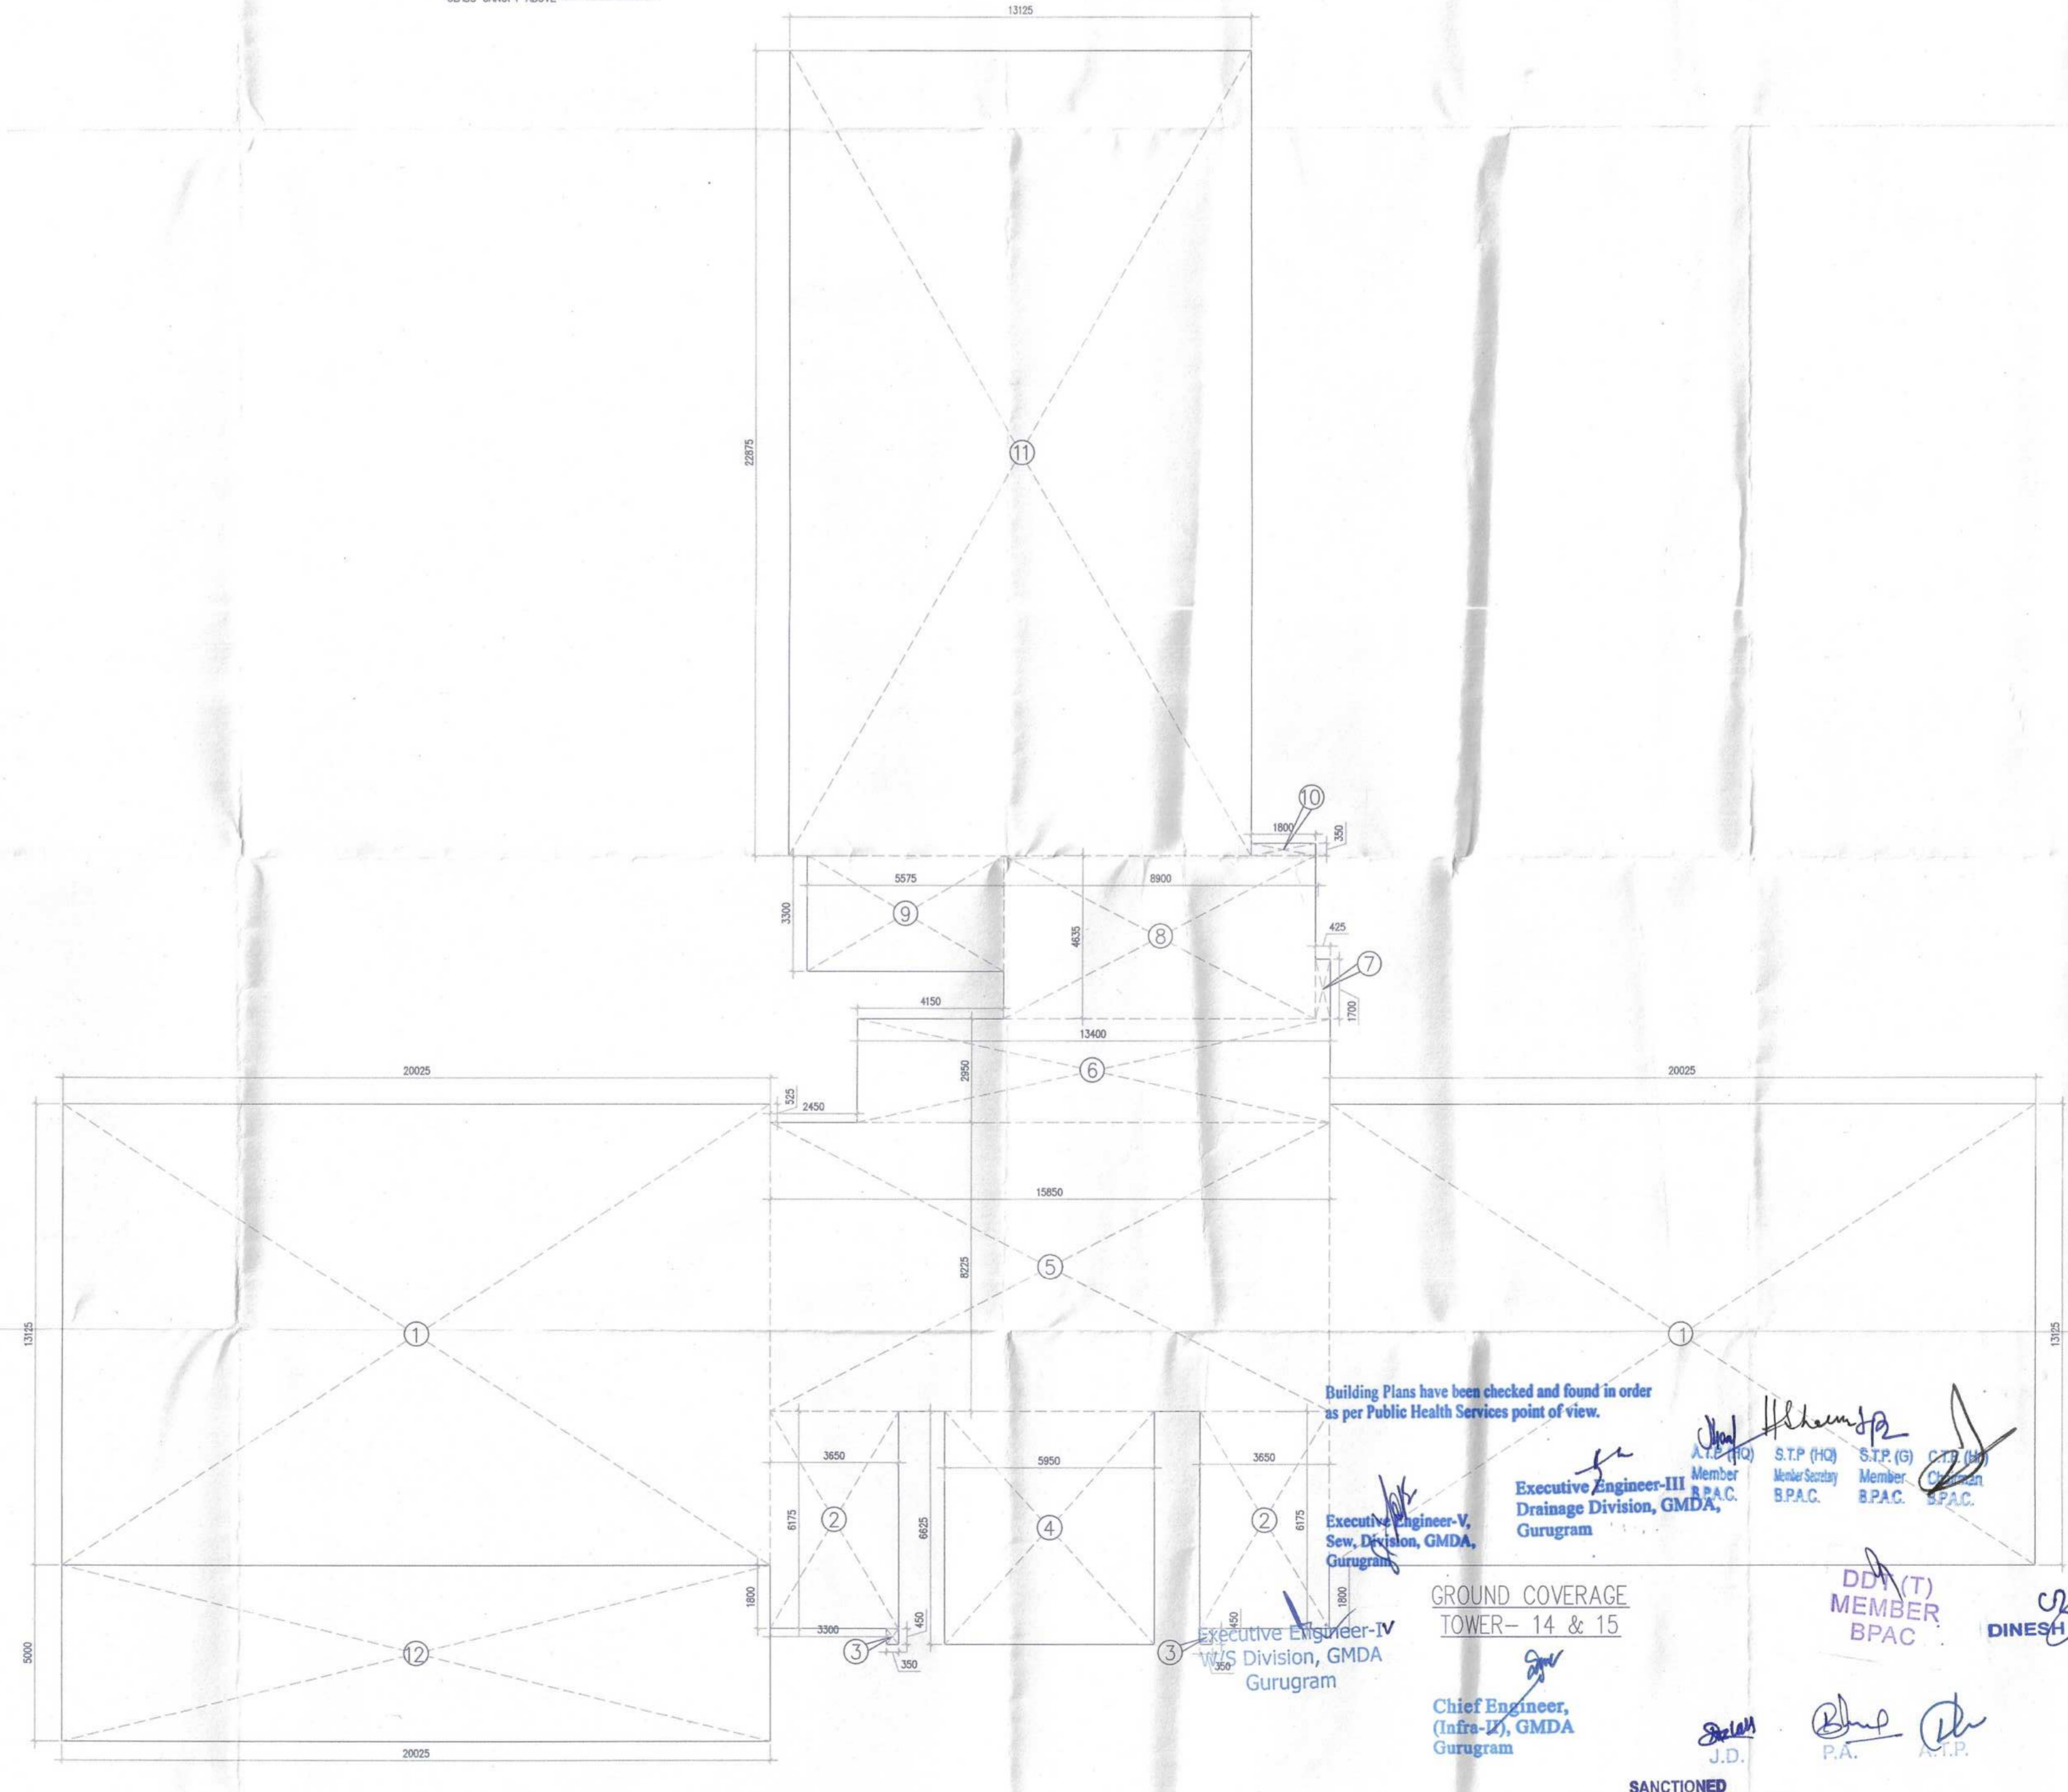

Building Plans have been checked and found in order as per Public Health Services point of view.

Executive Engineer-V, Sewerage, GMDA, Gurugram

Executive Engineer-III, Drainage Division, GMDA, Gurugram

Chief Engineer, (Infra-IV), GMDA, Gurugram

Sanctioned to be read with this office MEMO NO. DATE:

Scale: 1:100

Drawing Title: TOWER-14 & 15 STILT/GROUND FLOOR PLAN & FAR AREA CALCULATOR - DIAGRAM GROUND COVERAGE

- Note:
- BUILDING HAS AUTOMATIC SPRINKLER SYSTEM WHEREVER REQUIRED BY NBC.
 - BUILDING WILL BE DESIGNED (STRUCTURES) AS PER RELEVANT IS CODES FOR EARTH QUAKE RESISTANCE.
 - WC SHALL BE MECHANICALLY LIGHT & VENTILATED WHEREVER REQUIRED.

PROJECT:

PROPOSED BUILDING PLAN OF GROUP HOUSING COLONY MEASURING 24.10 ACRES (LICENCE NO BD OF 2012 DATED 17/08/2012) IN SECTOR 106, GURUGRAM MANESAR URBAN COMPLEX BEING DEVELOPED BY AIRMID DEVELOPERS LTD. & OTHERS.

OWNER'S SEAL & SIGNATURE

ARCHITECT'S SEAL & SIGNATURE

AUG-2022

Scale: 1:100

Drawing Title: TOWER-14 & 15 STILT/GROUND FLOOR PLAN & FAR AREA CALCULATOR - DIAGRAM GROUND COVERAGE

Drawing No: A-01

S.NO. PLUMBING LEGEND:-


1	SOL PIPE
2	WASTE PIPE
3	KITCHEN WASTE PIPE
4	VENT PIPE
5	BALCONY FAN WATER PIPE
6	RAIN WATER PIPE
7	RAIN WATER PIPE
8	DOMESTIC WATER SUPPLY (DISTRIBUTION) TO 15TH FLOOR
9	DOMESTIC LOW ZONE WATER SUPPLY (GRAVITY) GROUND TO 15TH FLOOR
10	DOMESTIC HIGH ZONE WATER SUPPLY (GRAVITY) 15TH TO 27TH FLOOR
11	DOMESTIC WATER SUPPLY (PRESSURE) D/W
12	FLUSHING LOW ZONE WATER SUPPLY (GRAVITY) GROUND TO 15TH FLOOR
13	FLUSHING HIGH ZONE WATER SUPPLY (GRAVITY) 15TH TO 27TH FLOOR
14	FLUSHING WATER SUPPLY (PRESSURE) D/W
15	DOMESTIC WATER SUPPLY RISER FOR O.H. TANK
16	FLUSHING WATER SUPPLY RISER FOR O.H. TANK
17	HVAC DRAIN PIPE

S.N. FIRE FIGHTING PIPE LEGEND:-


A	HYDRANT PIPE ZONE-1
B	HYDRANT PIPE ZONE-2
C	HYDRANT PIPE ZONE-3
D	SPRINKLER PIPE ZONE-1
E	SPRINKLER PIPE ZONE-2
F	SPRINKLER PIPE ZONE-3
G	SPRINKLER STAND BY PIPE ZONE-1
H	SPRINKLER STAND BY PIPE ZONE-2
I	SPRINKLER STAND BY PIPE ZONE-3
J	DRINK PIPE
K	FIRE HOSE CABINET

SCHEDULE OF DOORS & WINDOWS

NO.	REL.	LOCATION	DESCRIPTION	REL.	UNIT
01	200x200	W.C.	A.C. CLASS DOOR	---	---
02	150x200	W.C.	W.C. DOOR	---	---
03	200x200	W.C.	W.C. DOOR	---	---
04	200x200	W.C.	W.C. DOOR	---	---
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82	200x200	W.C.	W.C. DOOR	---	---
83	200x200	W.C.	W.C. DOOR	---	---
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88	200x200	W.C.	W.C. DOOR	---	---
89	200x200	W.C.	W.C. DOOR	---	---
90	200x200	W.C.	W.C. DOOR	---	---
91	200x200	W.C.	W.C. DOOR	---	---
92	200x200	W.C.	W.C. DOOR	---	---
93	200x200	W.C.	W.C. DOOR	---	---
94	200x200	W.C.	W.C. DOOR	---	---
95	200x200	W.C.	W.C. DOOR	---	---
96	200x200	W.C.	W.C. DOOR	---	---
97	200x200	W.C.	W.C. DOOR	---	---
98	200x200	W.C.	W.C. DOOR	---	---
99	200x200	W.C.	W.C. DOOR	---	---
100	200x200	W.C.	W.C. DOOR	---	---

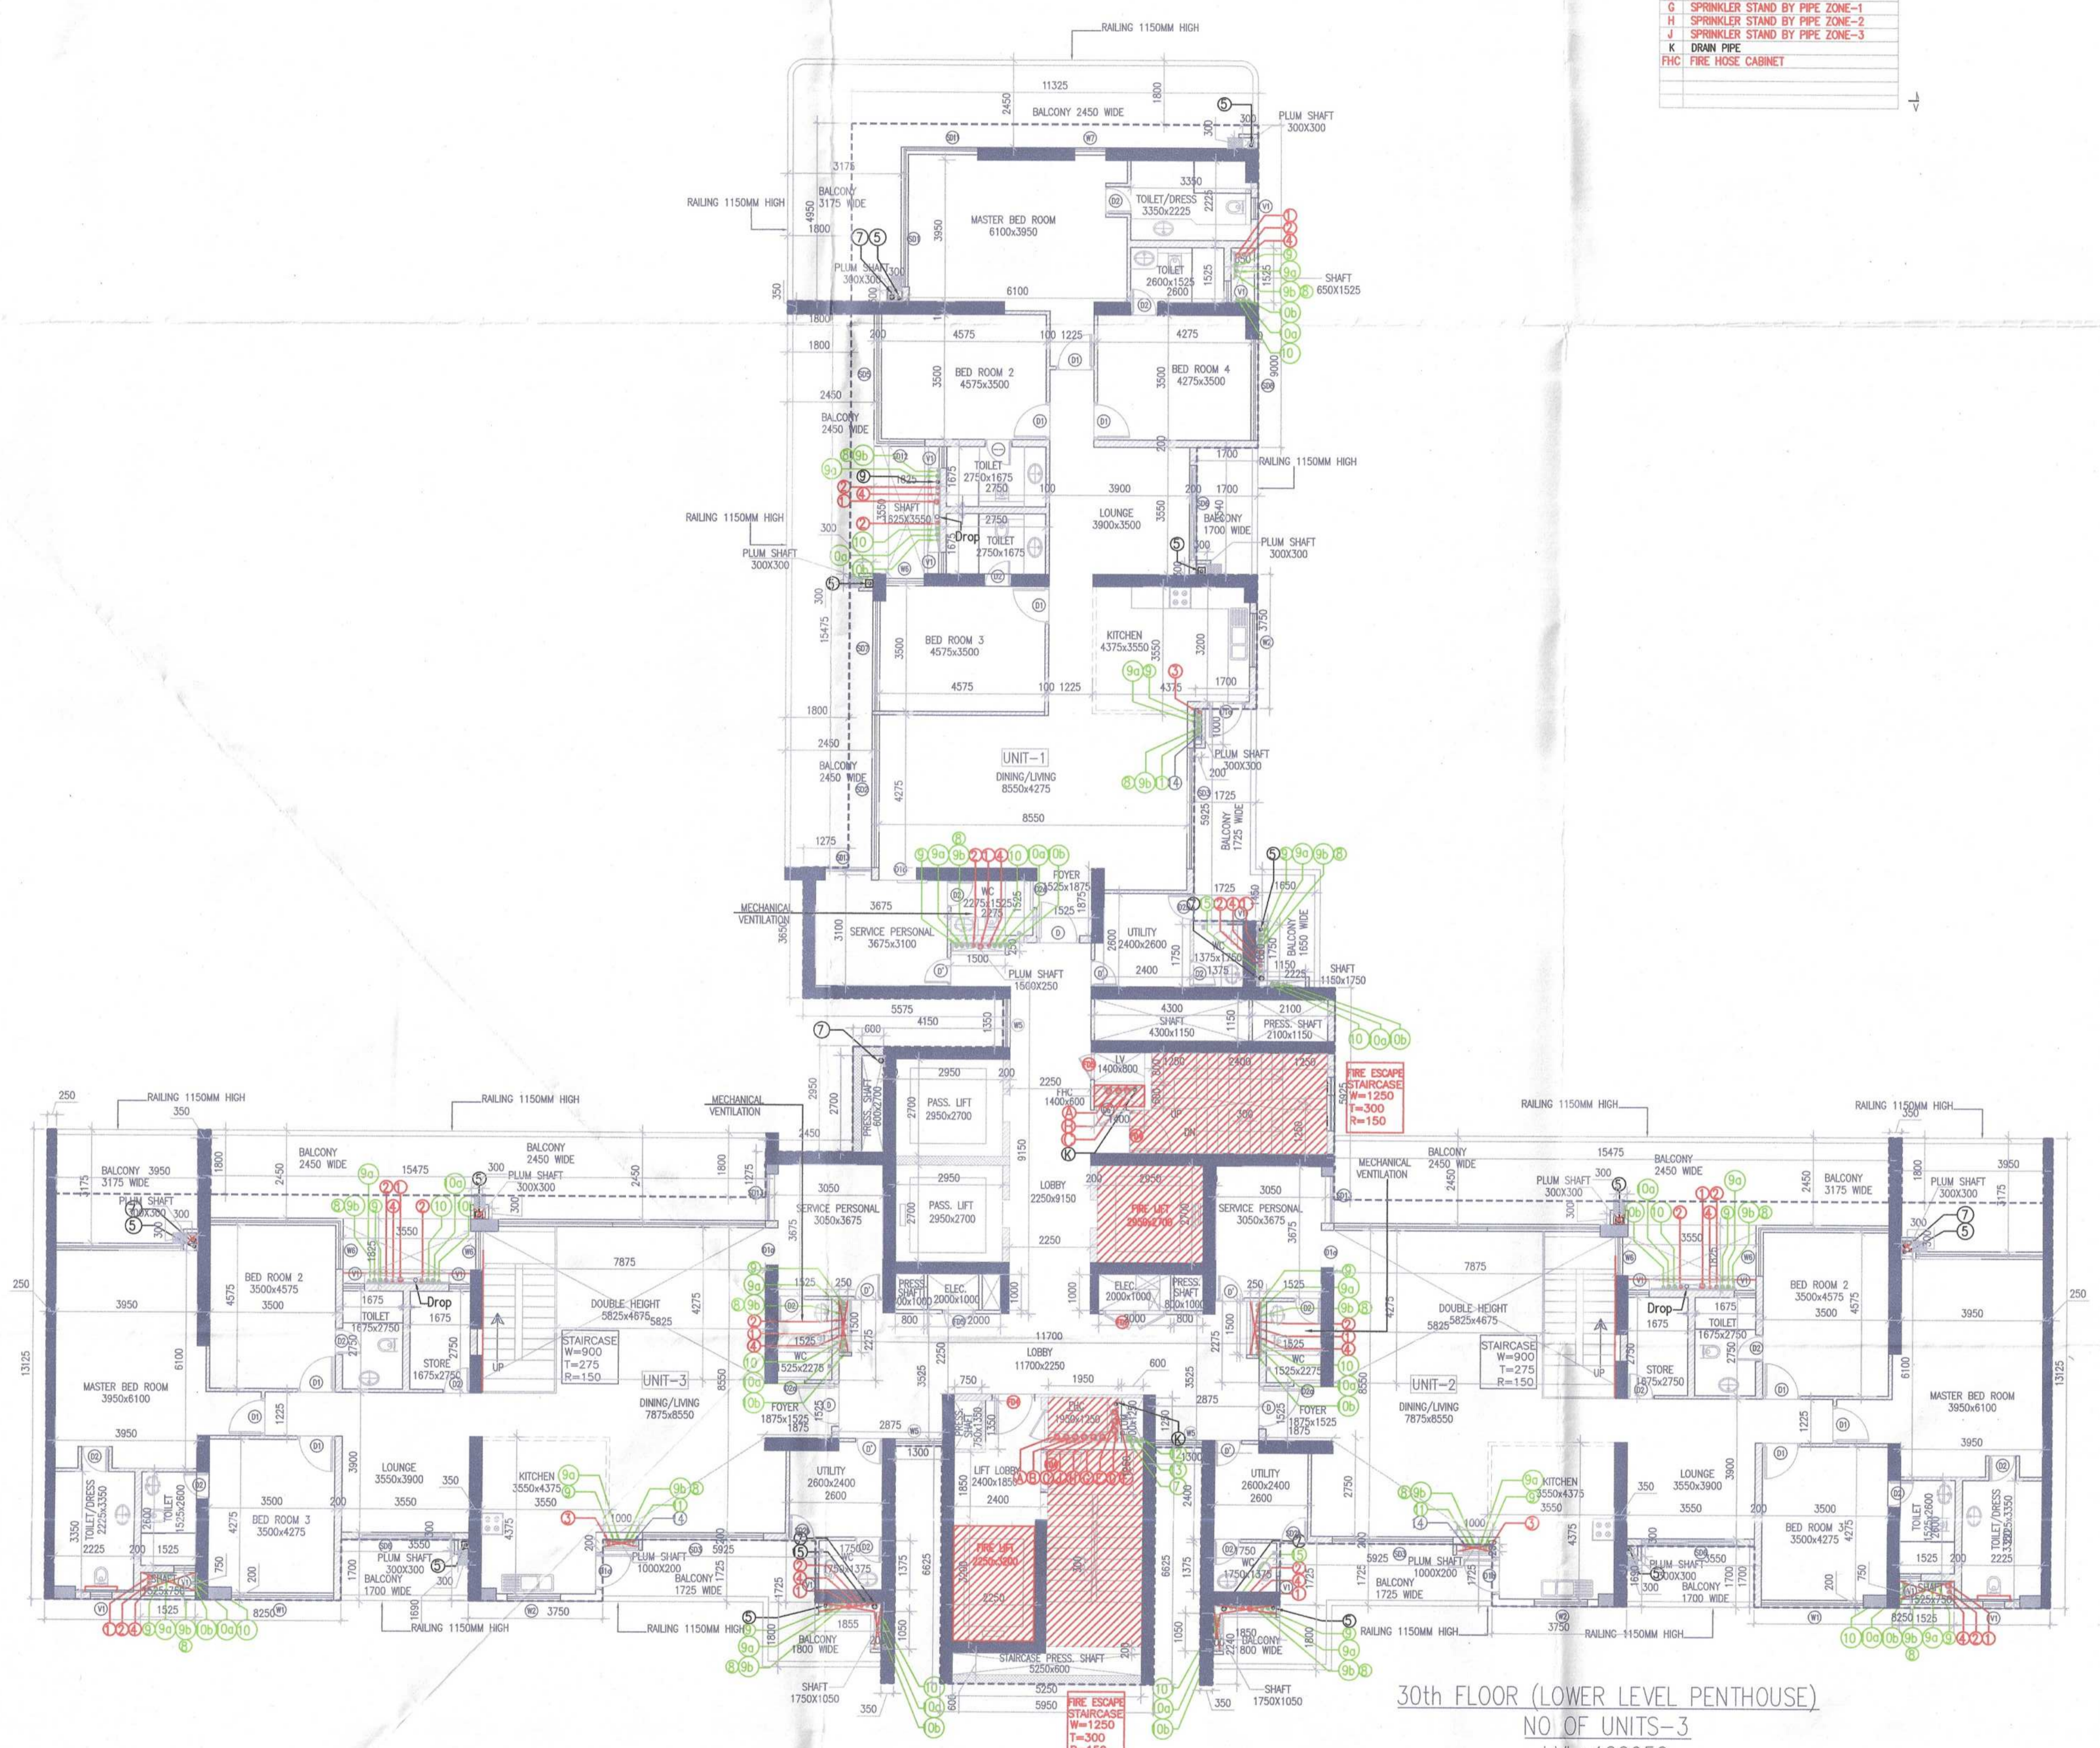

30th FLOOR (LOWER LEVEL PENTHOUSE)
NO. OF UNITS-3
LVL+100950
TOWER- 14 (4BHK)

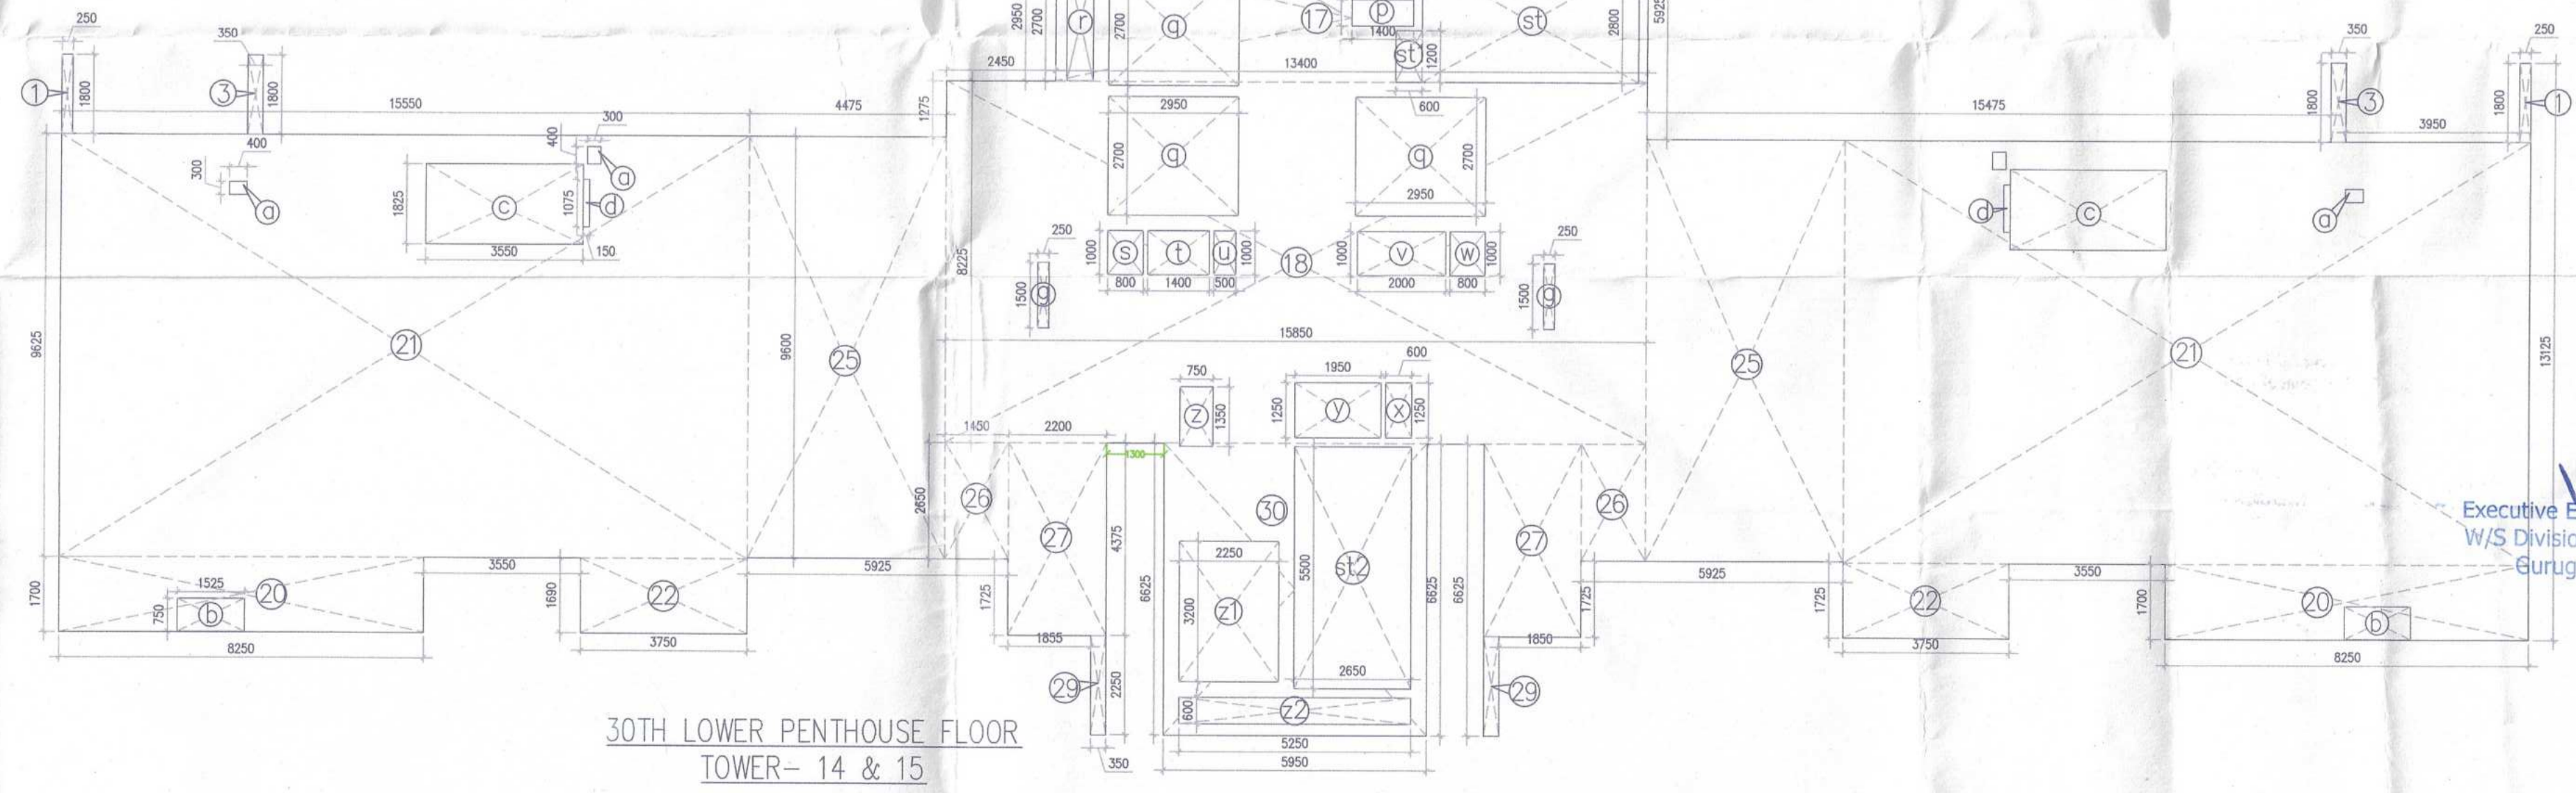

30TH LOWER PENTHOUSE FLOOR
TOWER- 14 & 15

TYPICAL 30TH FLOOR AREA CALCULATION

NO.	DESCRIPTION	AREA (SQM)	NO.	DESCRIPTION	AREA (SQM)
1	1	2	X	0.250	X 1.800 = 0.900
2	1	X	11.200	X 9.000	= 101.920
3	3	X	1.800	X 0.350	= 1.690
4	1	X	9.600	X 11.785	= 112.944
5	1	X	1.700	X 3.750	= 6.375
6	1	X	10.875	X 1.450	= 15.769
7	1	X	12.800	X 1.850	= 23.680
8	1	X	14.925	X 0.350	= 5.195
9	1	X	9.250	X 1.350	= 12.488
10	1	X	18.400	X 2.950	= 53.990
11	1	X	15.800	X 8.225	= 130.368
12	2	X	8.250	X 1.700	= 14.025
13	2	X	15.500	X 1.650	= 25.575
14	2	X	3.750	X 1.650	= 6.188
15	2	X	4.475	X 9.600	= 42.948
16	2	X	1.450	X 2.650	= 3.843
17	2	X	2.200	X 4.375	= 9.625
18	2	X	0.350	X 2.250	= 0.788
19	1	X	5.950	X 8.625	= 51.319
GROSS-A					TOTAL = 944.597 SQM
a	7	X	0.300	X 0.400	= 0.480
b	3	X	0.750	X 1.525	= 1.144
c	3	X	3.550	X 1.625	= 5.773
d	8	X	1.075	X 0.150	= 0.161
e	8	X	1.500	X 0.250	= 0.375
f	1	X	2.100	X 1.150	= 2.415
g	1	X	4.300	X 1.150	= 4.945
h	1	X	1.400	X 0.800	= 1.120
i	1	X	1.400	X 0.800	= 1.120
j	3	X	2.950	X 2.700	= 7.965
k	1	X	0.800	X 2.700	= 2.160
l	1	X	0.800	X 1.000	= 0.800
m	1	X	1.400	X 1.000	= 1.400
n	1	X	0.500	X 1.500	= 0.750
o	1	X	0.800	X 1.000	= 0.800
p	1	X	1.250	X 1.250	= 1.563
q	1	X	1.950	X 1.250	= 2.438
r	1	X	0.750	X 1.350	= 1.013
s	1	X	2.250	X 3.200	= 7.200
t	1	X	5.250	X 0.600	= 3.150
GROSS-B					TOTAL = 80.201 SQM
u1	1	X	4.800	X 2.300	= 11.040
u2	1	X	0.600	X 1.200	= 0.720
u3	1	X	2.650	X 5.500	= 14.575
GROSS-C					TOTAL = 29.015 SQM
FAR AREA OF 2ND TO 31ST FLOOR					GROSS-A - GROSS-B - GROSS-C = 835.380 SQM
BUILT-UP AREA OF 2ND TO 31ST FLOOR					GROSS-D + GROSS-C = 835.380 SQM + 29.015 SQM = 864.395 SQM

Sanctioned
MEMO NO. 100950
DATED: 17/08/2012

Member
S.P.C. #9/C

Member
S.P.C. #9/C

Member
S.P.C. #9/C

Sanctioned
MEMO NO. 100950
DATED: 17/08/2012

Member
S.P.C. #9/C

Member
S.P.C. #9/C

Member
S.P.C. #9/C

Building Plan has been checked and found in order as per Public Health Services point of view.

Executive Engineer-IV
W/S Division, GMDA
Gurgaon

Executive Engineer-III
Design Division, GMDA
Gurgaon

Chief Engineer,
(In-charge), GMDA
Gurgaon

Note:-

- BUILDING HAS AUTOMATIC SPRINKLER SYSTEM WHEREVER REQUIRED BY NBC
- BUILDING WILL BE DESIGNED (STRUCTURES) AS PER RELEVANT IS CODES FOR EARTHQUAKE RESISTANCE
- WC SHALL BE MECHANICALLY LIGHT & VENTILATED WHEREVER REQUIRED.

PROJECT: PROPOSED BUILDING PLAN OF GROUP HOUSING COLONY MEASURING 24.10 ACRES (LICENCE NO. 80 OF 2012 DATED 17/08/2012) IN SECTOR 106, GURUGRAM MANESAR URBAN COMPLEX BEING DEVELOPED BY ARIMID DEVELOPERS LTD. & OTHERS.

OWNER'S SEAL & SIGNATURE: Arimid Developer Ltd.


ARCHITECT'S SEAL & SIGNATURE: Avinash Chandra Vaidya, Architect No. CA/75/02006, H. No. 163, PH-II, New Palam Vihar, Gurgaon

AUG.-2022. Scale: 1:100. Drawing No.: TOWER-14 30th FLOOR PLAN 1:100 AREA CALCULATION DIAGRAM A-04



31st FLOOR (UPPER LEVEL PENTHOUSE)
NO. OF UNITS-1
LVL+104250
TOWER- 14 (4BHK)

31ST FLOOR UPPER PENTHOUSE AREA CALCULATION											
GROSS - A											
2	=	1	X	11.325	X	9.000	=	101.925	SGM		
3	=	1	X	1.800	X	0.350	=	0.630	SGM		
4	=	1	X	9.600	X	11.765	=	112.848	SGM		
8	=	1	X	1.700	X	3.750	=	6.375	SGM		
12	=	1	X	10.875	X	1.450	=	15.769	SGM		
13	=	1	X	12.800	X	1.850	=	23.680	SGM		
15	=	1	X	14.825	X	0.350	=	5.189	SGM		
16	=	1	X	9.250	X	1.350	=	12.488	SGM		
17	=	1	X	13.400	X	2.950	=	39.530	SGM		
18	=	1	X	15.850	X	8.225	=	130.365	SGM		
19	=	2	X	14.825	X	8.950	=	265.368	SGM		
20	=	2	X	(7.950+8.950)	X	1.000	X	0.5	=	14.900	SGM
21	=	2	X	1.000	X	1.000	X	0.5	=	1.000	SGM
24	=	2	X	1.450	X	2.650	=	7.695	SGM		
25	=	2	X	2.200	X	4.375	=	19.250	SGM		
27	=	2	X	0.350	X	2.250	=	1.575	SGM		
28	=	1	X	5.950	X	6.625	=	39.413	SGM		
TOTAL								797.722	SGM		
GROSS - C											
a	=	3	X	0.300	X	0.400	=	0.360	SGM		
b	=	1	X	0.750	X	1.525	=	1.144	SGM		
c	=	1	X	1.825	X	3.550	=	6.479	SGM		
d	=	3	X	1.075	X	0.150	=	0.494	SGM		
d1	=	2	X	0.300	X	1.450	=	0.870	SGM		
g	=	3	X	0.250	X	1.500	=	1.125	SGM		
k	=	1	X	2.100	X	1.150	=	2.415	SGM		
m	=	1	X	4.300	X	0.650	=	2.795	SGM		
n	=	1	X	1.400	X	0.800	=	1.120	SGM		
p	=	1	X	1.400	X	0.800	=	0.840	SGM		
q	=	3	X	2.950	X	2.700	=	23.855	SGM		
r	=	1	X	0.900	X	2.700	=	1.620	SGM		
s	=	1	X	0.600	X	1.000	=	0.800	SGM		
t	=	1	X	1.400	X	1.000	=	1.400	SGM		
u	=	1	X	0.500	X	1.000	=	0.500	SGM		
v	=	1	X	2.000	X	1.000	=	2.000	SGM		
w	=	1	X	0.800	X	1.000	=	0.800	SGM		
x	=	1	X	0.600	X	1.250	=	0.750	SGM		
y	=	1	X	1.950	X	1.250	=	2.438	SGM		
z	=	1	X	0.750	X	1.350	=	1.013	SGM		
z1	=	1	X	2.250	X	3.200	=	7.200	SGM		
z2	=	1	X	5.250	X	0.800	=	3.150	SGM		
z3	=	2	X	7.875	X	4.275	=	67.331	SGM		
TOTAL								130.528	SGM		
GROSS - D											
st	=	1	X	4.800	X	2.800	=	13.720	SGM		
st1	=	1	X	0.600	X	1.200	=	0.720	SGM		
st2	=	1	X	2.650	X	5.500	=	14.575	SGM		
TOTAL								29.015	SGM		
FAR AREA OF 31ST FLOOR UPPER PENTHOUSE											
				=	GROSS-A	+	GROSS-B	-	GROSS-C	-	GROSS-D
				=	797.722	+	1.131	-	130.528	-	29.015
				TOTAL	=	639.310	SGM				
BUILT-UP AREA OF 31ST FLOOR UPPER PENTHOUSE											
				=	GROSS-E	+	GROSS-C				
				=	639.310	+	29.015				
				TOTAL	=	668.325	SGM				

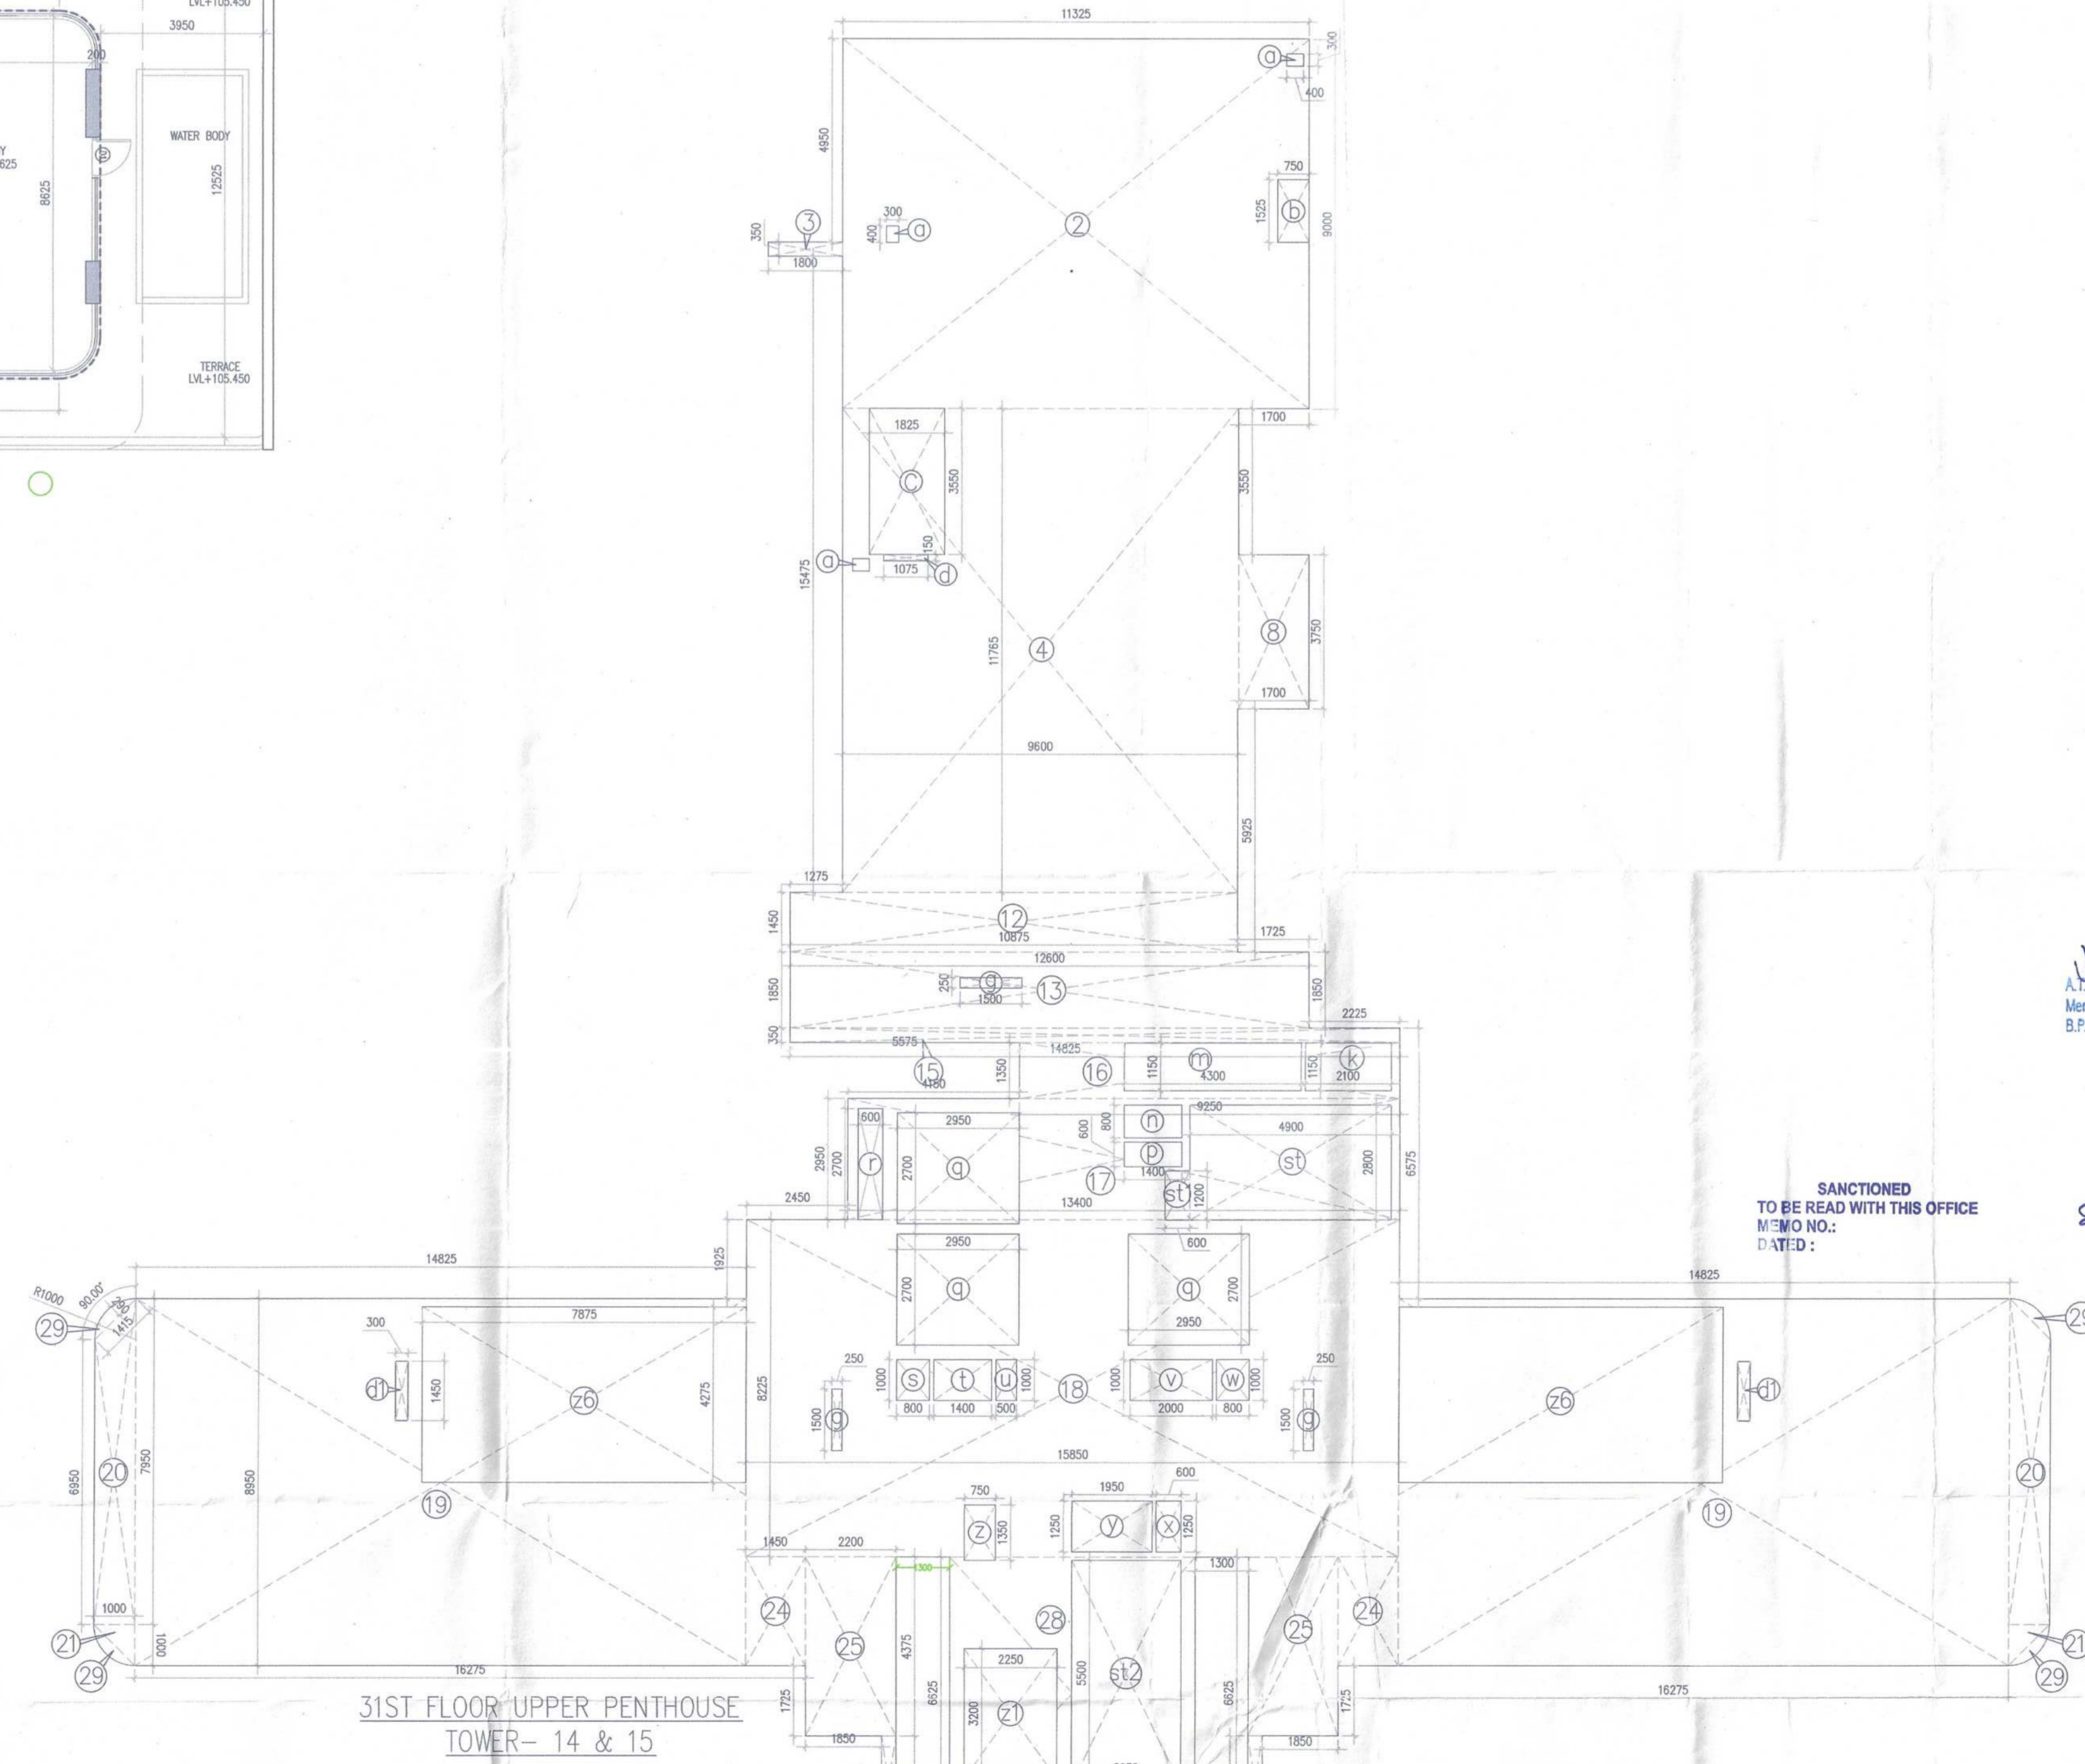

31ST FLOOR UPPER PENTHOUSE
TOWER- 14 & 15

Sanctioned to be read with this office M/W No. / D/T/D:

Executive Engineer-IV
W/S Division, GMDA
Gurgaon

Executive Engineer-III
Drainage Division, GMDA
Gurgaon

Chief Engineer,
(In-charge), GMDA
Gurgaon

DDTN MEMBER
BPAC

DINESH KUMAR
PA(HQ)

Building Plans have been checked and found in order as per Public Health Services point of view.

Architect's Seal & Signature: **AVRASH CHANDRA VAIDYA**
Architect No. CA7502006
H No. 163, Ph...

Note:-

- BUILDING HAS AUTOMATIC SPRINKLER SYSTEM WHEREVER REQUIRED BY NBC.
- BUILDING WILL BE DESIGNED (STRUCTURES) AS PER RELEVANT IS CODES FOR EARTH QUAKE RESISTANCE.
- WC SHALL BE MECHANICALLY LIGHT & VENTILATED WHEREVER REQUIRED.

PROJECT:

PROPOSED BUILDING PLAN OF GROUP HOUSING COLONY MEASURING 24.10 ACRES (LICENCE NO 80 OF 2012 DATED 17/08/2012) IN SECTOR 106, GURUGRAM MANESAR URBAN COMPLEX BEING DEVELOPED BY AIRMD DEVELOPERS LTD. & OTHERS.

OWNER'S SEAL & SIGNATURE

Architect's Seal & Signature

AUG.-2022. Scale : 1:100
Drawing Title:- TOWER-14 31ST FLOOR PLAN FAR AREA CALCULATION - DIAGRAM
Drawing No:- A-08



31ST FLOOR (UPPER LEVEL PENTHOUSE)
NO. OF UNITS-1
LVI-104250
TOWER-14 & 15 (4BHK)

31ST FLOOR UPPER PENTHOUSE AREA CALCULATION											
GROSS - A											
2	=	1	X	11.325	X	8.600	=	101.825	SQM		
3	=	1	X	1.800	X	0.350	=	0.630	SQM		
4	=	1	X	9.600	X	11.765	=	112.944	SQM		
8	=	1	X	1.700	X	3.750	=	6.375	SQM		
12	=	1	X	10.875	X	1.450	=	15.769	SQM		
13	=	1	X	12.600	X	1.850	=	23.310	SQM		
16	=	1	X	14.825	X	0.350	=	5.189	SQM		
18	=	1	X	9.250	X	1.350	=	12.488	SQM		
17	=	1	X	13.400	X	2.950	=	39.530	SQM		
18	=	1	X	15.850	X	8.225	=	130.368	SQM		
19	=	2	X	14.825	X	8.950	=	265.368	SQM		
20	=	2	X	(7.950+8.950)	X	1.000	X	0.5	=	14.900	SQM
21	=	2	X	1.000	X	1.000	X	0.5	=	1.000	SQM
24	=	2	X	1.450	X	2.650	=	7.685	SQM		
25	=	2	X	3.200	X	4.375	=	19.250	SQM		
27	=	2	X	0.350	X	2.250	=	1.575	SQM		
28	=	1	X	5.950	X	6.625	=	39.419	SQM		
TOTAL								787.722	SQM		
GROSS - C											
a	=	3	X	0.300	X	0.400	=	0.360	SQM		
b	=	1	X	0.750	X	1.525	=	1.144	SQM		
c	=	1	X	1.825	X	3.650	=	6.679	SQM		
d	=	3	X	1.075	X	0.150	=	0.484	SQM		
d1	=	2	X	0.300	X	1.450	=	0.870	SQM		
g	=	3	X	0.250	X	1.500	=	1.125	SQM		
k	=	1	X	2.100	X	1.150	=	2.415	SQM		
m	=	1	X	4.300	X	0.650	=	2.795	SQM		
n	=	1	X	1.400	X	0.800	=	1.120	SQM		
p	=	1	X	1.400	X	0.500	=	0.940	SQM		
q	=	3	X	2.950	X	2.700	=	23.895	SQM		
r	=	1	X	0.600	X	2.700	=	1.620	SQM		
s	=	1	X	0.900	X	1.000	=	0.900	SQM		
t	=	1	X	1.600	X	1.000	=	1.600	SQM		
u	=	1	X	0.500	X	1.000	=	0.500	SQM		
v	=	1	X	2.000	X	1.000	=	2.000	SQM		
w	=	1	X	0.800	X	1.000	=	0.800	SQM		
x	=	1	X	0.600	X	1.250	=	0.750	SQM		
y	=	1	X	1.950	X	1.250	=	2.438	SQM		
z	=	1	X	0.750	X	1.350	=	1.013	SQM		
z1	=	1	X	2.250	X	3.200	=	7.200	SQM		
z2	=	1	X	5.250	X	0.600	=	3.150	SQM		
z8	=	2	X	7.875	X	4.275	=	67.331	SQM		
TOTAL								130.628	SQM		
GROSS - D											
st	=	1	X	4.900	X	2.800	=	13.720	SQM		
st1	=	1	X	0.600	X	1.200	=	0.720	SQM		
st2	=	1	X	2.650	X	5.500	=	14.575	SQM		
TOTAL								29.015	SQM		
FAR AREA OF 31ST FLOOR UPPER PENTHOUSE											
				=	GROSS-A	+	GROSS-B	-	GROSS-C	-	GROSS-D
				=	787.722	+	1.131	-	130.628	-	29.015
				TOTAL	=	639.310	SQM				
BUILT-UP AREA OF 31ST FLOOR UPPER PENTHOUSE											
				=	GROSS-E	+	GROSS-C				
				=	639.310	+	29.015				
				TOTAL	=	668.325	SQM				



31ST FLOOR UPPER PENTHOUSE
TOWER-14 & 15

TO BE SANCTIONED
MEMO NO. :
DATED :

(Signature)
S.T.P. (P)
S.T.P. (S)
B.P.A.C. B.P.A.C. B.P.A.C.

(Signature)
DINESH KUMAR
PA(HQ)

(Signature)
D.D. (T)
MEMBER
B.P.A.C.

(Signature)
J.D. P.A. A.T.P.

Executive Engineer - IV
W/S Division, GMDA,
Gurgaon

Executive Engineer - V
Division, GMDA,
Gurgaon

Executive Engineer - III
Drainage Division, GMDA,
Gurgaon

Building Plan have been checked and found in order
in per Public Health Services point of view.

(Signature)
Chief Engineer,
(T-11), GMDA,
Gurgaon

- Note :-
- BUILDING HAS AUTOMATIC SPRINKLER SYSTEM WHEREVER REQUIRED BY NBC.
 - BUILDING WILL BE DESIGNED (STRUCTURES) AS PER RELEVANT IS CODES FOR EARTH QUAKE RESISTANCE.
 - WC SHALL BE MECHANICALLY LIGHT & VENTILATED WHEREVER REQUIRED

PROJECT:
PROPOSED BUILDING PLAN OF GROUP HOUSING COLONY
MEASURING 24.10 ACRES (LICENCE NO 80 OF
2012 DATED 17/08/2012)
IN SECTOR 106, GURUGRAM MANESAR URBAN
COMPLEX BEING DEVELOPED BY AIRMID
DEVELOPERS LTD. & OTHERS.

OWNER'S SEAL
& SIGNATURE

Airmid Developers Limited
Authorised Signatory

ARCHITECT'S SEAL
& SIGNATURE

(Signature)
AVINASH CHANDRA VAIDYA
Architect No. CA/76/2006
H. No. 163, PH-II
New Patahar, Gurgaon

AUG.-2022. Scale : 1:300


Drawing Title:-
TOWER-15
31ST FLOOR PLAN
& FAR AREA
CALCULATION - DIAGRAM

Drawing No:-
A-05a




32nd FLOOR
NO. OF UNITS-1
LVL+107550
TOWER- 14, (4BHK)


32ND FLOOR AREA CALCULATION							
GROSS - A							
2	=	1	X	11.325	X 9.000 = 101.925 SQM		
3	=	1	X	1.800	X 0.350 = 0.630 SQM		
4	=	1	X	9.600	X 11.765 = 112.944 SQM		
8	=	1	X	1.700	X 3.750 = 6.375 SQM		
12	=	1	X	10.875	X 1.450 = 15.769 SQM		
13	=	1	X	12.600	X 1.850 = 23.310 SQM		
15	=	1	X	14.825	X 0.350 = 5.189 SQM		
16	=	1	X	9.250	X 1.350 = 12.488 SQM		
17	=	1	X	13.400	X 3.300 = 44.220 SQM		
18	=	1	X	9.250	X 4.150 = 38.388 SQM		
19	=	1	X	8.950	X 3.725 = 33.339 SQM		
20	=	1	X	5.950	X 6.625 = 39.419 SQM		
				TOTAL	= 433.994 SQM		
GROSS - B							
a	=	3	X	0.300	X 0.400 = 0.360 SQM		
b	=	1	X	0.750	X 1.525 = 1.144 SQM		
c	=	1	X	1.825	X 3.550 = 6.479 SQM		
d	=	1	X	1.075	X 0.150 = 0.161 SQM		
g	=	1	X	1.500	X 0.250 = 0.375 SQM		
k	=	1	X	2.100	X 1.150 = 2.415 SQM		
m	=	1	X	4.300	X 1.150 = 4.945 SQM		
n	=	1	X	1.400	X 0.800 = 1.120 SQM		
p	=	1	X	1.400	X 0.600 = 0.840 SQM		
q	=	3	X	2.950	X 2.700 = 23.895 SQM		
r	=	1	X	0.600	X 2.700 = 1.620 SQM		
s	=	1	X	0.800	X 1.000 = 0.800 SQM		
t	=	1	X	1.400	X 1.000 = 1.400 SQM		
u	=	1	X	0.500	X 1.000 = 0.500 SQM		
v	=	1	X	2.000	X 1.000 = 2.000 SQM		
w	=	1	X	0.800	X 1.000 = 0.800 SQM		
x	=	1	X	0.600	X 1.250 = 0.750 SQM		
y	=	1	X	1.950	X 1.250 = 2.438 SQM		
z	=	1	X	0.750	X 1.350 = 1.013 SQM		
z1	=	1	X	2.250	X 3.200 = 7.200 SQM		
z2	=	1	X	5.250	X 0.600 = 3.150 SQM		
				TOTAL	= 63.404 SQM		
GROSS - C							
st	=	1	X	4.900	X 2.800 = 13.720 SQM		
st1	=	1	X	0.800	X 1.200 = 0.720 SQM		
st2	=	1	X	2.650	X 5.500 = 14.575 SQM		
				TOTAL	= 29.015 SQM		
FAR AREA OF 32NDFLOOR		=	GROSS-A	-	GROSS-B	-	GROSS-C
		=	433.994	-	63.404	-	29.015
TOTAL		=	341.575	SQM	GROSS-D	-	
BUILT-UP AREA OF 32ND FLOOR		=	GROSS-D	+	GROSS-C		
		=	341.575	+	29.015		
TOTAL		=	370.590	SQM			

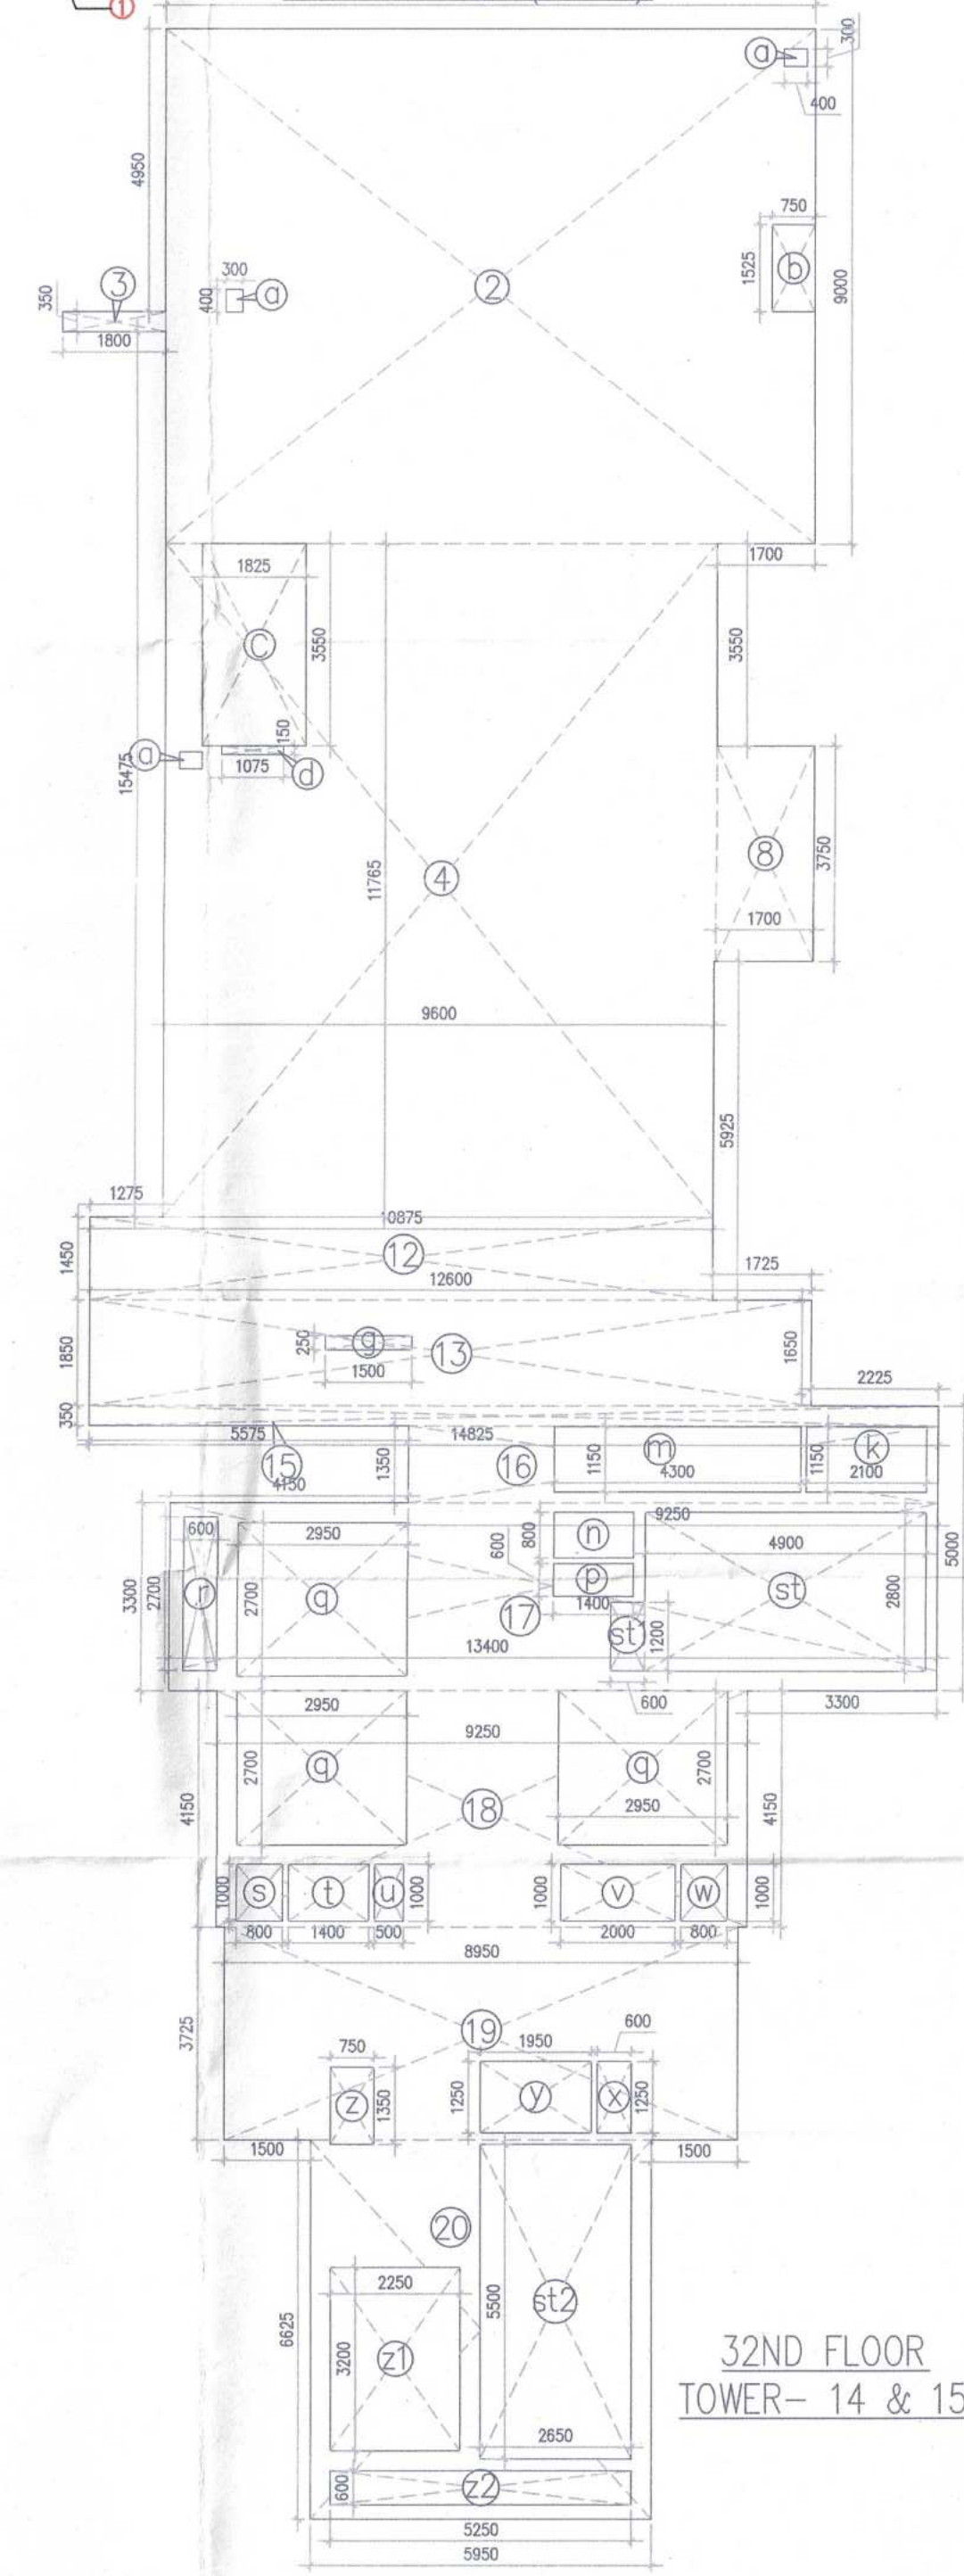


32ND FLOOR
TOWER- 14 & 15

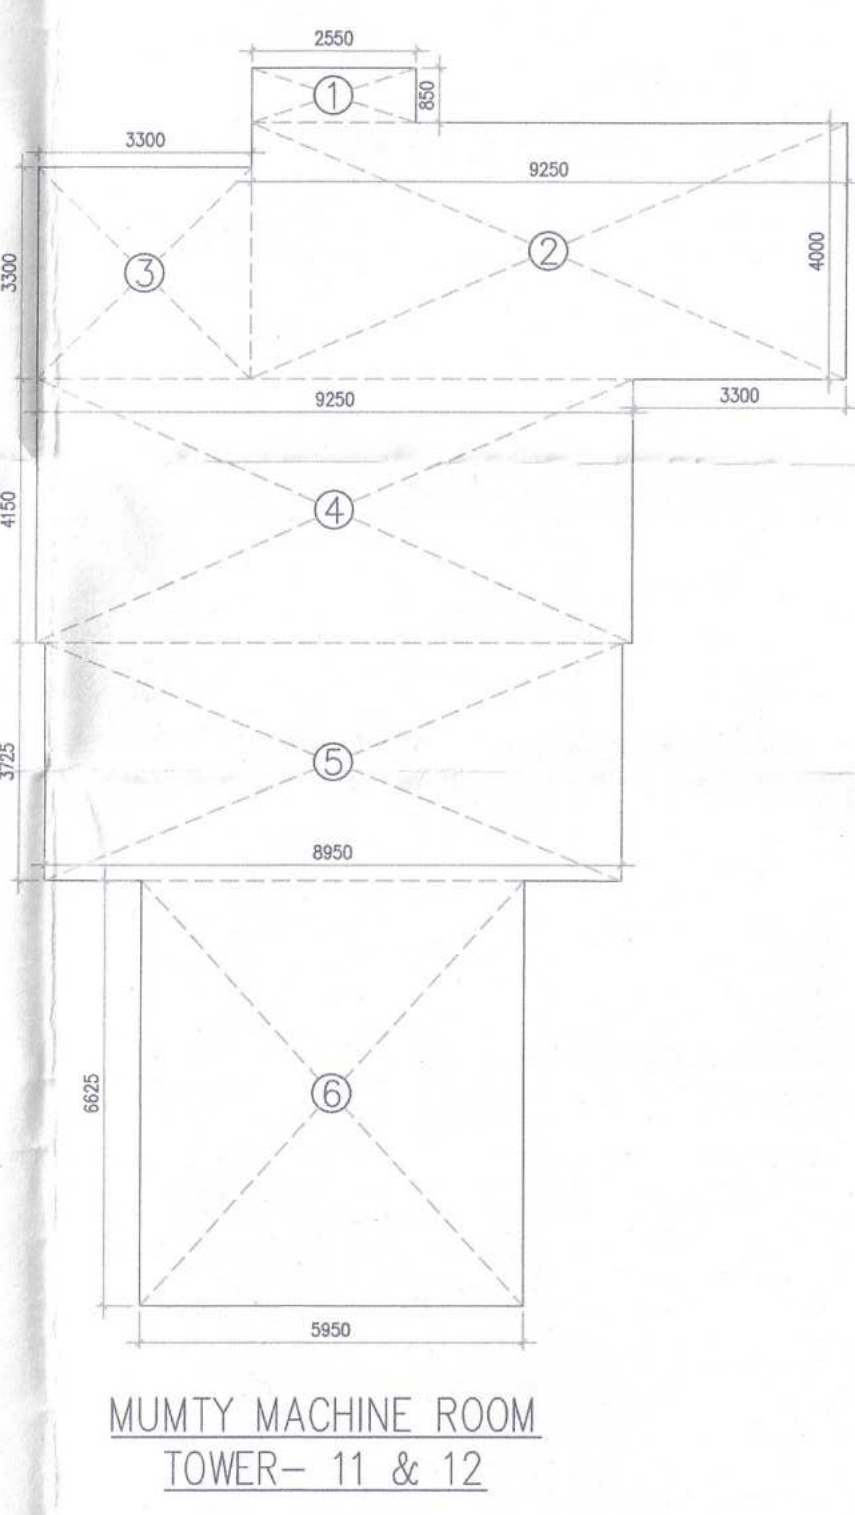


MUMTY MACHINE ROOM
TOWER- 11 & 12

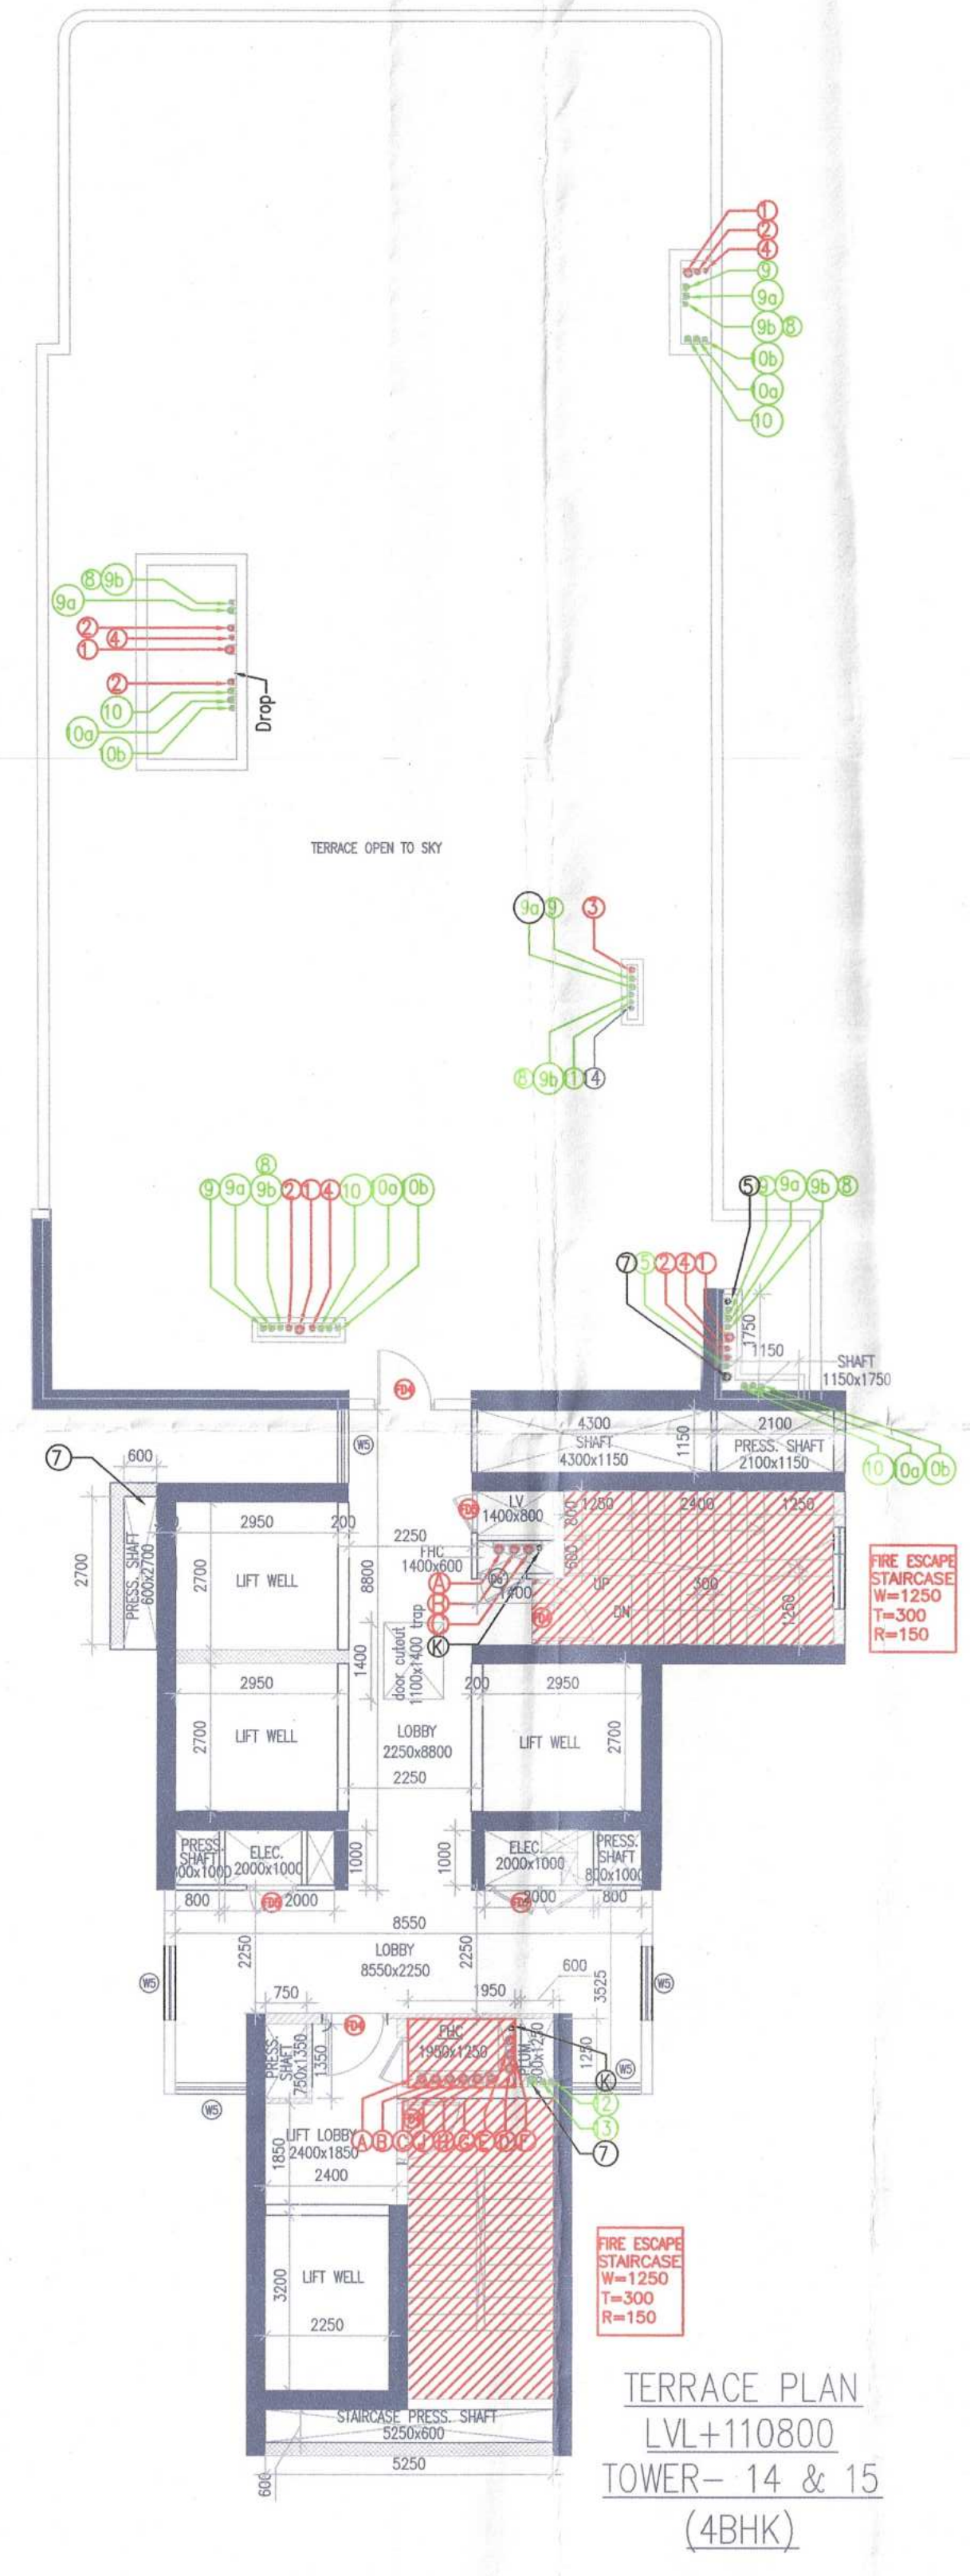

TERRACE PLAN
LVL+110800
TOWER- 14 & 15
(4BHK)

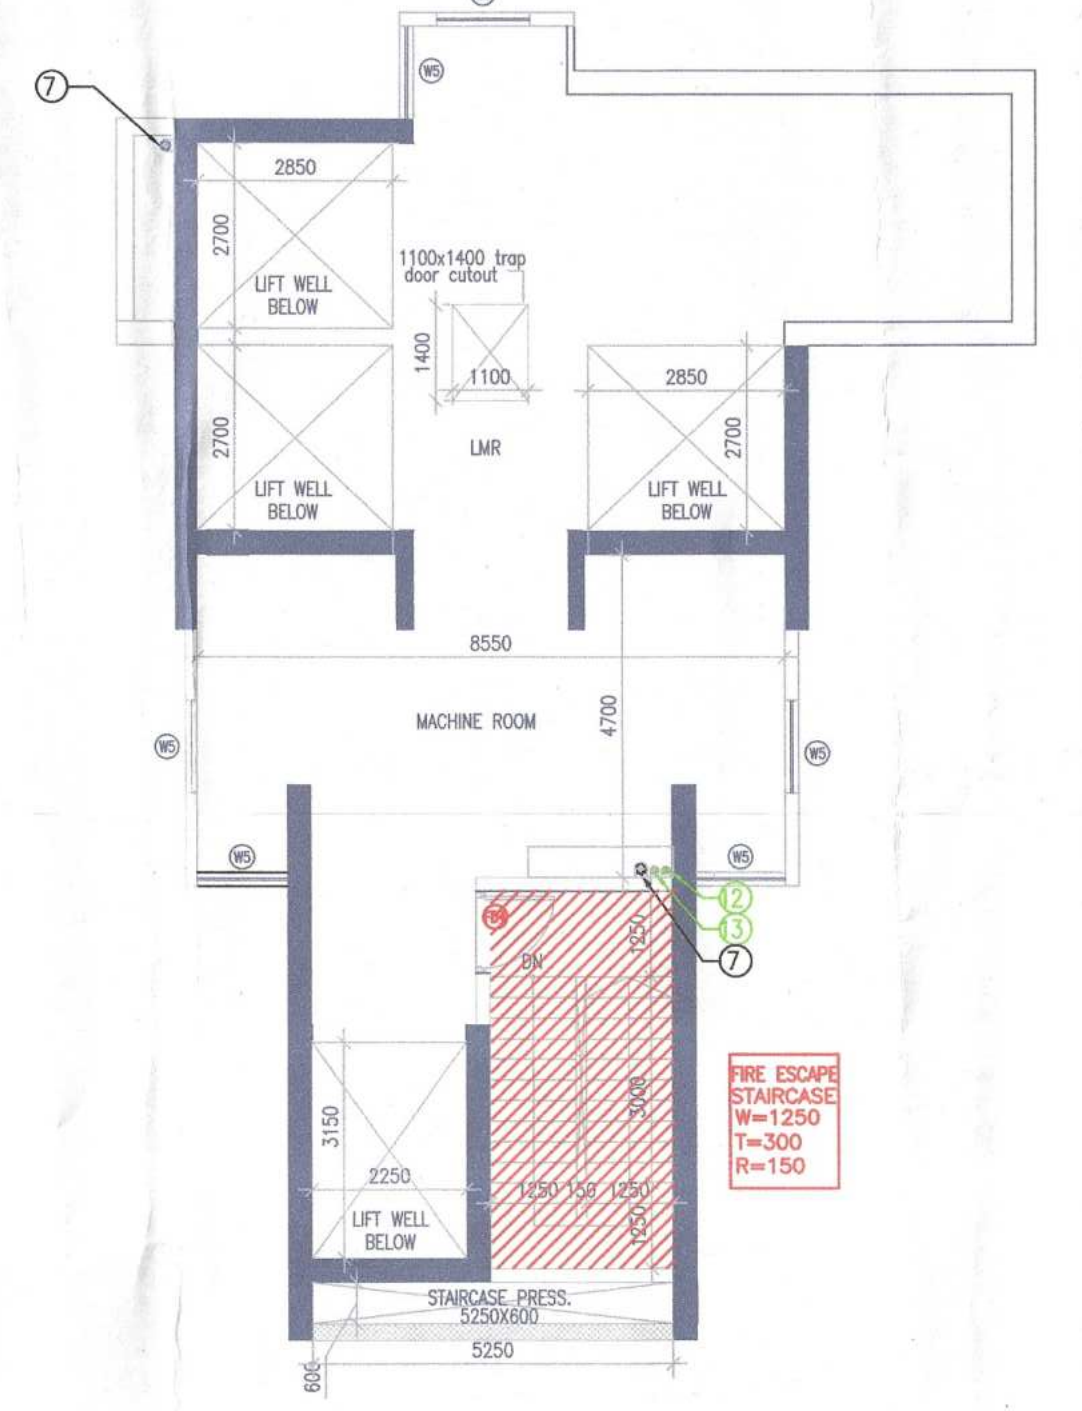

LMR FLOOR PLAN
LVL+113500
TOWER- 14 & 15

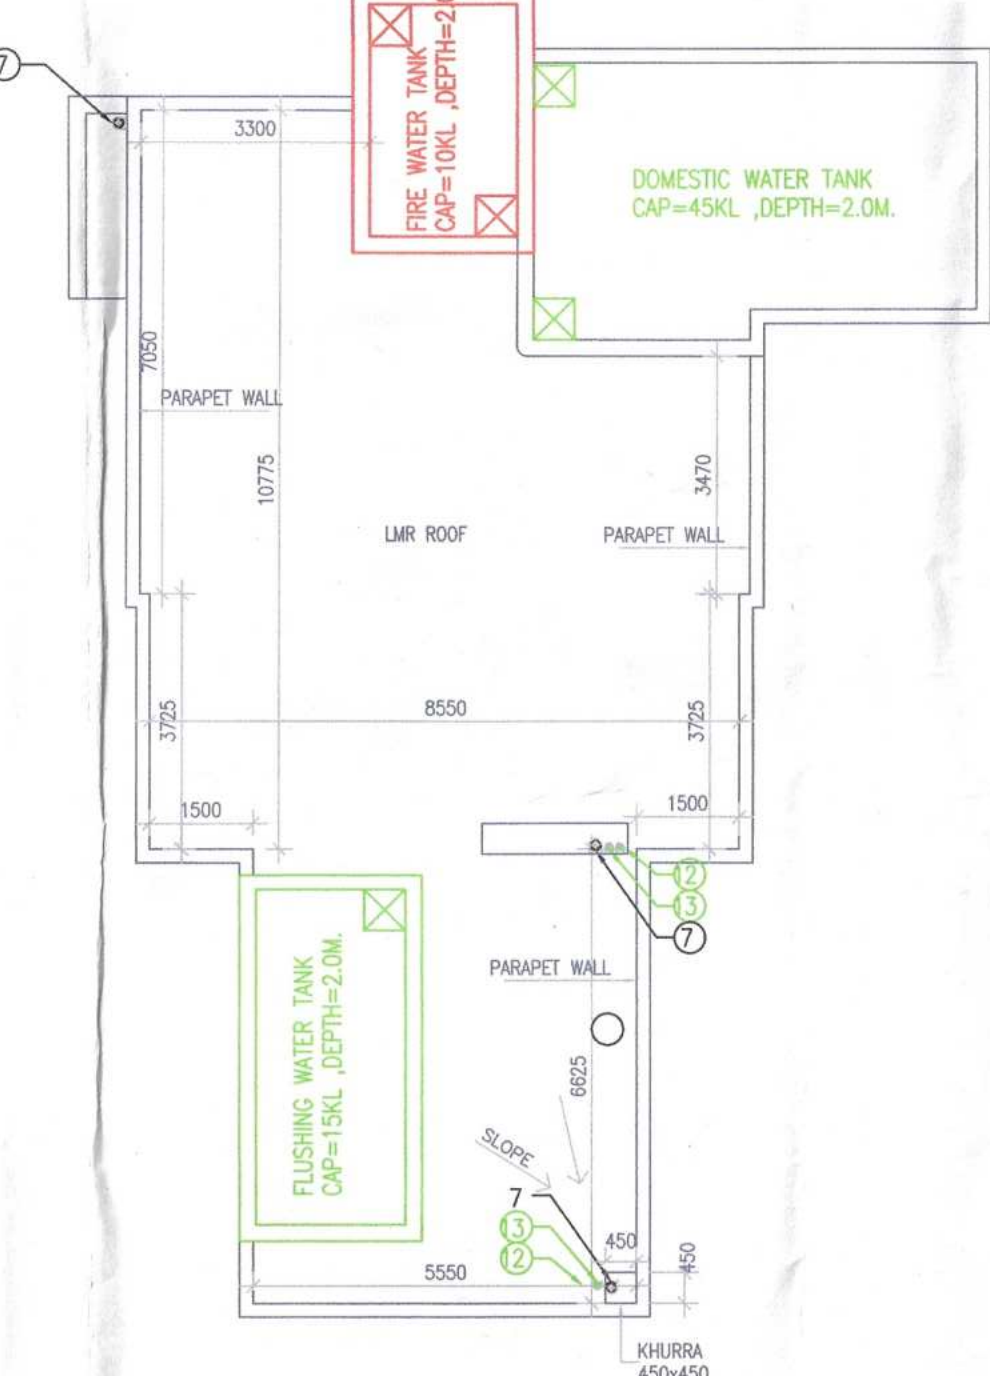

LMR ROOF PLAN
LVL+116800
TOWER- 14 & 15

MUMTY / MACHINE ROOM AREA CALCULATION					
GROSS - A					
1	=	1	X	2.550	X 0.850 = 2.168 SQM
2	=	1	X	9.250	X 4.000 = 37.000 SQM
3	=	1	X	3.300	X 3.300 = 10.890 SQM
4	=	1	X	9.250	X 4.150 = 38.388 SQM
5	=	1	X	8.950	X 3.725 = 33.339 SQM
6	=	1	X	5.950	X 6.625 = 39.419 SQM
				TOTAL	= 161.203 SQM

Building Plans have been checked and found correct as per Public Health Services point of view.

Executive Engineer-IV
W/S Division, GMDA
Gurgaon

Executive Engineer-V,
Sec. Division, GMDA,
Gurgaon

Executive Engineer-III
Drainage Division, GMDA,
Gurgaon

Chief Engineer,
(Infra-4), GMDA,
Gurgaon

SACTIONED
TO BE READ WITH THIS OFFICE
NO. 103/PH/4

DD (NT) MEMBER
B.P.A.C.

BINESH KUMAR
P.A.(G)

J.D. P.A.

- Note :-
- BUILDING HAS AUTOMATIC SPRINKLER SYSTEM WHEREVER REQUIRED BY NBC.
 - BUILDING WILL BE DESIGNED (STRUCTURES) AS PER RELEVANT IS CODES FOR EARTH QUAKE RESISTANCE.
 - WC SHALL BE MECHANICALLY LIGHT & VENTILATED WHEREVER REQUIRED

PROJECT:
PROPOSED BUILDING PLAN OF GROUP HOUSING COLONY
MEASURING 24.10 ACRES (LICENCE NO 80 OF
2012 DATED 17/08/2012)
IN SECTOR 106, GURUGRAM MANESAR URBAN
COMPLEX BEING DEVELOPED BY AIRMD
DEVELOPERS LTD. & OTHERS.

OWNER'S SEAL
& SIGNATURE

Architect's Seal
& SIGNATURE





AVINASH CHANDRA VAIDYA
Architect No. CA/7502005
11 No. 103, PH/4
New Palam Vihar, Gurugram

AUG.-2022 Scale : 1:100

Drawing Title:-
TOWER-14
32nd FLOOR PLAN & FAR AREA
CALCULATION DIAGRAM
MUMTY/MACHINE ROOM PLAN &
AREA DIAGRAM


Drawing No:-
A-08

Note:-
 1. BUILDING HAS AUTOMATIC SPRINKLER SYSTEM WHEREVER REQUIRED BY NBC.
 2. BUILDING WILL BE DESIGNED (STRUCTURES) AS PER RELEVANT IS CODES FOR EARTH QUAKE RESISTANCE.
 3. WC SHALL BE MECHANICALLY LIGHT & VENTILATED WHEREVER REQUIRED

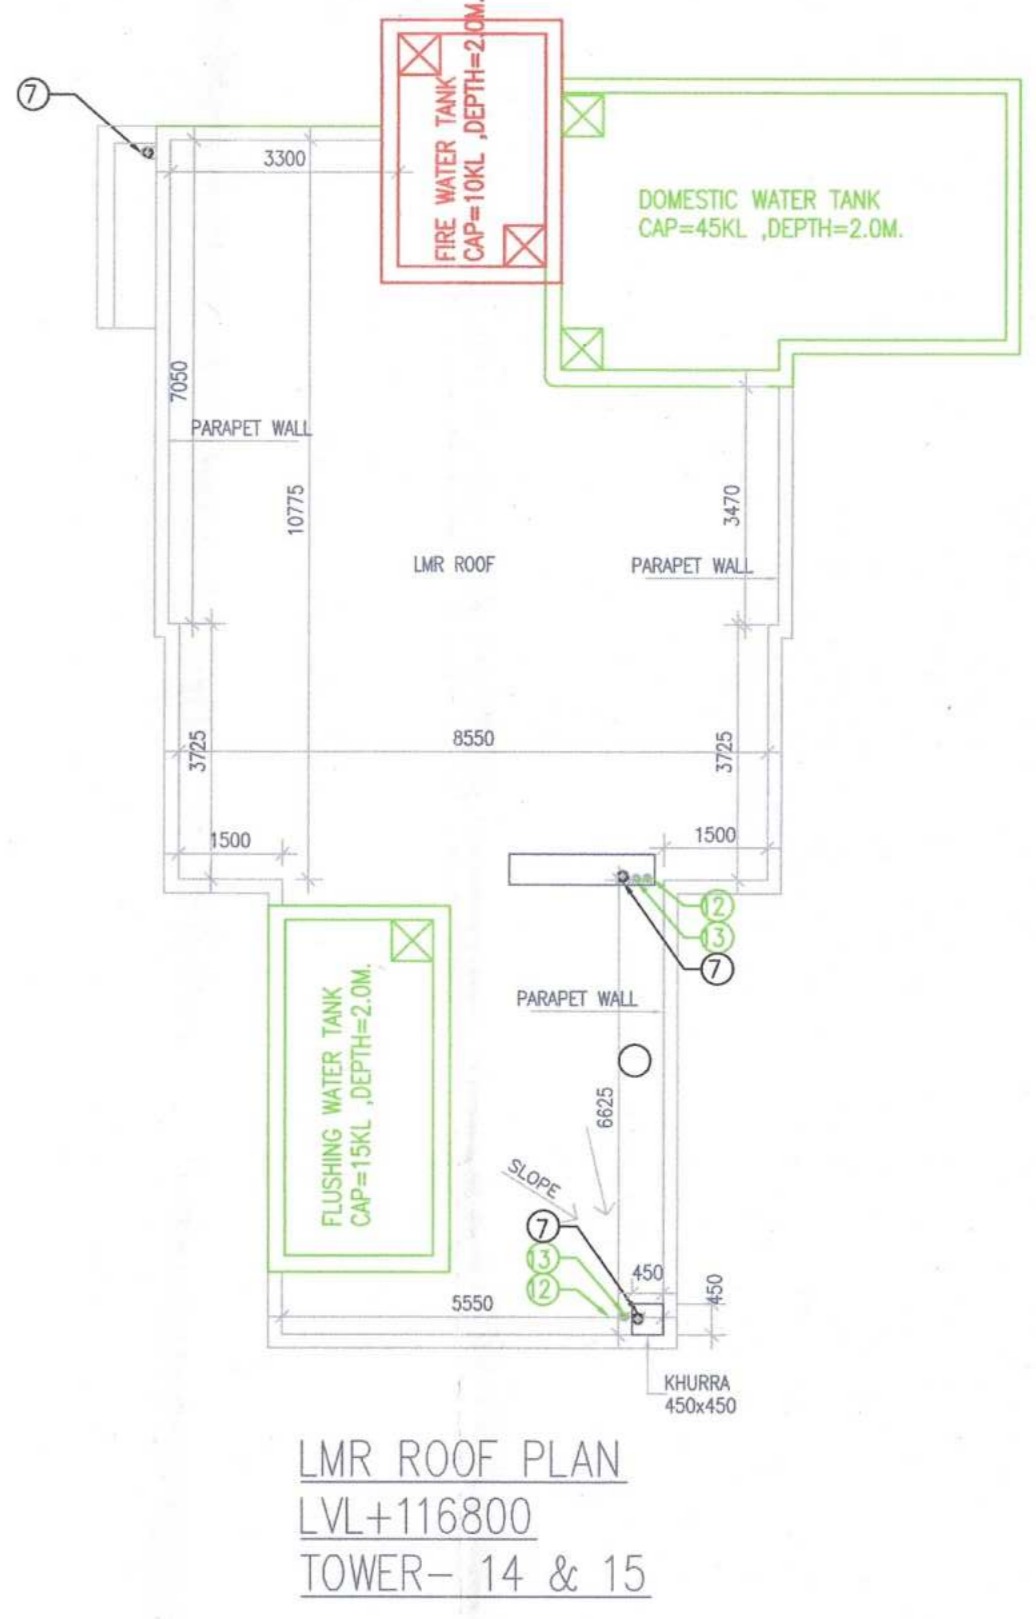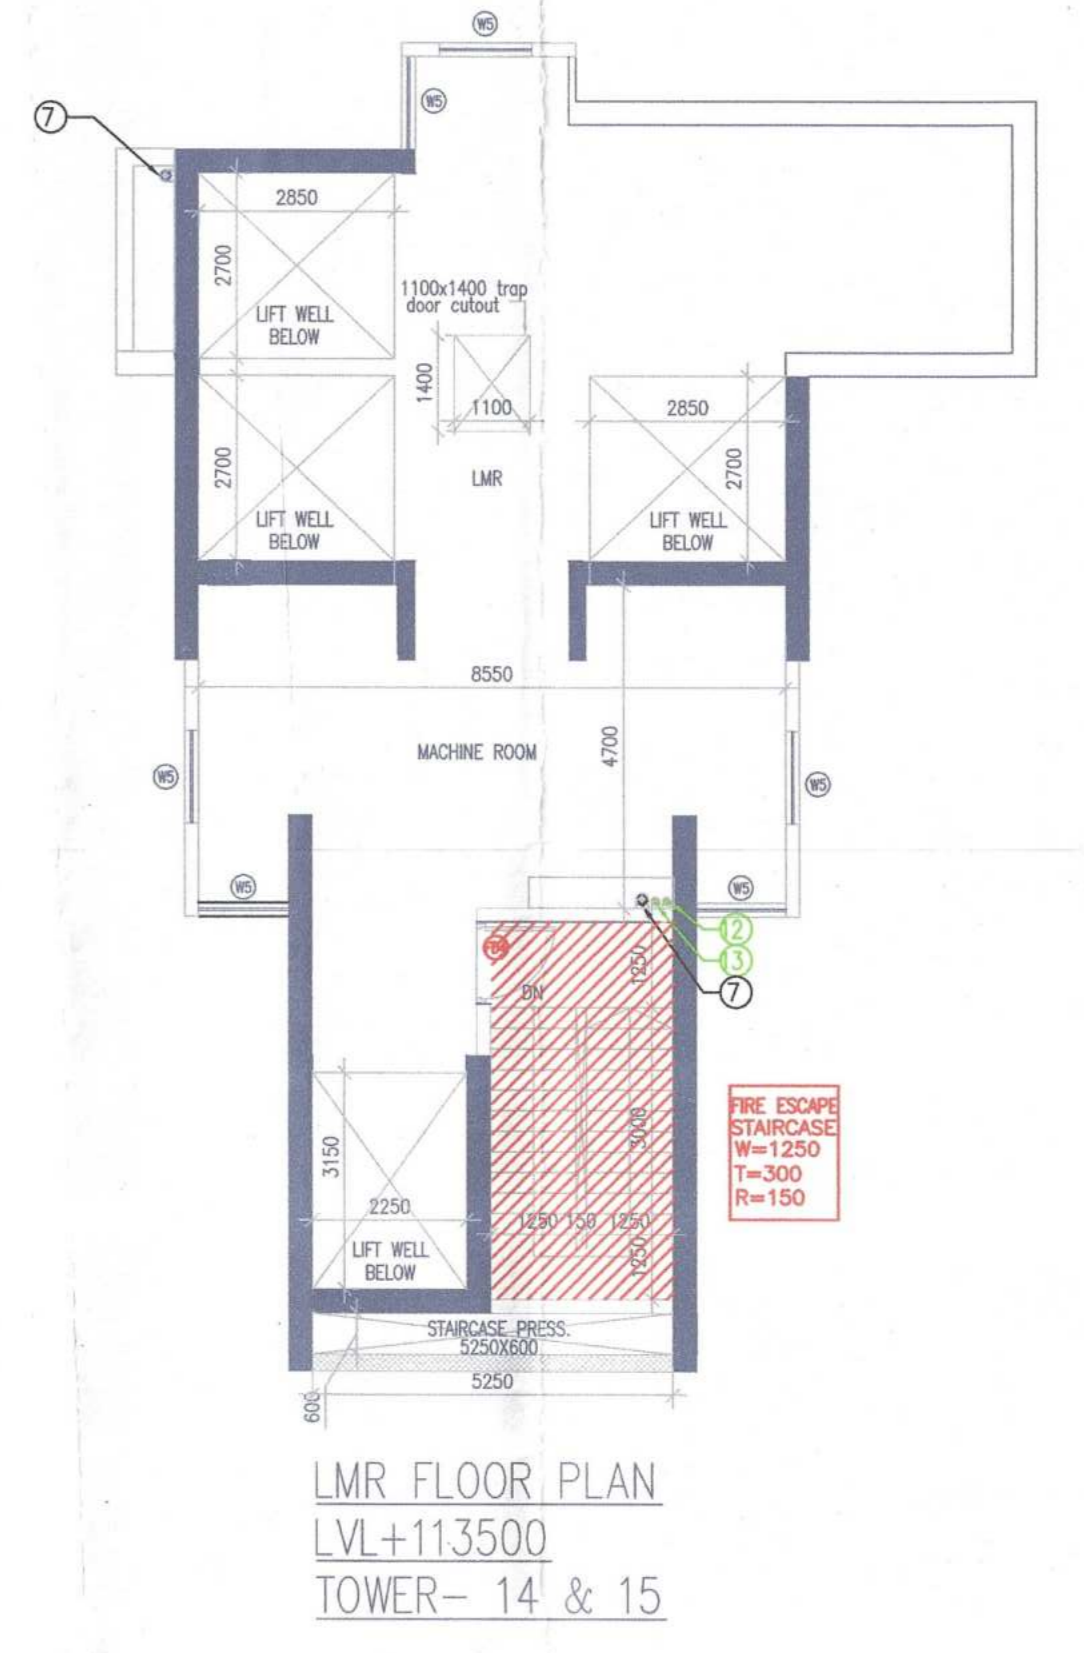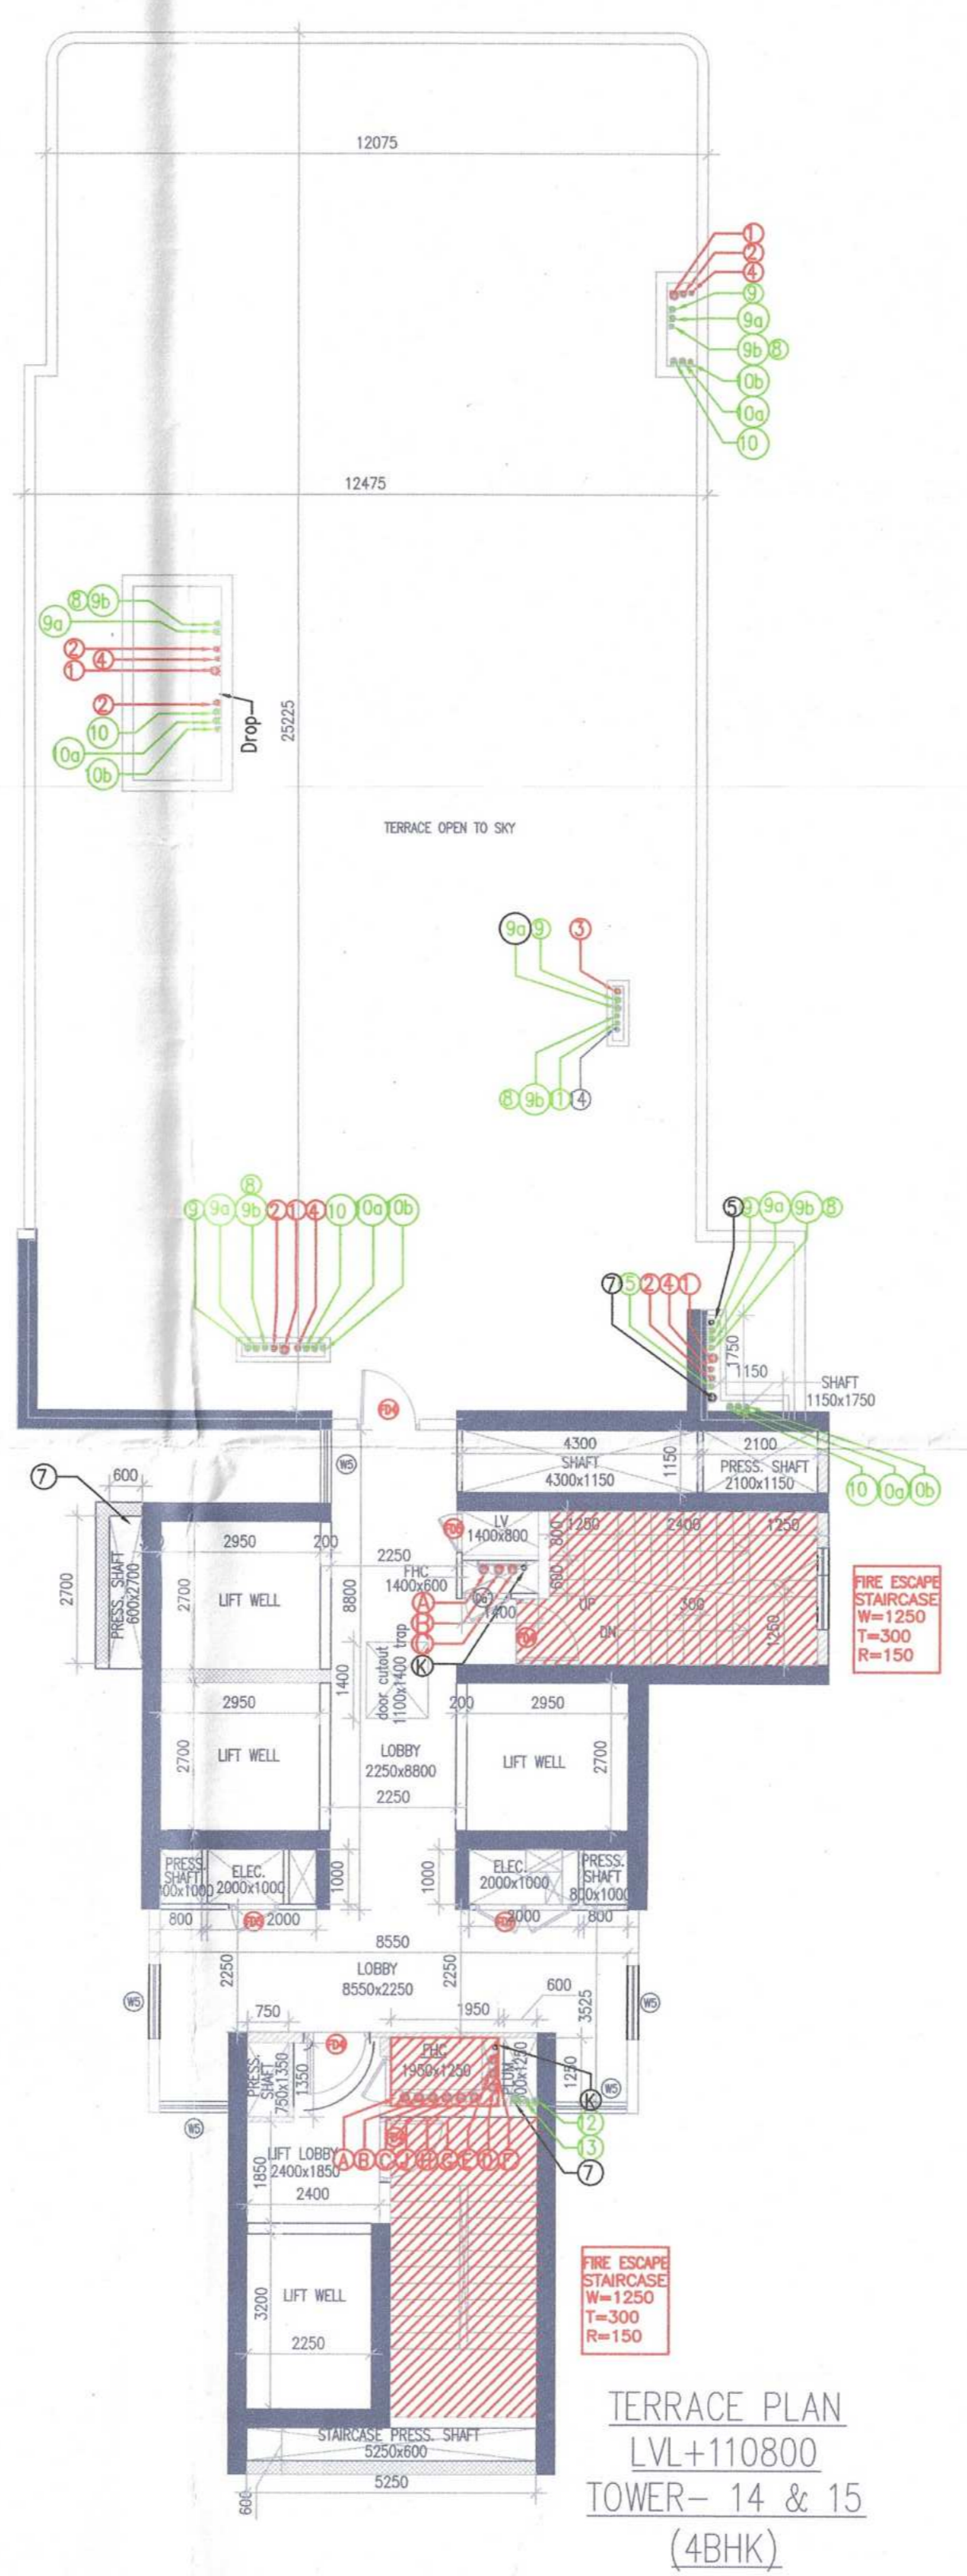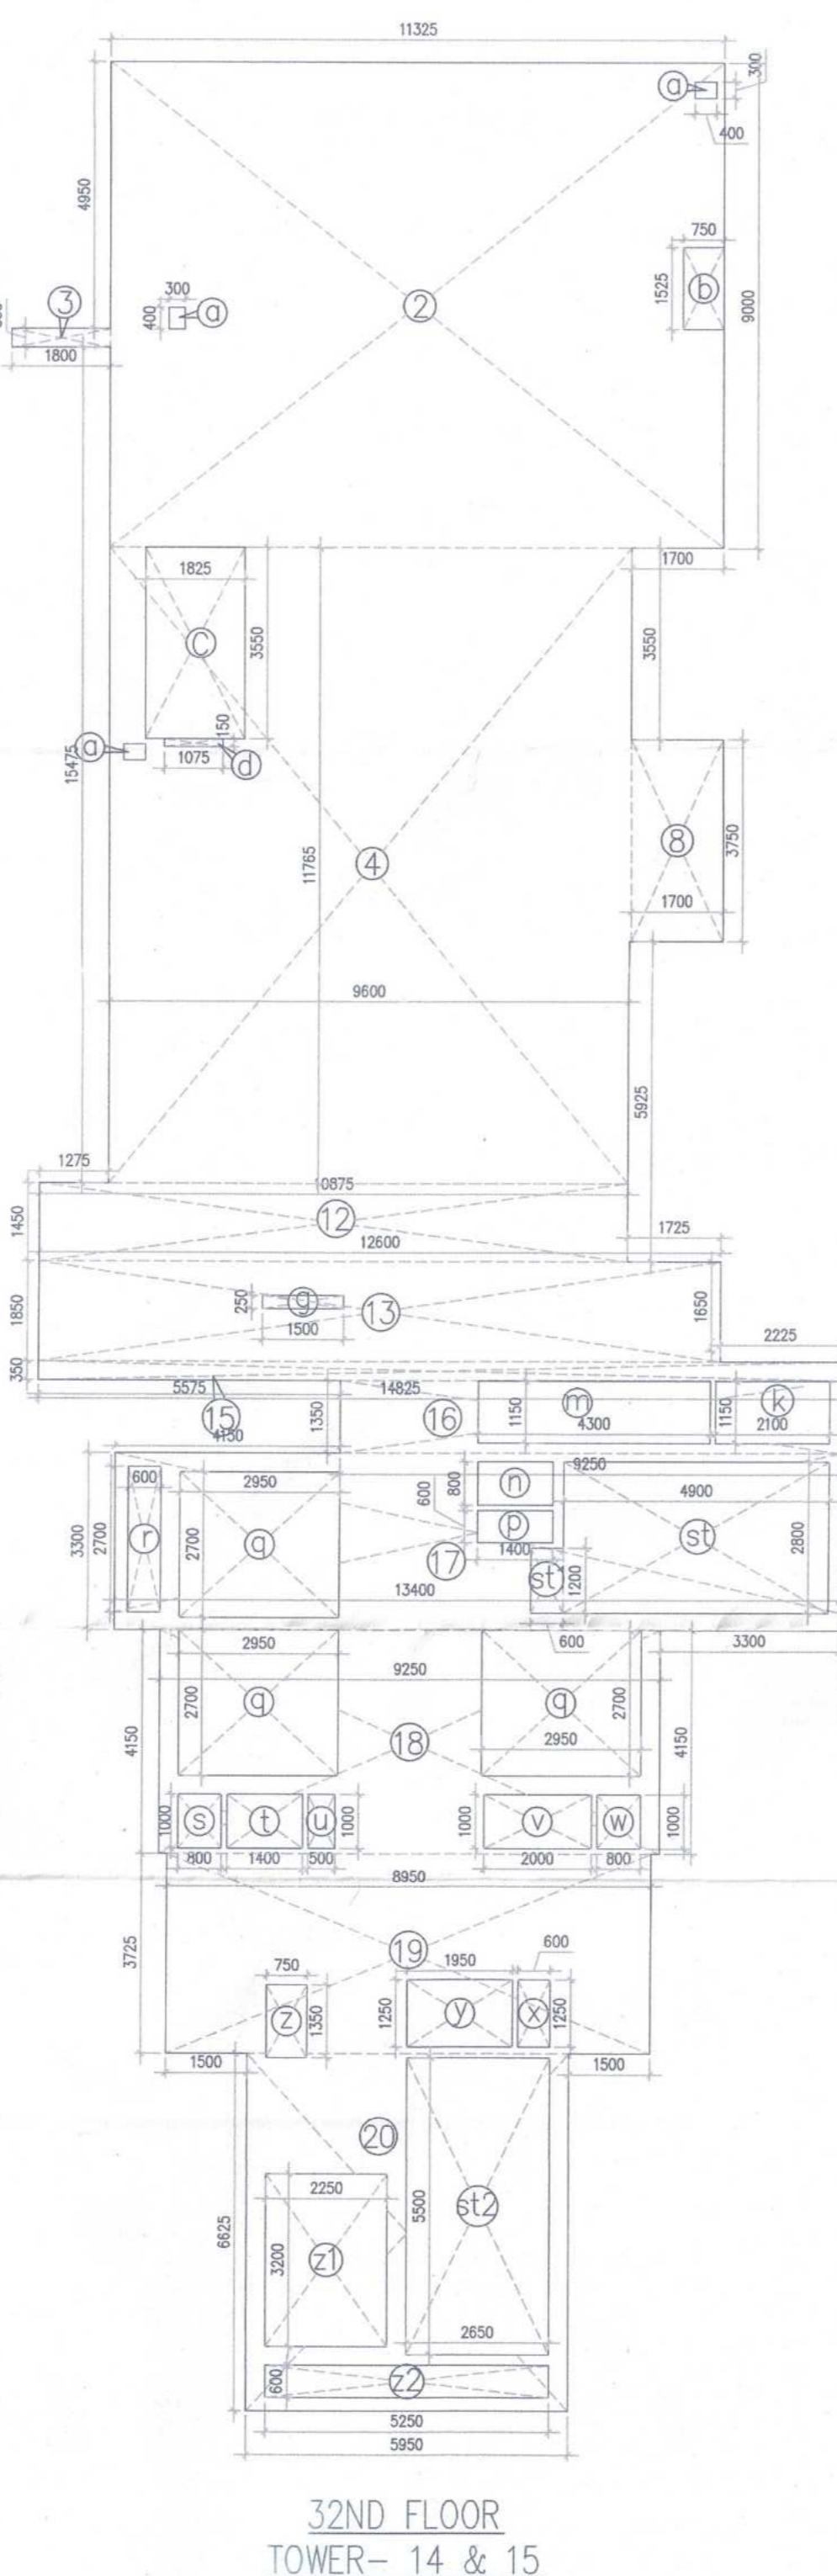

32ND FLOOR AREA CALCULATION									
GROSS - A									
2	=	1	X	11.325	X	9.000	=	101.925	SQM
3	=	1	X	1.800	X	0.350	=	0.630	SQM
4	=	1	X	9.600	X	11.765	=	112.844	SQM
8	=	1	X	1.700	X	3.750	=	6.375	SQM
12	=	1	X	10.875	X	1.450	=	15.769	SQM
13	=	1	X	12.600	X	1.850	=	23.310	SQM
15	=	1	X	14.825	X	0.350	=	5.189	SQM
16	=	1	X	9.250	X	1.350	=	12.488	SQM
17	=	1	X	13.400	X	3.300	=	44.220	SQM
18	=	1	X	9.250	X	4.150	=	38.388	SQM
19	=	1	X	8.950	X	3.725	=	33.339	SQM
20	=	1	X	5.950	X	6.625	=	39.419	SQM
				TOTAL	=	433.994	SQM		
GROSS - B									
a	=	3	X	0.300	X	0.400	=	0.360	SQM
b	=	1	X	0.750	X	1.525	=	1.144	SQM
c	=	1	X	1.825	X	3.550	=	6.479	SQM
d	=	1	X	1.075	X	0.150	=	0.161	SQM
g	=	1	X	1.500	X	0.250	=	0.375	SQM
k	=	1	X	2.100	X	1.150	=	2.415	SQM
m	=	1	X	4.300	X	1.150	=	4.945	SQM
n	=	1	X	1.400	X	0.800	=	1.120	SQM
p	=	1	X	1.400	X	0.600	=	0.840	SQM
q	=	3	X	2.950	X	2.700	=	23.895	SQM
r	=	1	X	0.600	X	2.700	=	1.620	SQM
s	=	1	X	0.800	X	1.000	=	0.800	SQM
t	=	1	X	1.400	X	1.000	=	1.400	SQM
u	=	1	X	0.500	X	1.000	=	0.500	SQM
v	=	1	X	2.000	X	1.000	=	2.000	SQM
w	=	1	X	0.800	X	1.000	=	0.800	SQM
x	=	1	X	0.600	X	1.250	=	0.750	SQM
y	=	1	X	1.950	X	1.250	=	2.438	SQM
z	=	1	X	0.750	X	1.350	=	1.013	SQM
z1	=	1	X	2.250	X	3.200	=	7.200	SQM
z2	=	1	X	5.250	X	0.600	=	3.150	SQM
				TOTAL	=	63.404	SQM		
GROSS - C									
st	=	1	X	4.900	X	2.800	=	13.720	SQM
st1	=	1	X	0.600	X	1.200	=	0.720	SQM
st2	=	1	X	2.650	X	5.500	=	14.575	SQM
				TOTAL	=	29.015	SQM		
FAR AREA OF 32ND FLOOR				=	GROSS-A	-	GROSS-B	-	GROSS
				=	433.994	-	63.404	-	29.01
TOTAL				=	341.575	SQM	GROSS-D		
BUILT-UP AREA OF 32ND FLOOR				=	GROSS-D	+	GROSS-C		
				=	341.575	+	29.015		
TOTAL				=	370.590	SQM			

MUMTY / MACHINE ROOM AREA CALCULATION									
GROSS - A									
1	=	1	X	2.550	X	0.850	=	2.168	SQM
2	=	1	X	9.250	X	4.000	=	37.000	SQM
3	=	1	X	3.300	X	3.300	=	10.890	SQM
4	=	1	X	9.250	X	4.150	=	38.388	SQM
5	=	1	X	8.950	X	3.725	=	33.339	SQM
6	=	1	X	5.950	X	6.625	=	39.419	SQM
				TOTAL	=	161.203	SQM		

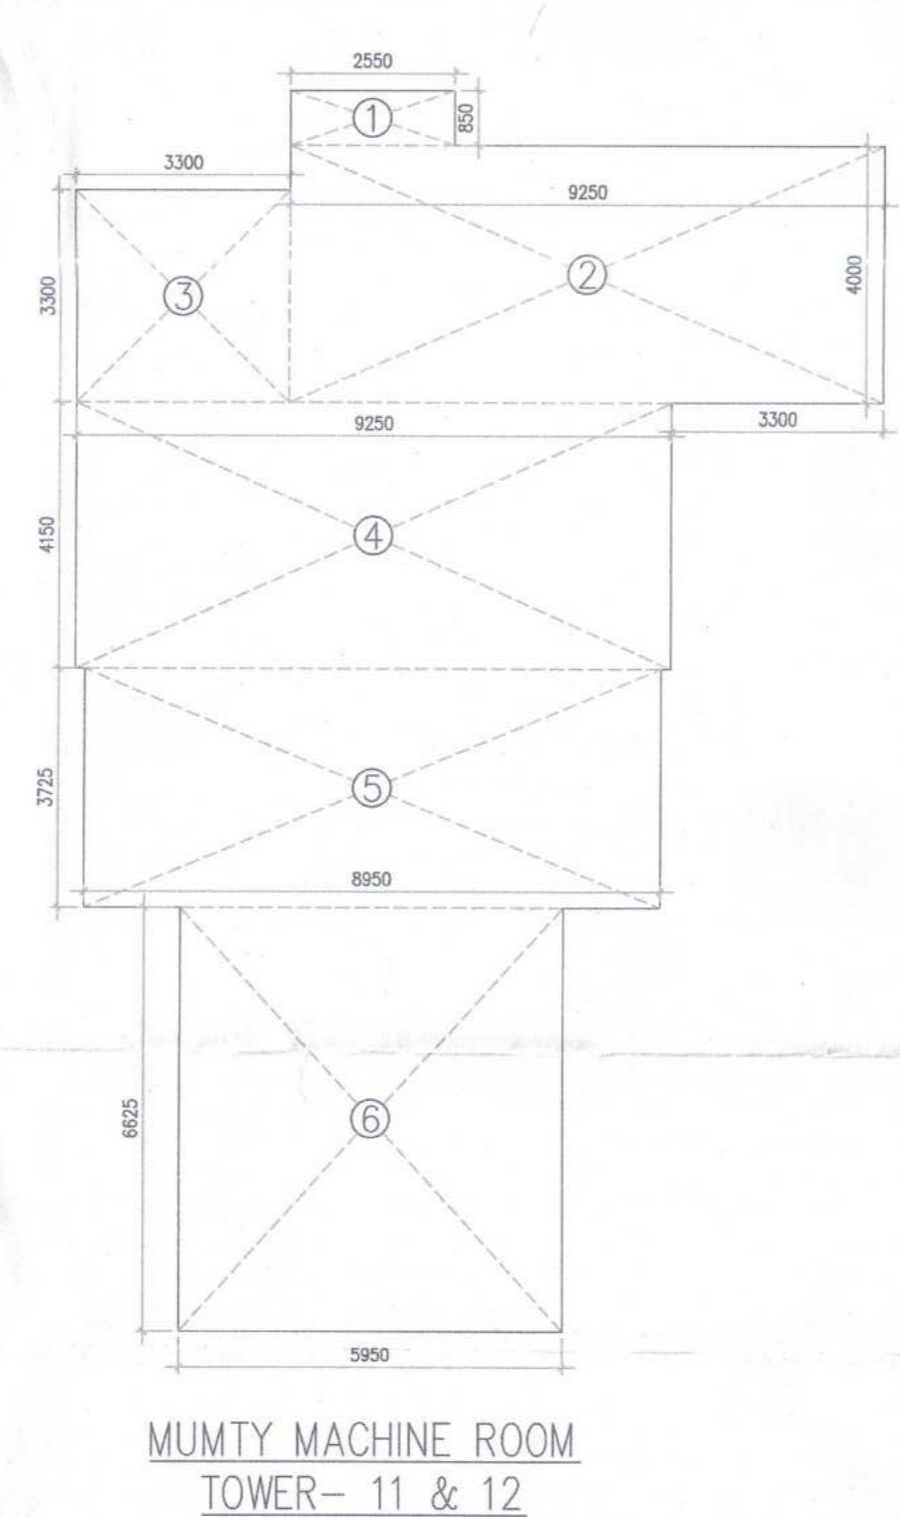

Building Plans have been checked and found in order as per Public Health Services point of view.

Sanctioned by:
 Executive Engineer-IV
 J/S Division, GMDA
 Gurugram

Chief Engineer, (In-charge) GMDA Gurugram

DDT (N) MEMBER BPAC
 DINESH KUMAR PA(HQ)

TO BE READ WITH THIS OFFICE ORDER NO. DATED:



PROJECT:
 PROPOSED BUILDING PLAN OF GROUP HOUSING COLONY MEASURING 24.10 ACRES (LICENCE NO 80 OF 2012 DATED 17/08/2012) IN SECTOR 106, GURUGRAM MANESAR URBAN COMPLEX BEING DEVELOPED BY AIRMID DEVELOPERS LTD. & OTHERS.

OWNER'S SEAL & SIGNATURE
 AIRMID DEVELOPERS LIMITED
 Authorised Signatory

ARCHITECT'S SEAL & SIGNATURE
 AIRMID DEVELOPERS LIMITED

AUG.-2022. Scale : 1:100
 Drawing Title:- TOWER- 15 32nd FLOOR PLAN & FAR AREA CALCULATION-DUGHRAM MUMTY MACHINE ROOM PLAN & AREA DIAGRAM
 Drawing No:- A-09a

Note:-
 1. BUILDING HAS AUTOMATIC SPRINKLER SYSTEM WHEREVER REQUIRED BY NBC.
 2. BUILDING WILL BE DESIGNED (STRUCTURES) AS PER RELEVANT IS CODES FOR EARTH QUAKE RESISTANCE.

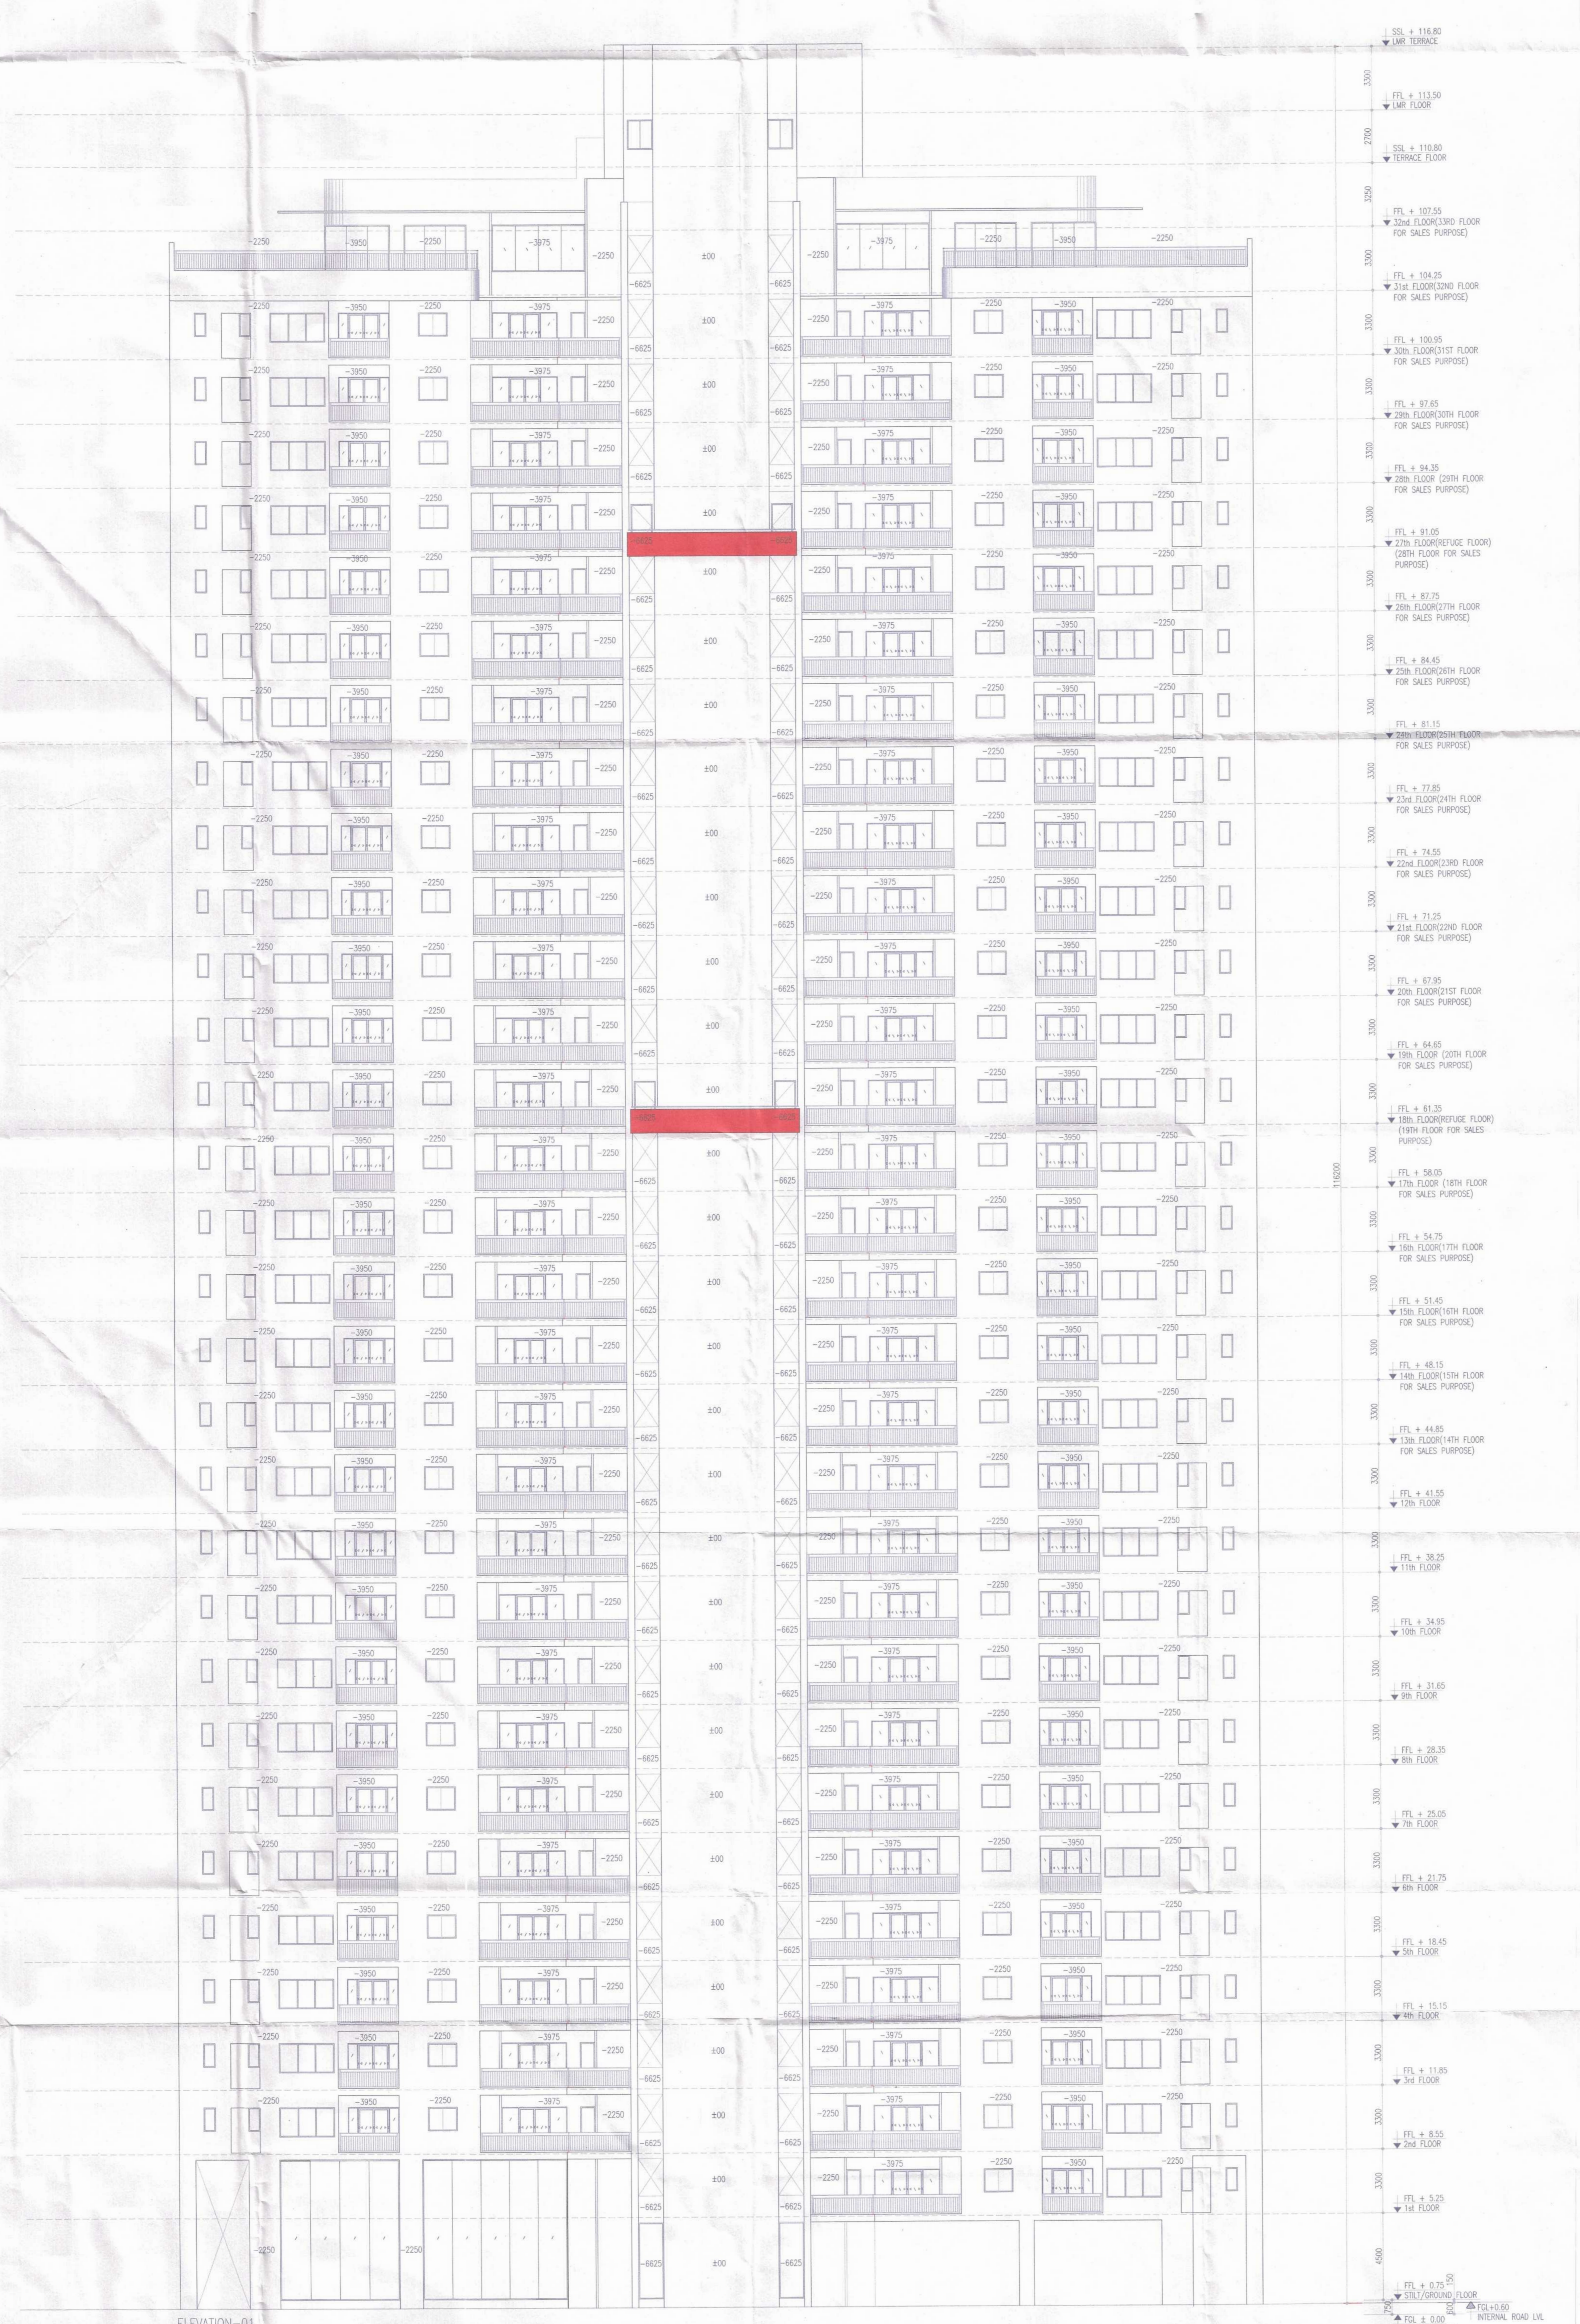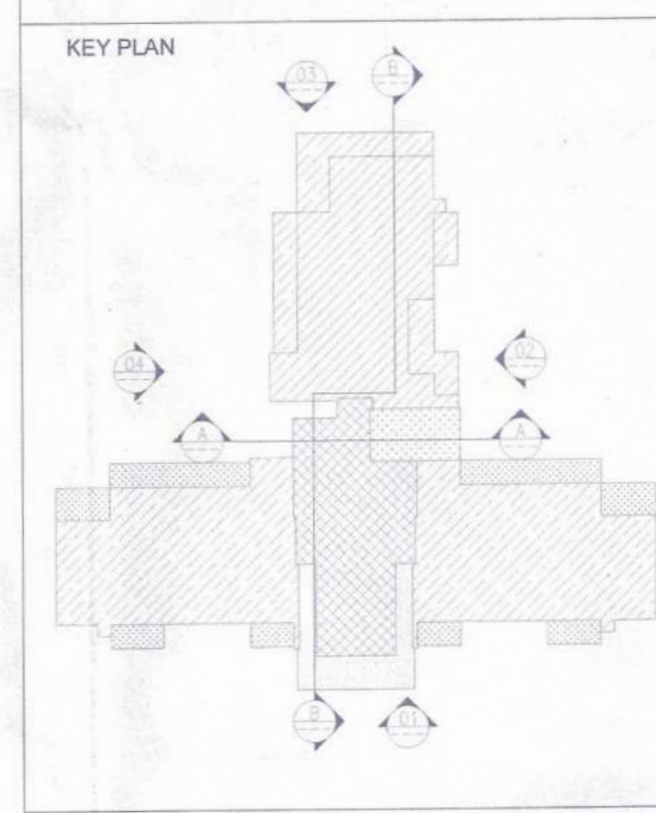

ELEVATION-01

Sanctioned
 TO BE READ WITH THIS OFFICE MEMO NO. DATED: _____

DINESH KUMAR (PA(HQ))
 MEMBER B.P.A.C.
 DOTA MEMBER B.P.A.C.

PROJECT:
 PROPOSED BUILDING PLAN OF GROUP HOUSING
 COLONY MEASURING 24.10 ACRES (LICENSE NO 80 OF 2012 DATED 17/08/2012)
 IN SECTOR 106, GURUKRAM MANESAR URBAN COMPLEX BEING DEVELOPED BY ARJUN DEVELOPERS LTD. & OTHERS.

OWNER'S SEAL & SIGNATURE
 Aaim Developers Limited

ARCHITECT'S SEAL & SIGNATURE



 AVINASH CHANDRA VAIDYA
 Architect No. CA/75/02008
 H. No. 163, PH-II
 New Patam Vihar, Gurugram

AUG-2022 Scale: 1:100
 Drawing Title: TOWER-14 & 15
 Drawing No: _____

Note:-

- 1. BUILDING HAS AUTOMATIC SPRINKLER SYSTEM WHEREVER REQUIRED BY N.C.
- 2. BUILDING WILL BE DESIGNED (STRUCTURE) AS PER RELEVANT IS CODES FOR EARTH QUAKE RESISTANCE.

KEY PLAN

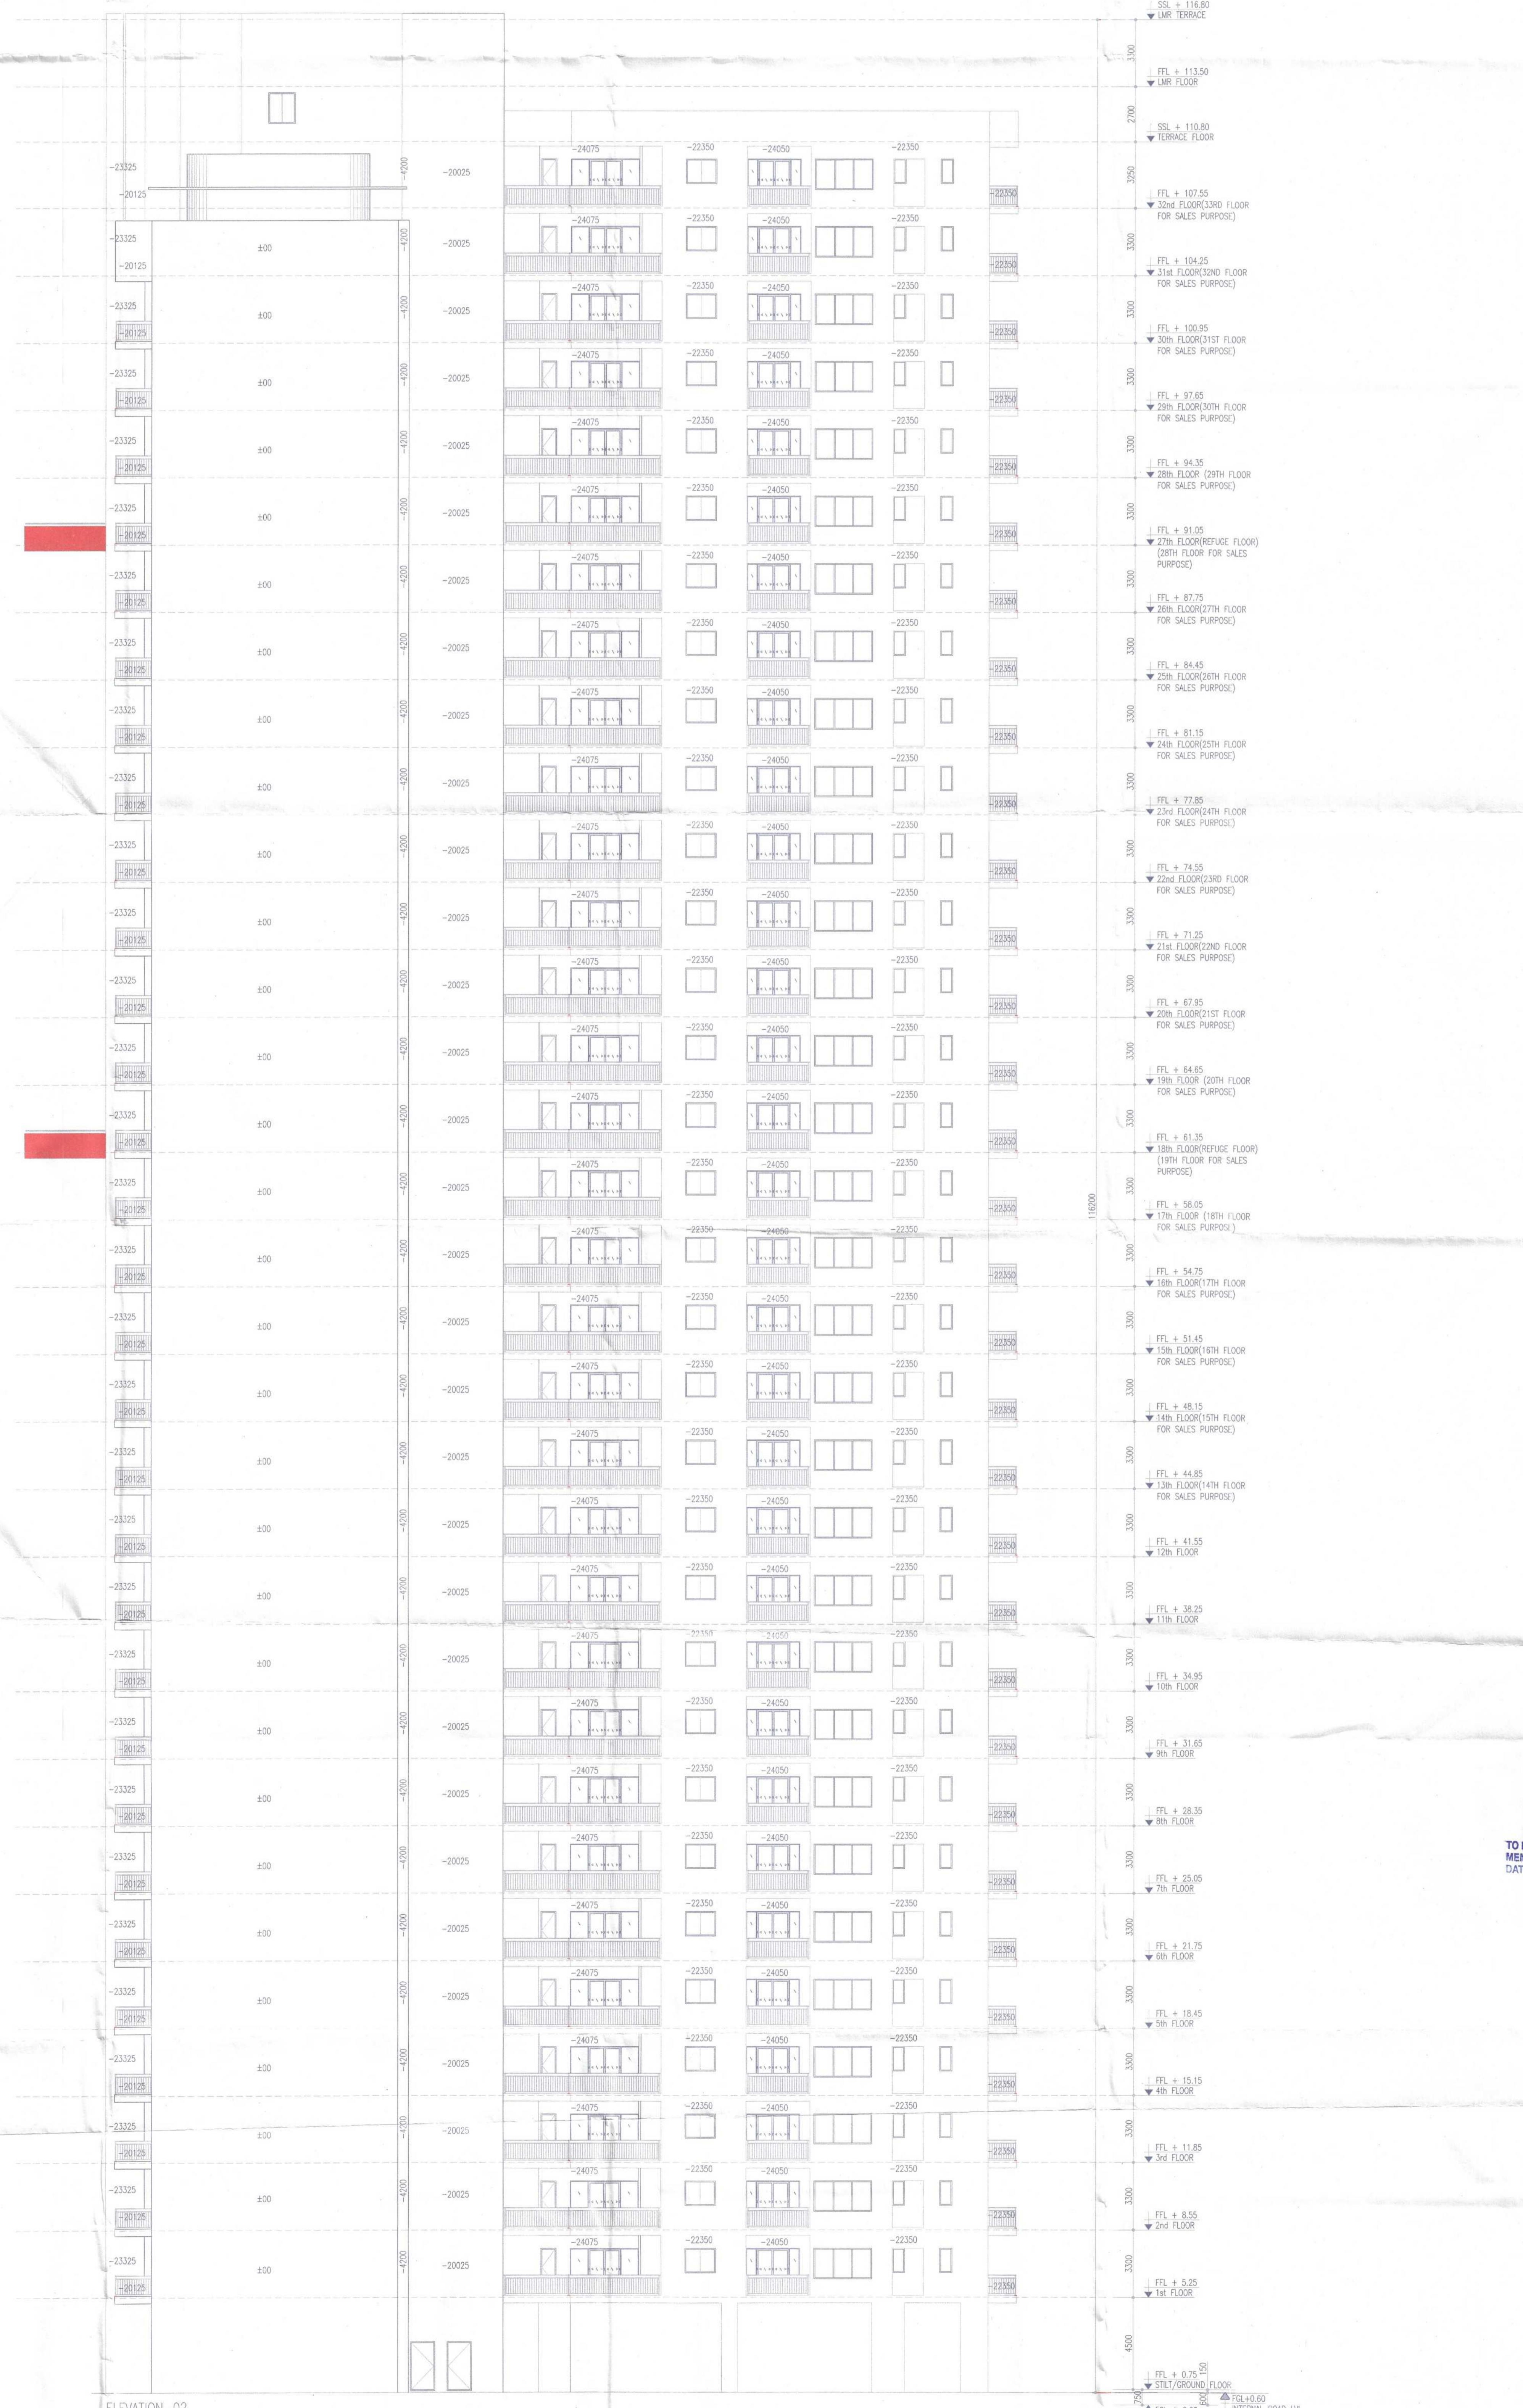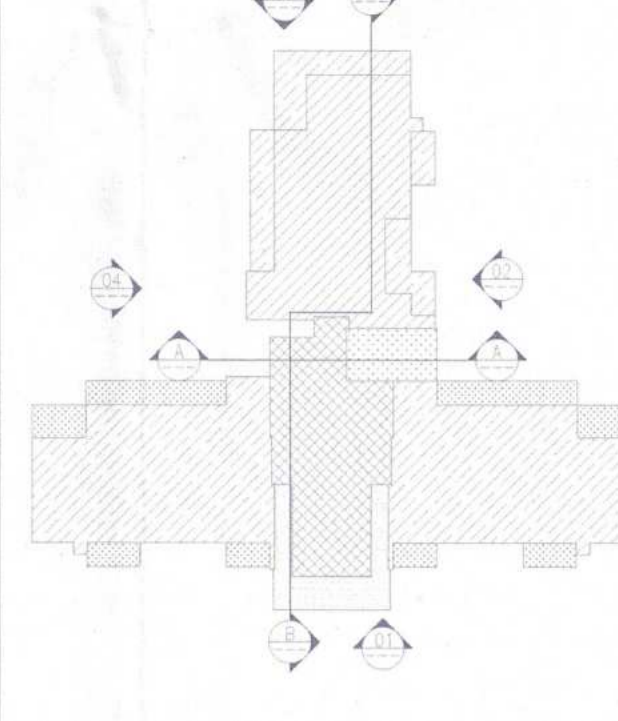

ELEVATION-02

[Signature]
 Member
 B.F.A.C. B.P.C. B.P.A.C.

SACTIONS
 MEMO NO. :
 DATED :
 DINESH SOMAR DD.MEMBER
 PA(HQ) MEMBER
 B.P.A.C.

PROJECT:
 PROPOSED BUILDING PLAN OF GROUP HOUSING COLONY MEASURING 24.10 ACRES (LICENCE NO 80 OF 2012) DATED 17/08/2012 IN SECTOR 10C, GURGRAM MANESAR URBAN COMPLEX BEING DEVELOPED BY AIRMID DEVELOPERS LTD. & OTHERS.


OWNER'S SEAL & SIGNATURE
 Airmid Developers
 Authorised Signatory

ARCHITECT'S SEAL & SIGNATURE
[Signature]
 AVINASH CHANDRA VAIDYA
 Architect No. CA78/02008
 H. No. 15A, P.H.4
 New Palm Vihar, Gurugram

Note:-

1. BUILDING HAS AUTOMATIC SPRINKLER SYSTEM WHEREVER REQUIRED BY NBC.
2. BUILDING WILL BE DESIGNED (STRUCTURES) AS PER RELEVANT IS CODES FOR EARTH QUAKE RESISTANCE.

KEY PLAN

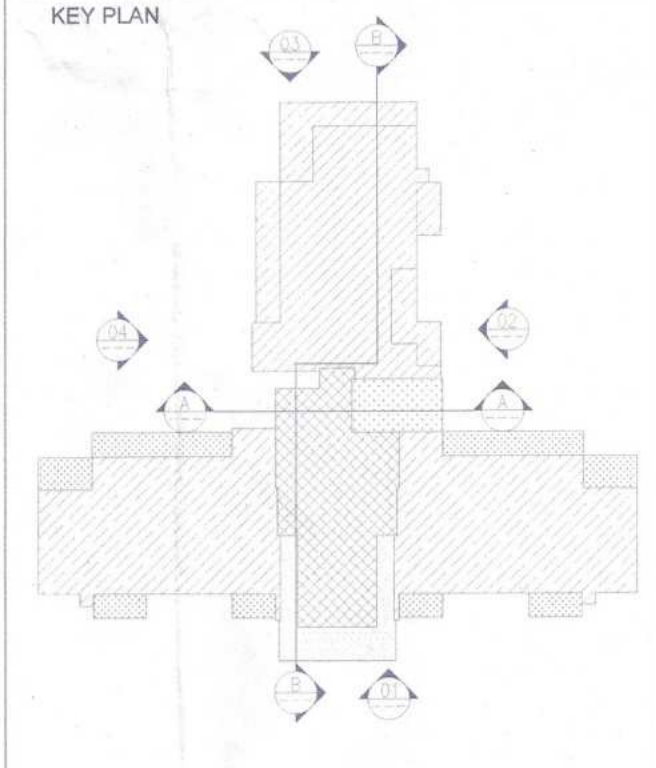

ELEVATION-03



DINESH KUMAR
P.A(HQ)
Member
B.P.A.C.
Member
S.P.A.C.
Member
S.P.A.C.
Member
S.P.A.C.

PROJECT:-
PROPOSED BUILDING PLAN OF GROUP HOUSING COLONY MEASURING 24.10 ACRES (LICENCE NO 80 OF 2012 DATED 17/08/2012) IN SECTOR 105, GURUGRAM MANESAR URBAN COMPLEX BEING DEVELOPED BY ARMO DEVELOPERS LTD. & OTHERS.

OWNER'S SEAL & SIGNATURE
Aimad Developers Limited
Authorised Signatory

ARCHITECT'S SEAL & SIGNATURE
AVINASH CHANDRA WADIA
Architect No. CA/75/02005
H. No. 163, P4-II
New Palam Vihar, Gurugram

Note
 1. BUILDING HAS AUTOMATIC SPRINKLER SYSTEM WHEREVER REQUIRED BY NBC.
 2. BUILDING WILL BE DESIGNED (STRUCTURES) AS PER RELEVANT IS CODES FOR EARTH QUAKE RESISTANCE.

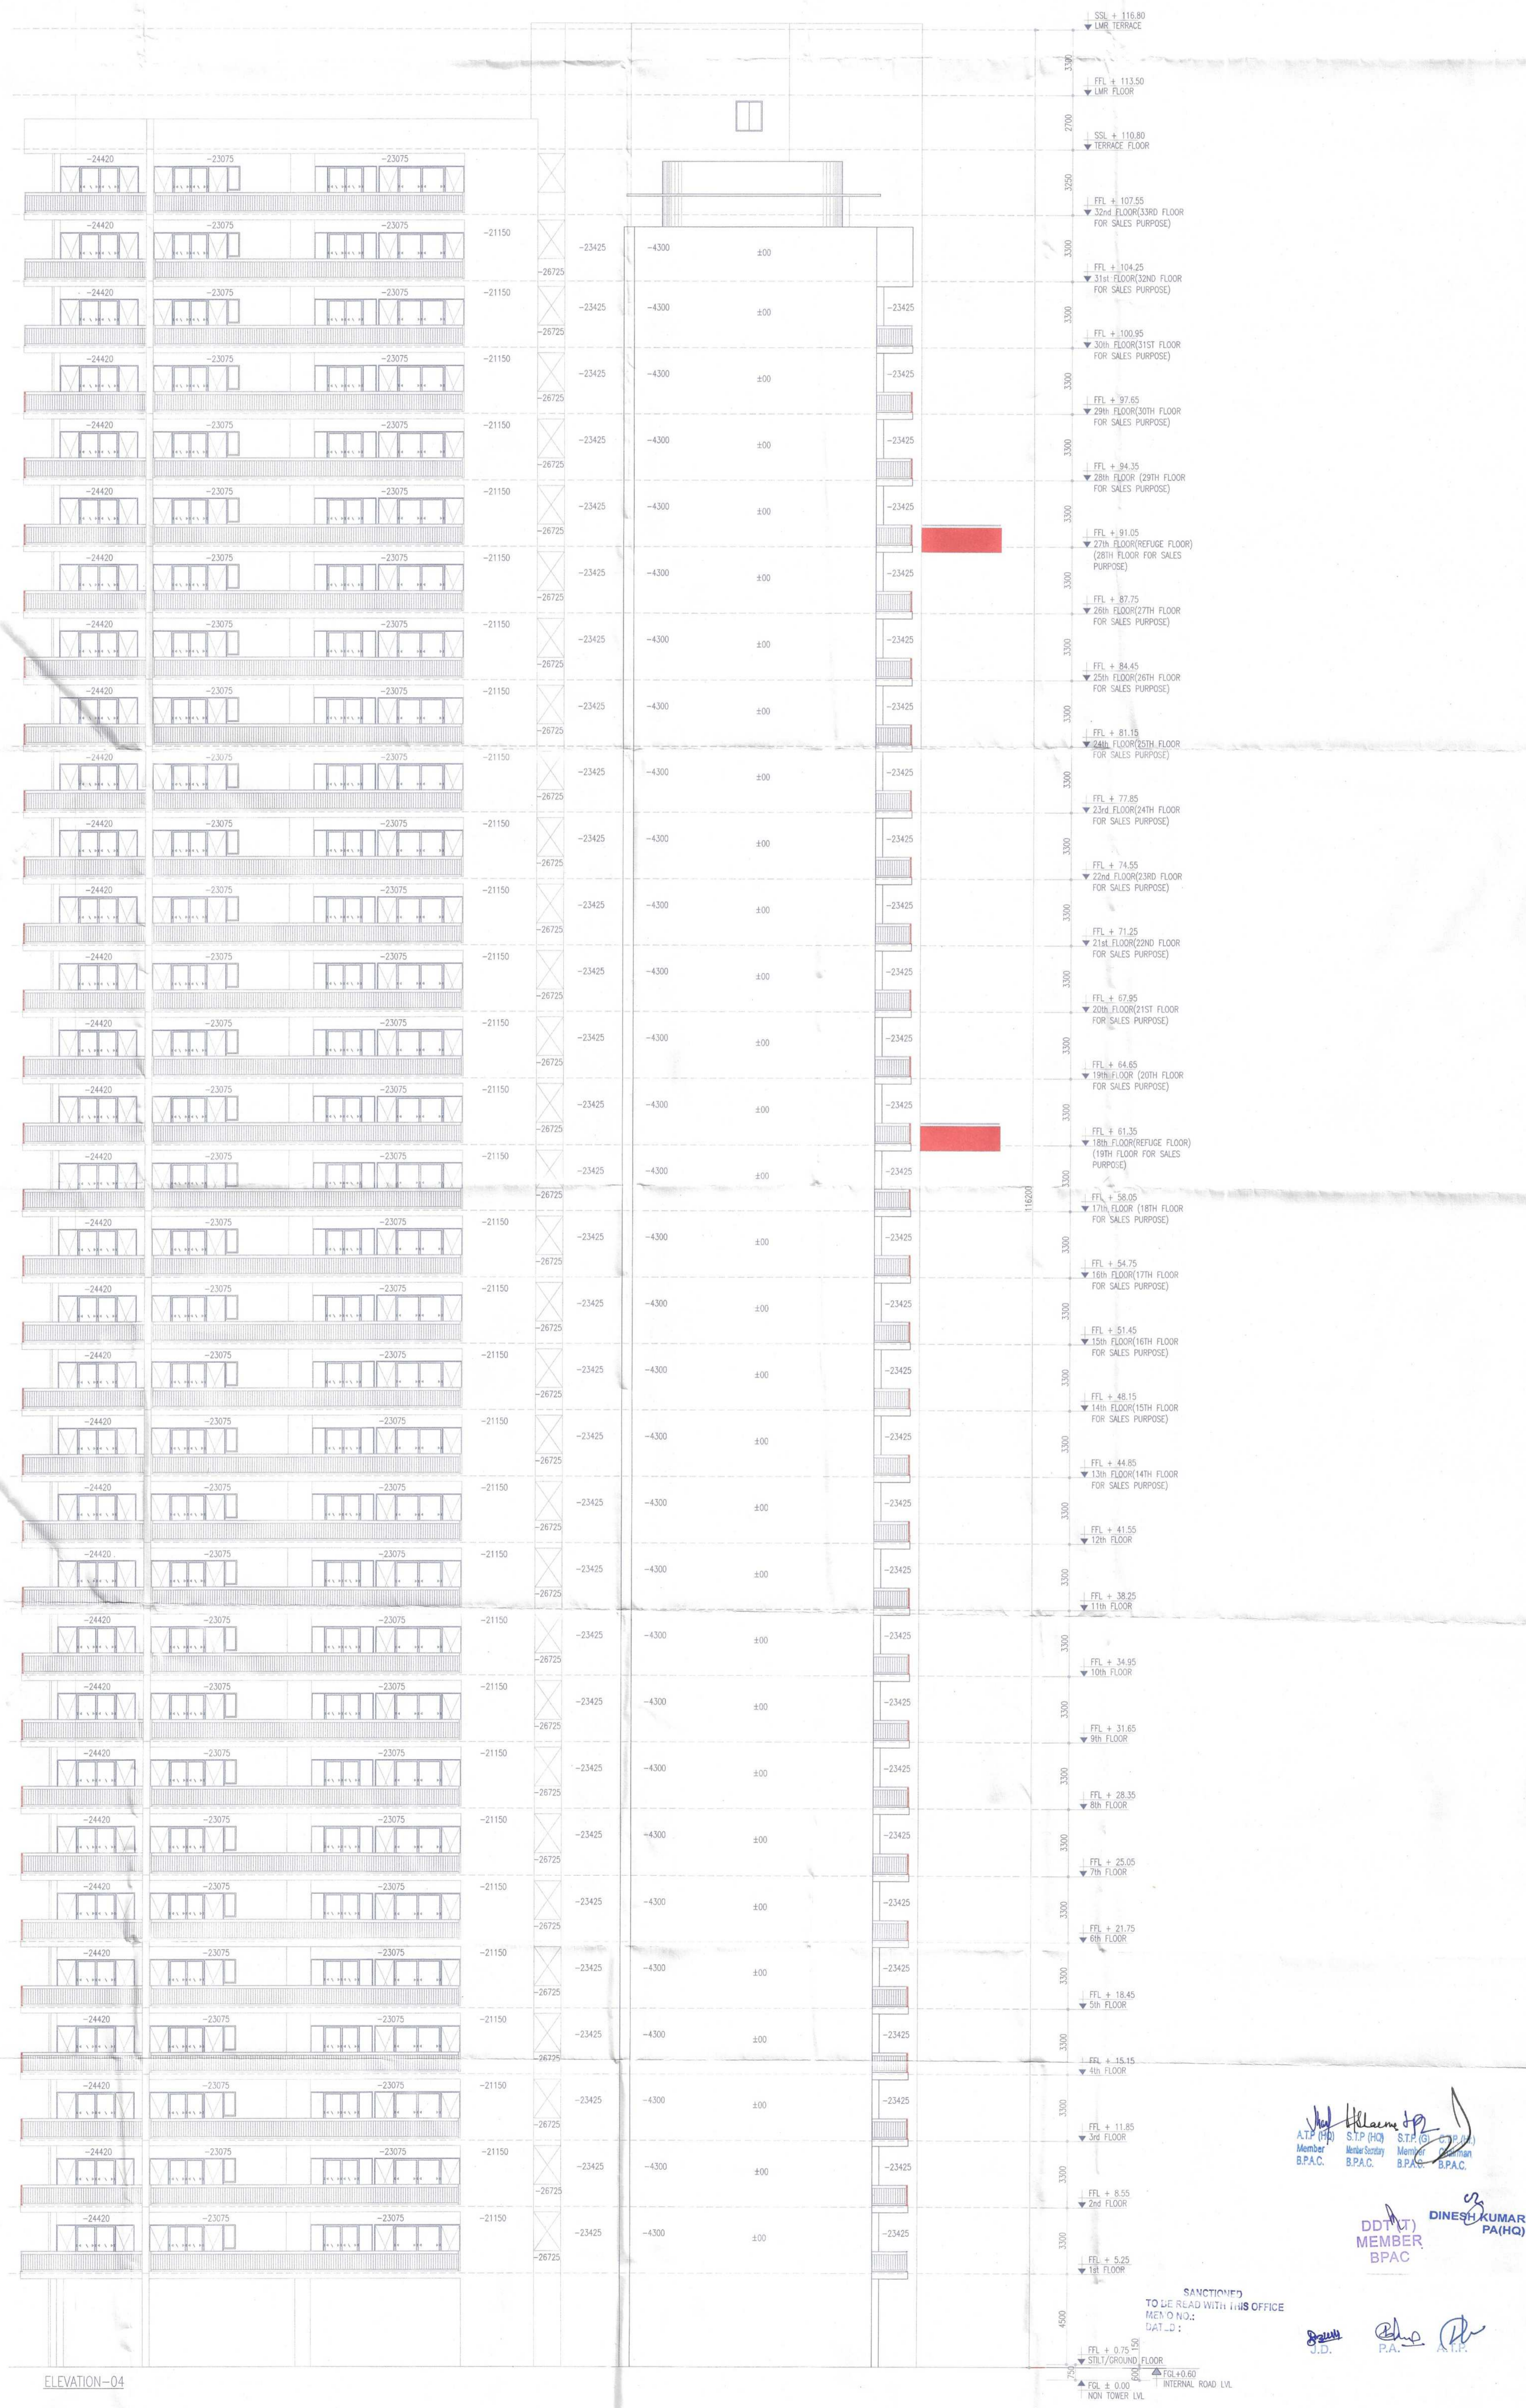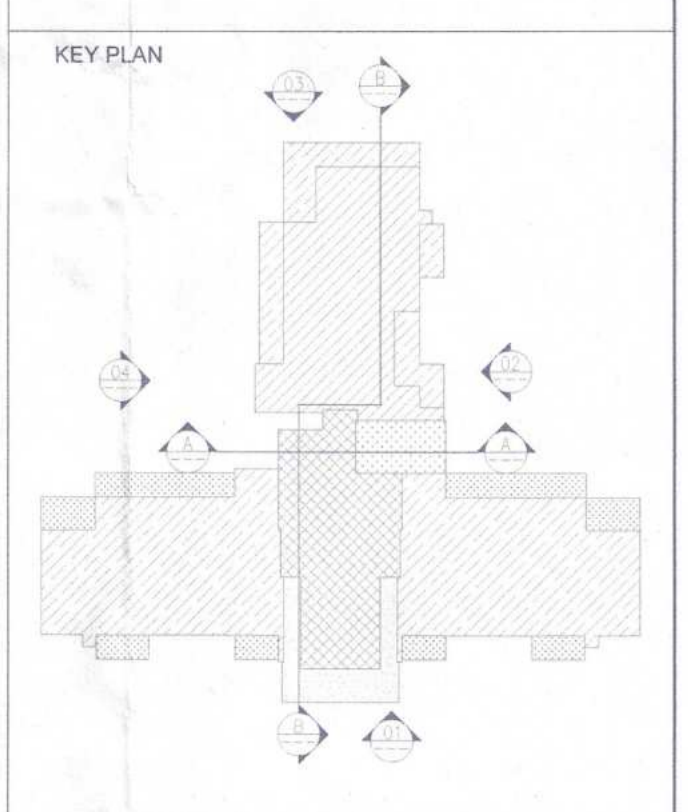

ELEVATION-04

ATP (P) S.P. (H) S.P. (D)
 Member B.P.A.C. Member B.P.A.C. Member B.P.A.C.
DINESH KUMAR PAHQ
 DD (A) MEMBER B.P.A.C.
 TO THE CHIEF ENGINEER
 SANCTIONS OFFICE
 P.A. P.A. P.A.

PROJECT:
 PROPOSED BUILDING PLAN OF GROUP HOUSING COLONY MEASURING 24.10 ACRES (LICENCE NO 80 OF 2012 DATED 17/08/2012) IN SECTION 106, GURUGRAM MANESAR URBAN DEVELOPMENT AUTHORITY (BY ARMD) DEVELOPERS LTD. & OTHERS.



OWNER'S SEAL & SIGNATURE
 Airmid Devel.

Authorise Signatory
Chandra Valdiya
 AVINASH CHANDRA VALDIYA
 Architect No. GA/0600005
 H. No. 103, PH-II
 New Palm Vihar, Gurugram

ARCHITECT'S SEAL & SIGNATURE

AUG-2022 Scale: 1:100
 Drawing Title: TOWER-14 & 15 ELEVATION
 Drawing No: A/8

Note -
 1. BUILDING HAS AUTOMATIC SPRINKLER SYSTEM WHEREVER REQUIRED BY NBC.
 2. BUILDING WILL BE DESIGNED (STRUCTURES) AS PER RELEVANT IS CODES FOR EARTH QUAKE RESISTANCE.

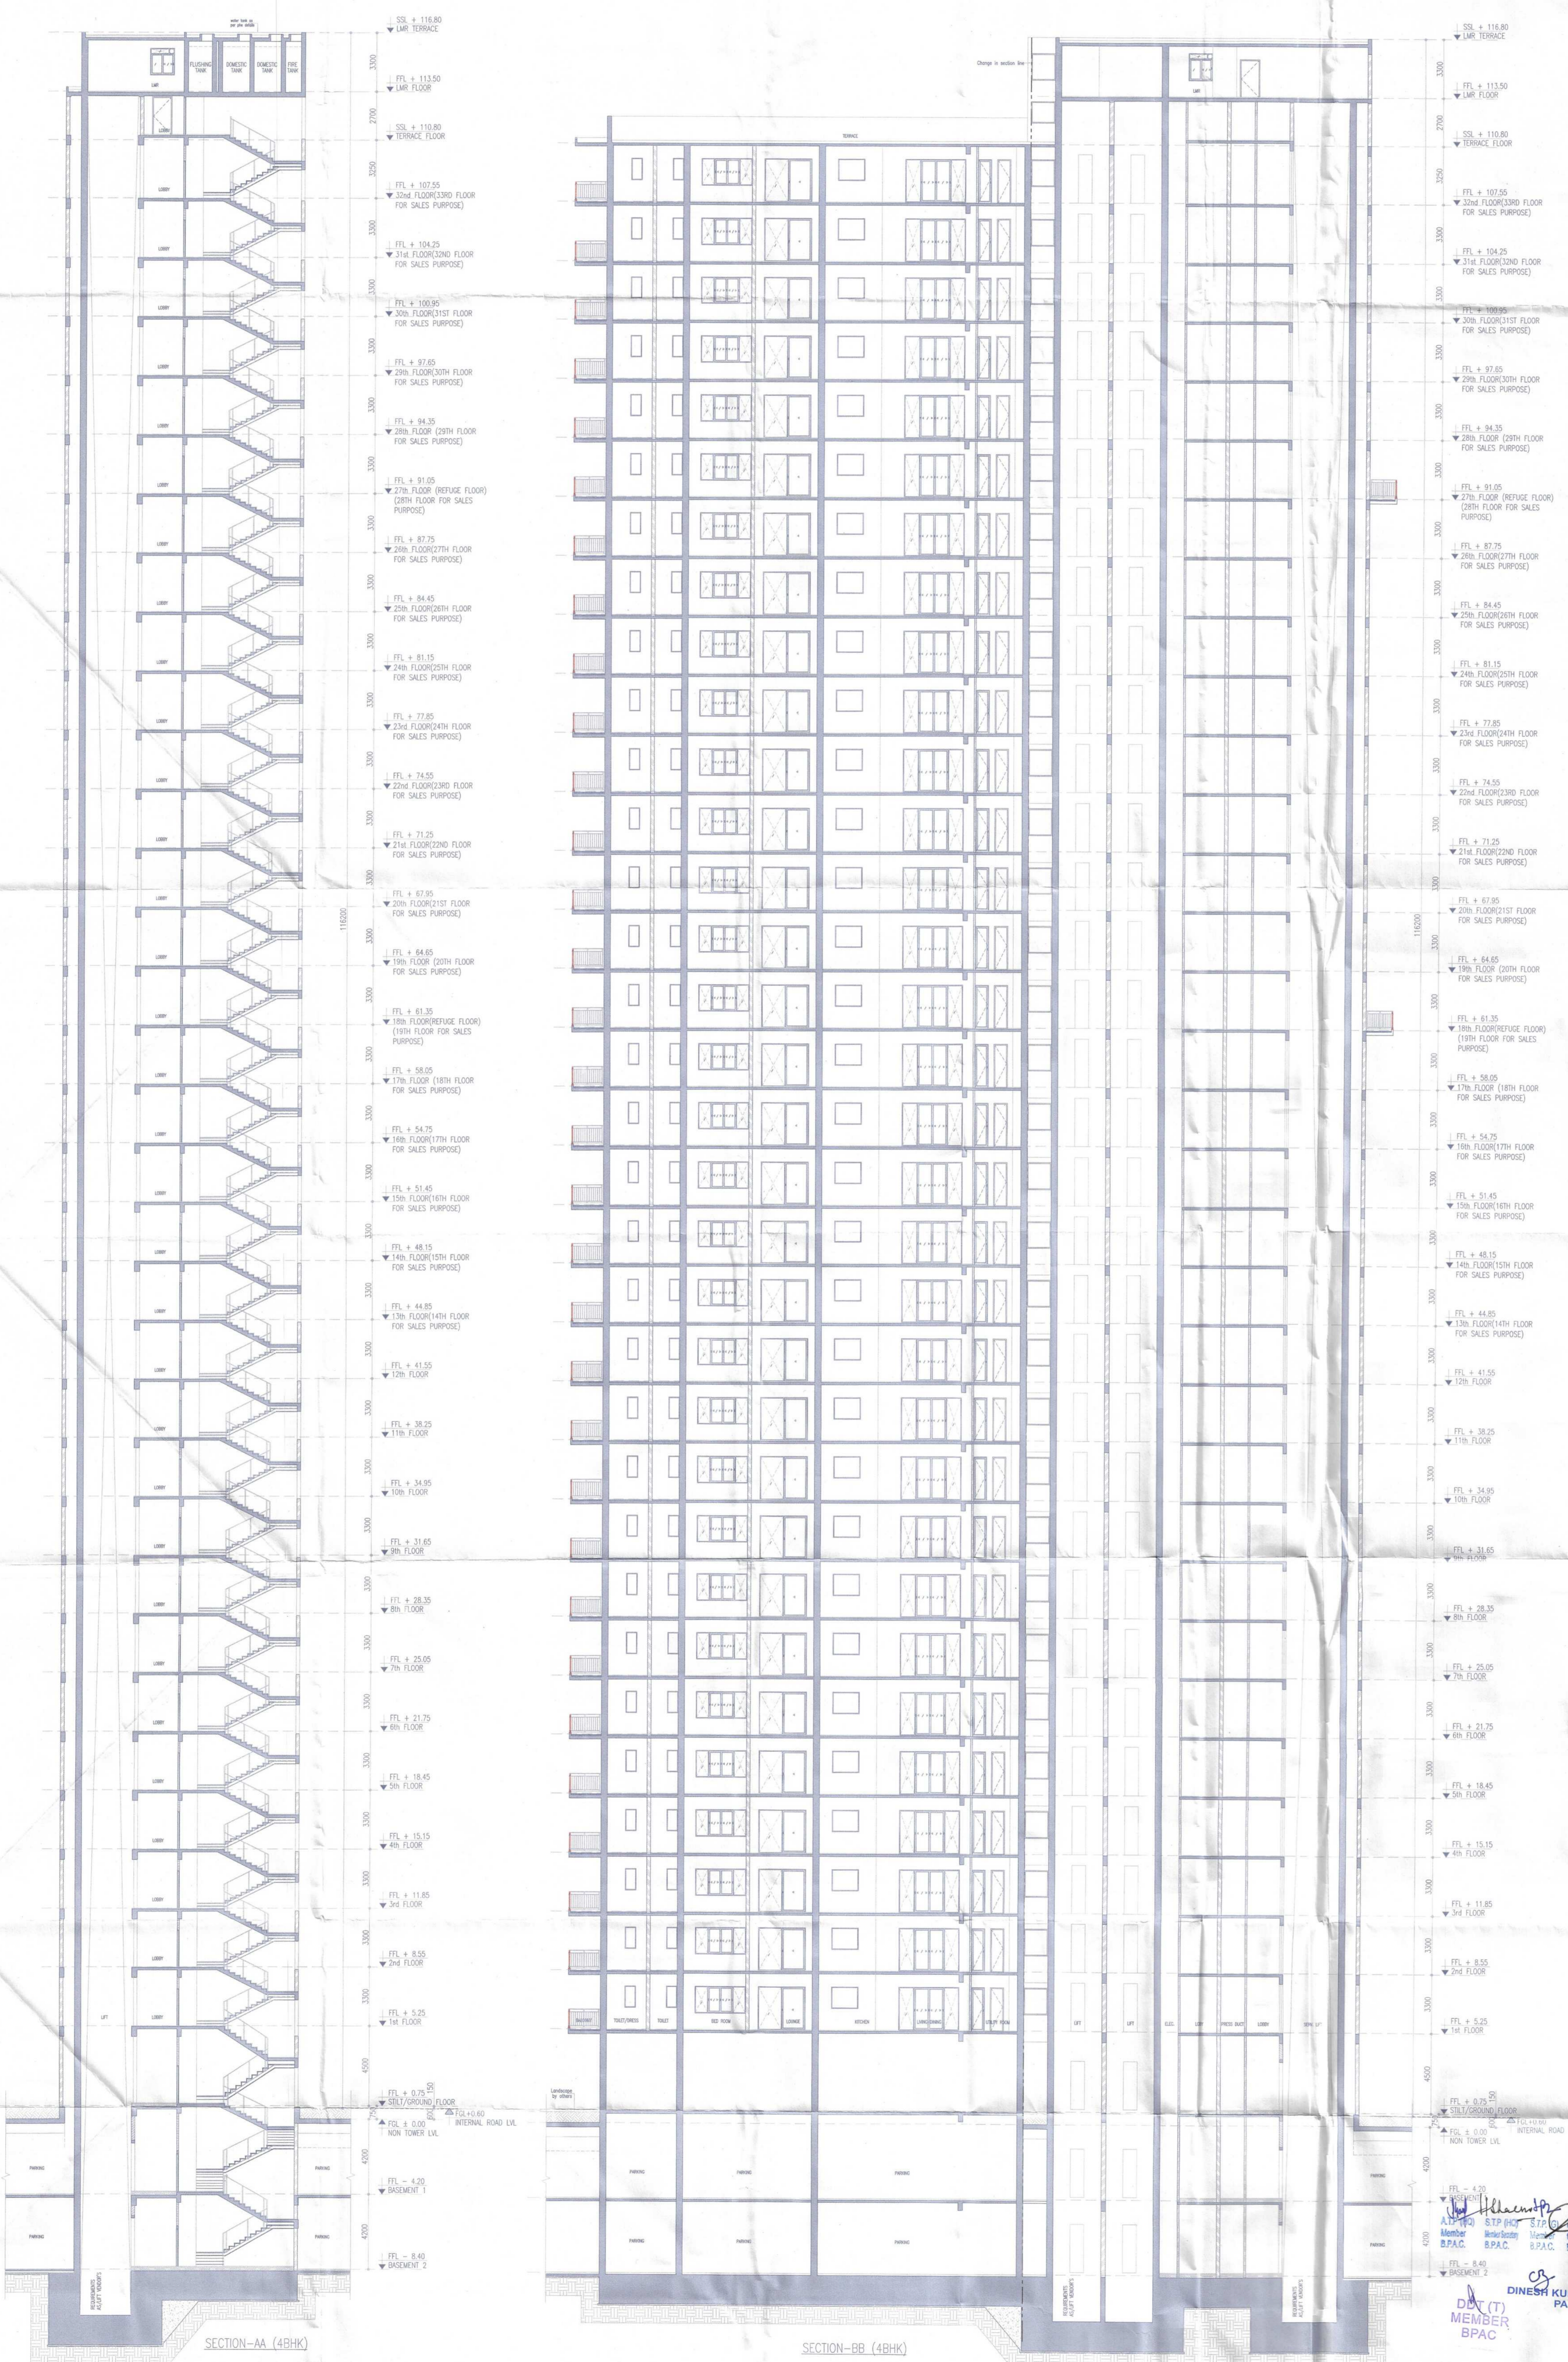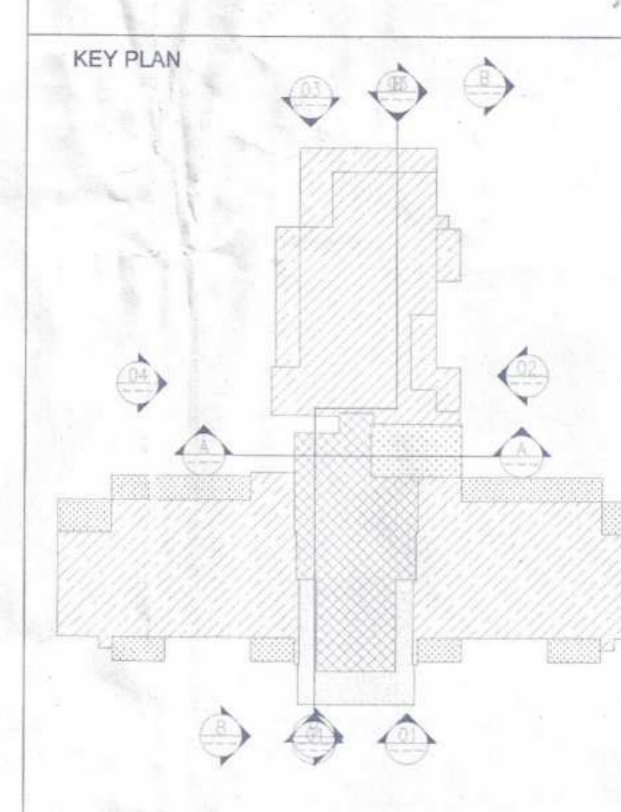

PROJECT:
 PROPOSED BUILDING PLAN OF GROUP HOUSING COLONY MEASURING 24.10 ACRES (LICENCE NO 80/01/2012 DATED 17/08/2012) IN SECTOR 106, GURUGRAM MANEVAR URBAN COMPLYING BEING DEVELOPED BY ARMD


OWNER'S SEAL & SIGNATURE:
 Airmid Developers Limited
 Authorized Signatory

ARCHITECT'S SEAL & SIGNATURE:
 AVINASH CHANDRA VAIDYA
 Architect No. CAP/0000000
 H. No. 163, PH-II
 New Paltan Vihar, Gurugram

DATE: AUG-2022
Scale: Drawing Title: TOWER-14 & 15 SECTION AA & BB
Drawing No.: A-11

SANCTIONED TO BE READ WITH THIS OFFICE MEMO NO. DATED:

- Note:-
- BUILDING HAS AUTOMATIC SPRINKLER SYSTEM WHEREVER REQUIRED BY NBC.
 - BUILDING WILL BE DESIGNED (STRUCTURES) AS PER RELEVANT IS CODES FOR EARTH QUAKE RESISTANCE.
 - WC SHALL BE MECHANICALLY LIGHT & VENTILATED WHEREVER REQUIRED.

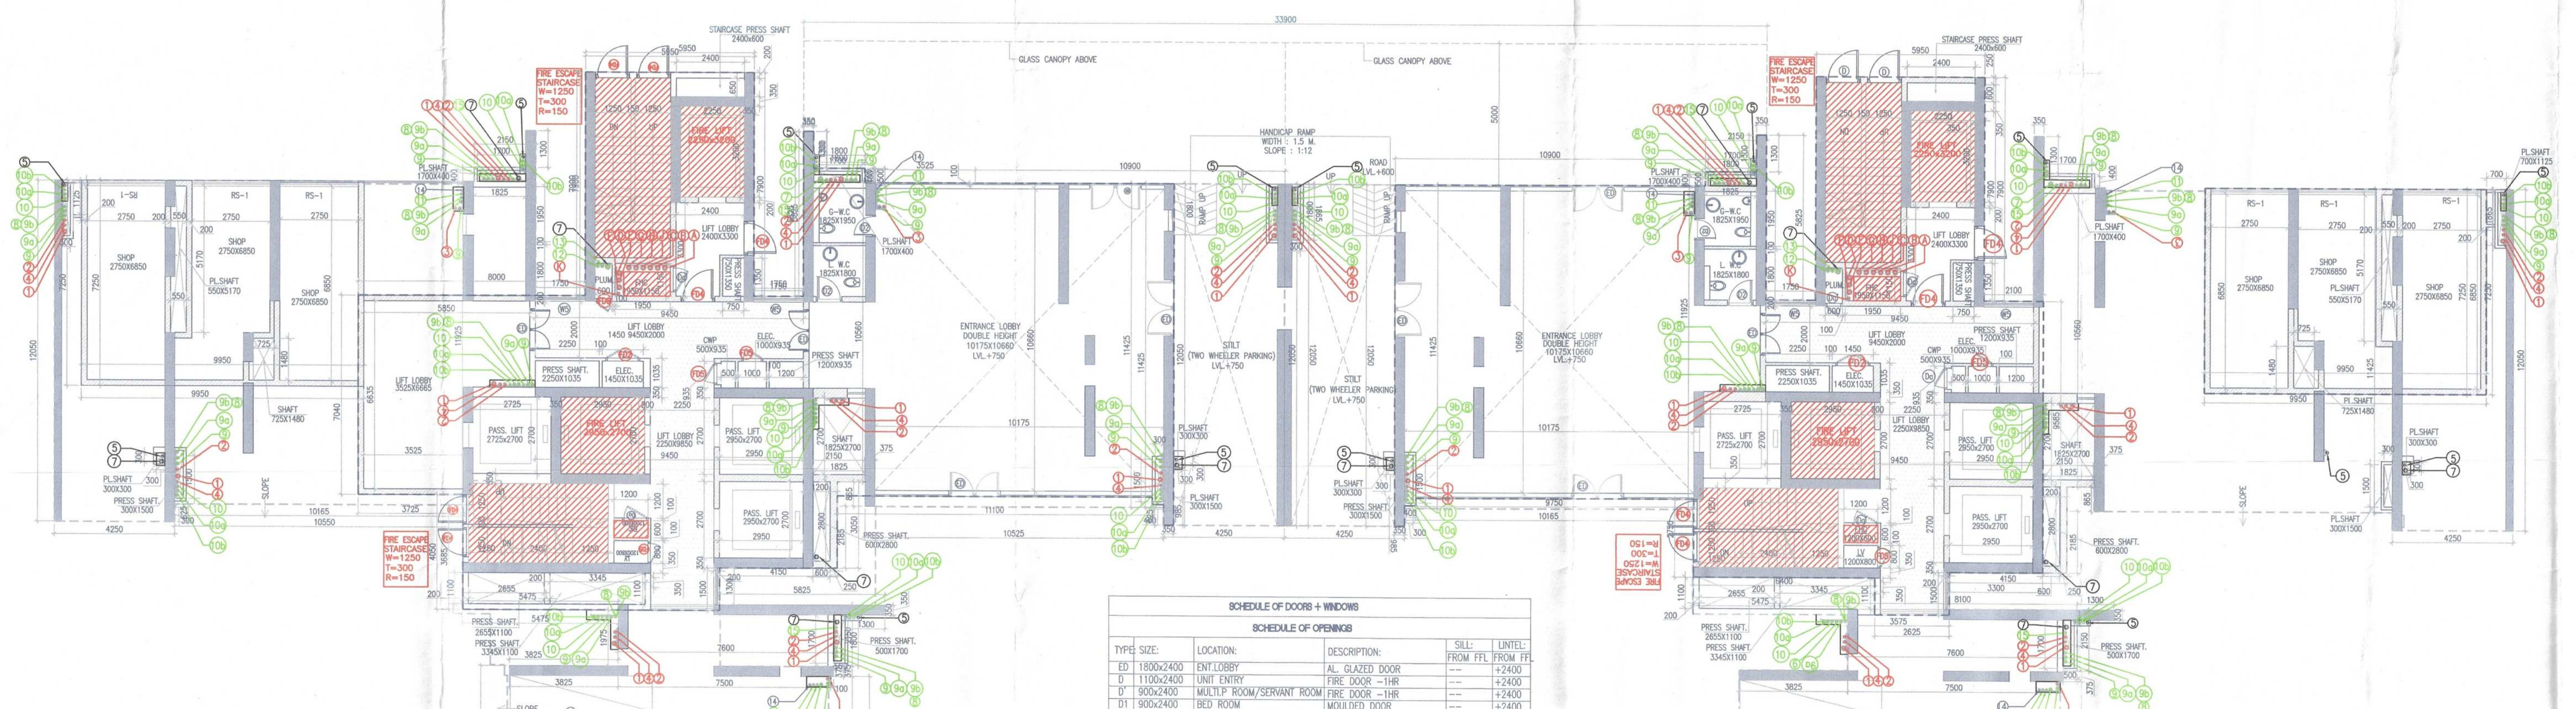


STILT/GROUND FLOOR
LVL +750
TOWER-2
(3BHK - STANDARD)

SCHEDULE OF DOORS + WINDOWS

TYPE	SIZE	LOCATION	DESCRIPTION	LEVEL	LEVEL
DB	1800x2400	ENT LOBBY	AL GLAZED DOOR	---	+2400
D	1100x2400	TIME ENTRY	FIRE DOOR - TIME	---	+2400
D	900x2400	MULTIP ROOM/SERVANT ROOM	FIRE DOOR - TIME	---	+2400
D1	1000x2400	BED ROOM	MOLDED DOOR	---	+2400
D1K	900x2400	KITCHEN	AL GLAZED DOOR	---	+2400
D2	900x2400	THC	MOLDED DOOR	---	+2400
D2A	750x2400	TOILET	MOLDED DOOR	---	+2400
D2B	750x2400	SERVANT ROOM	AL GLAZED DOOR	---	+2400
D01	1800x2400	DC RM/PUMP RM	DC-FIRE/Acoustics DOOR	---	+2400
D02	1200x2400	ELECTRICAL SHFT	EMERGENCY-FIRE DOOR	---	+2400
D03	1100x2400	REFURGE AREA	EM-METAL DOOR	---	+2400
D04	1100x2400	STAIRCASE/LIFT LOBBY	FIRE DOOR	---	+2400
FDS	750x2400	ELECTRICAL/RV/LV/CHP SHFT	FIRE DOOR	+100	+2400
FDS	500x2400	CHP	FIRE DOOR	+100	+2400
S01	4300x2400	BED ROOM	AL SLIDING DOOR	---	+2400
S02	4275x2400	LIVING/DINING	AL SLIDING DOOR	---	+2400
S03	4250x2400	LIVING/DINING	AL SLIDING DOOR	---	+2400
S04	3950x2400	BED ROOM/LIVING/DINING	AL SLIDING DOOR	---	+2400
S05	3700x2400	BED ROOM	AL SLIDING DOOR	---	+2400
S06	3550x2400	LIVING/DINING/LOUNGE	AL SLIDING DOOR	---	+2400
S07	3350x2400	LIVING/DINING	AL SLIDING DOOR	---	+2400
S08	3075x2400	BED ROOM	AL SLIDING DOOR	---	+2400
S09	2900x2400	BED ROOM	AL SLIDING DOOR	---	+2400
S10	2875x2400	BED ROOM	AL SLIDING DOOR	---	+2400
S11	2650x2400	BED ROOM	AL SLIDING DOOR	---	+2400
S12	1950x2400	BED ROOM	AL SLIDING DOOR	---	+2400
S13	1825x2400	BED ROOM	AL SLIDING DOOR	---	+2400
S14	1250x2400	MULTIP ROOM	AL SLIDING DOOR	---	+2400
DW	750x2400	DOOR	DOOR CLIM WINDOW	+1200	+2400
W1	2845x1500	BED ROOM	AL GLAZED WINDOW	+1900	+2400
W2	1500x1200	KITCHEN	AL GLAZED WINDOW	+1200	+2400
W3	1500x1500	LWB	AL GLAZED WINDOW	+1900	+2400
W4	1500x1500	STAIRCASE	AL GLAZED WINDOW	+1900	+2400
W5	1300x1500	LOBBY	LOWEEN WINDOW	+1900	+2400
W6	900x1500	BED ROOM	AL GLAZED WINDOW	+1900	+2400
V1	1600x1200	TOILET	VENTILATOR	+1200	+2400


STILT/GROUND FLOOR
LVL +750
TOWER-1
(3BHK STANDARD)

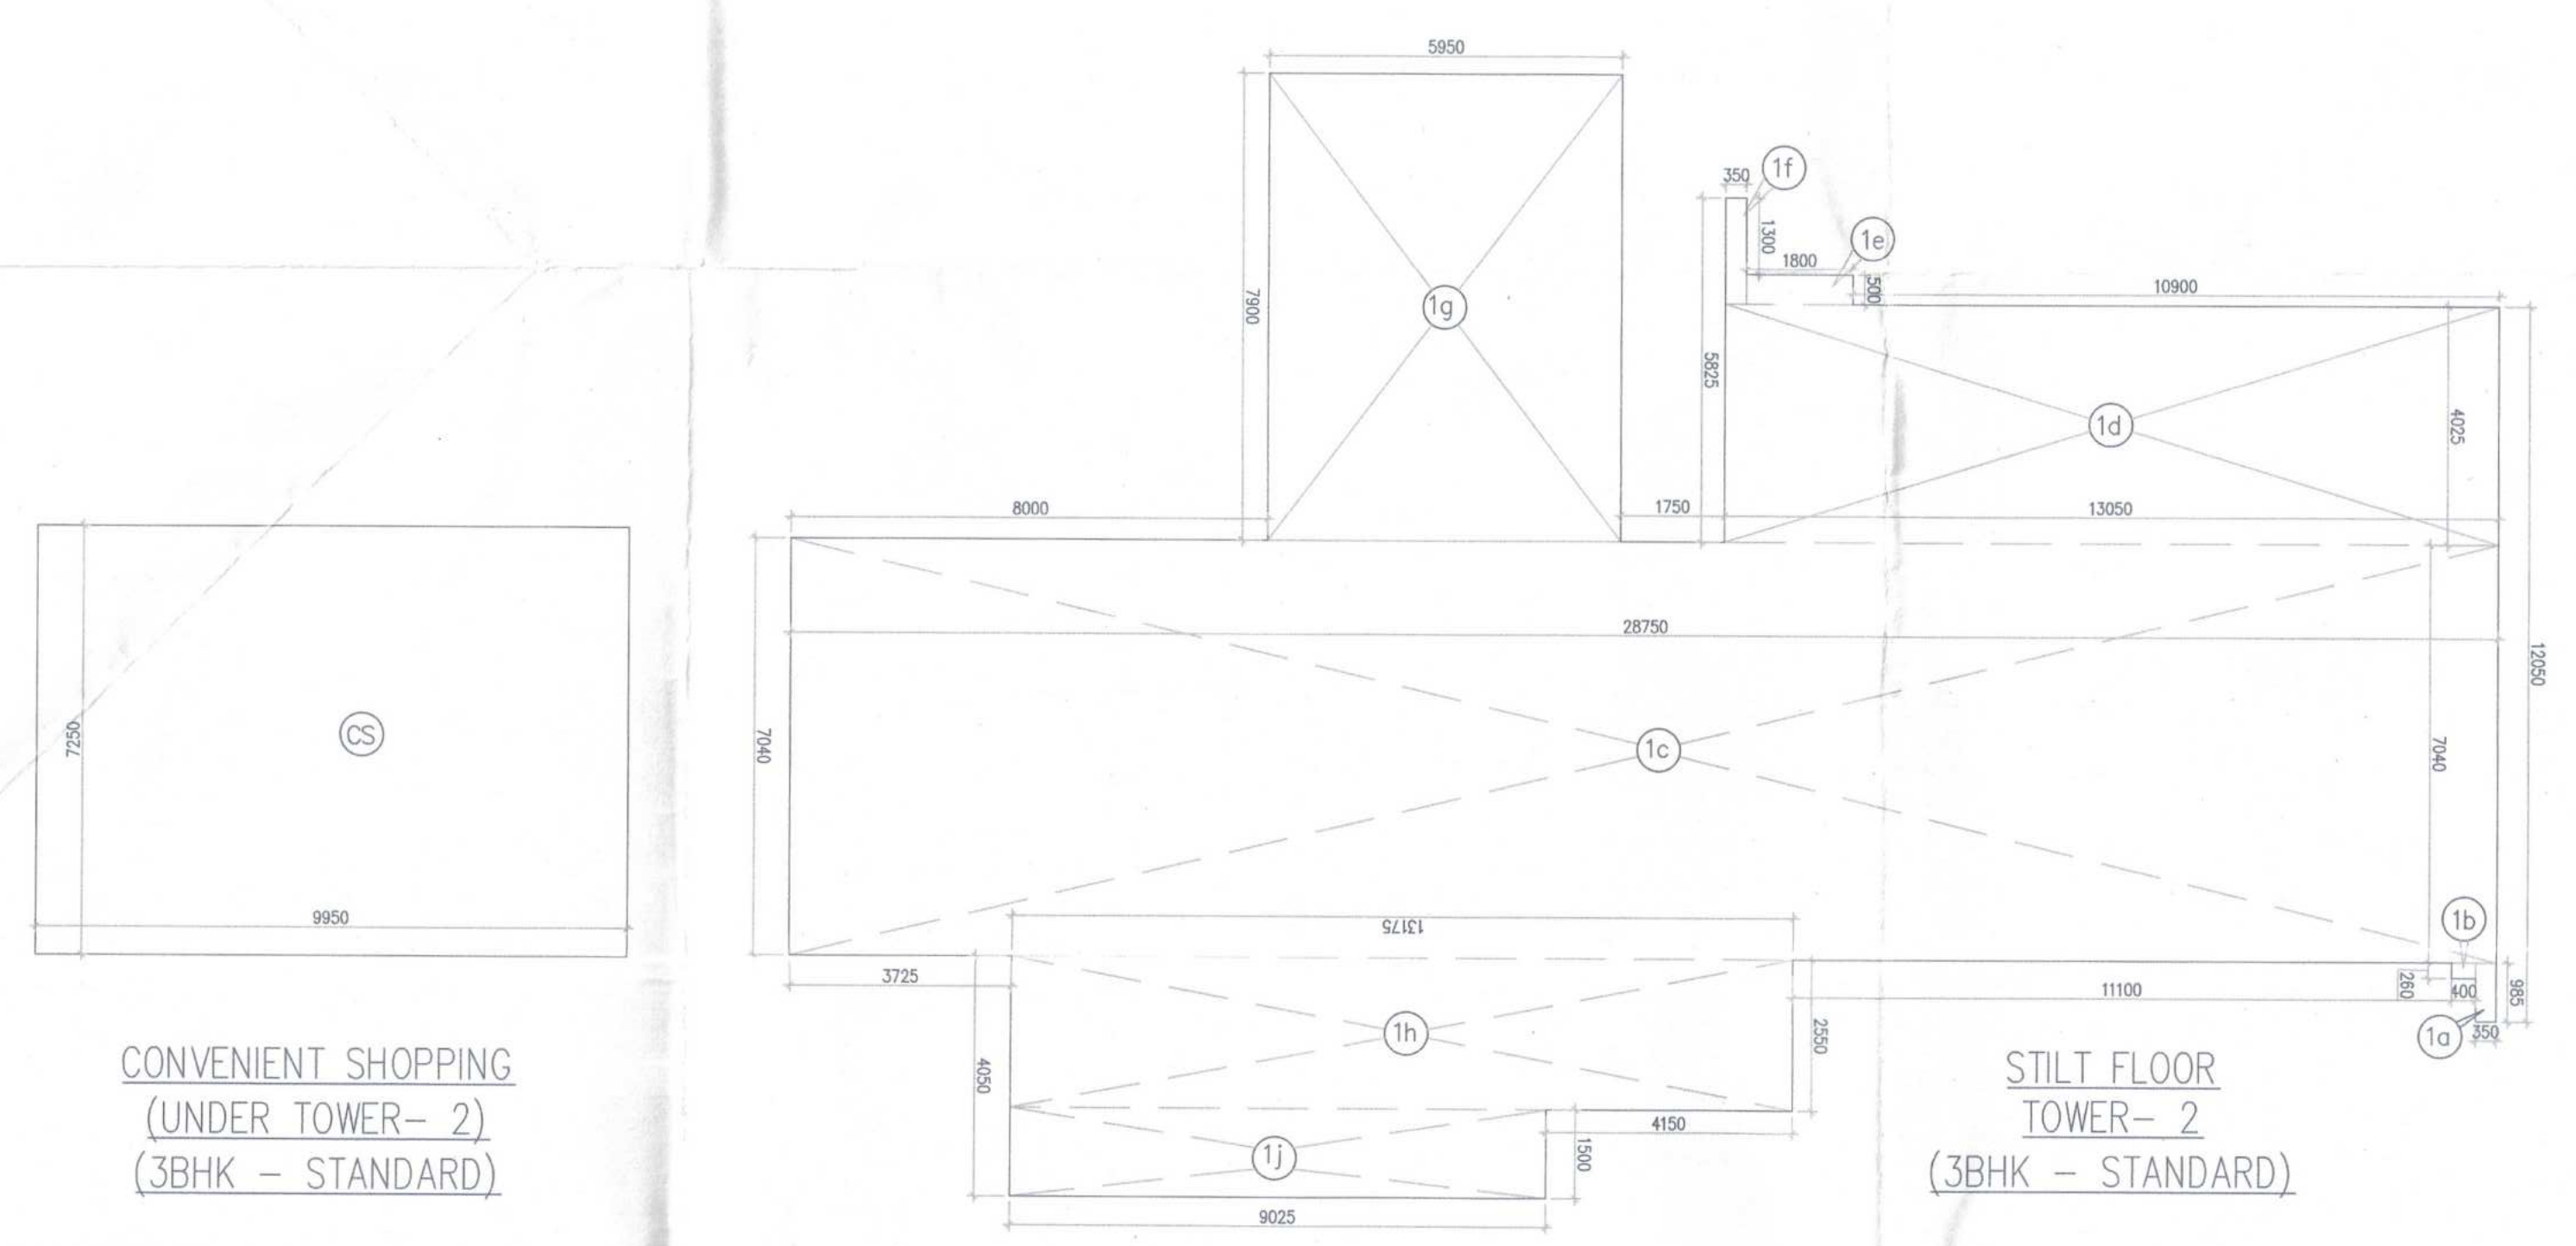

CONVENIENT SHOPPING
(UNDER TOWER-2)
(3BHK - STANDARD)

STILT FLOOR
TOWER-2
(3BHK - STANDARD)

CONVENIENT SHOPPING
(UNDER TOWER-1)

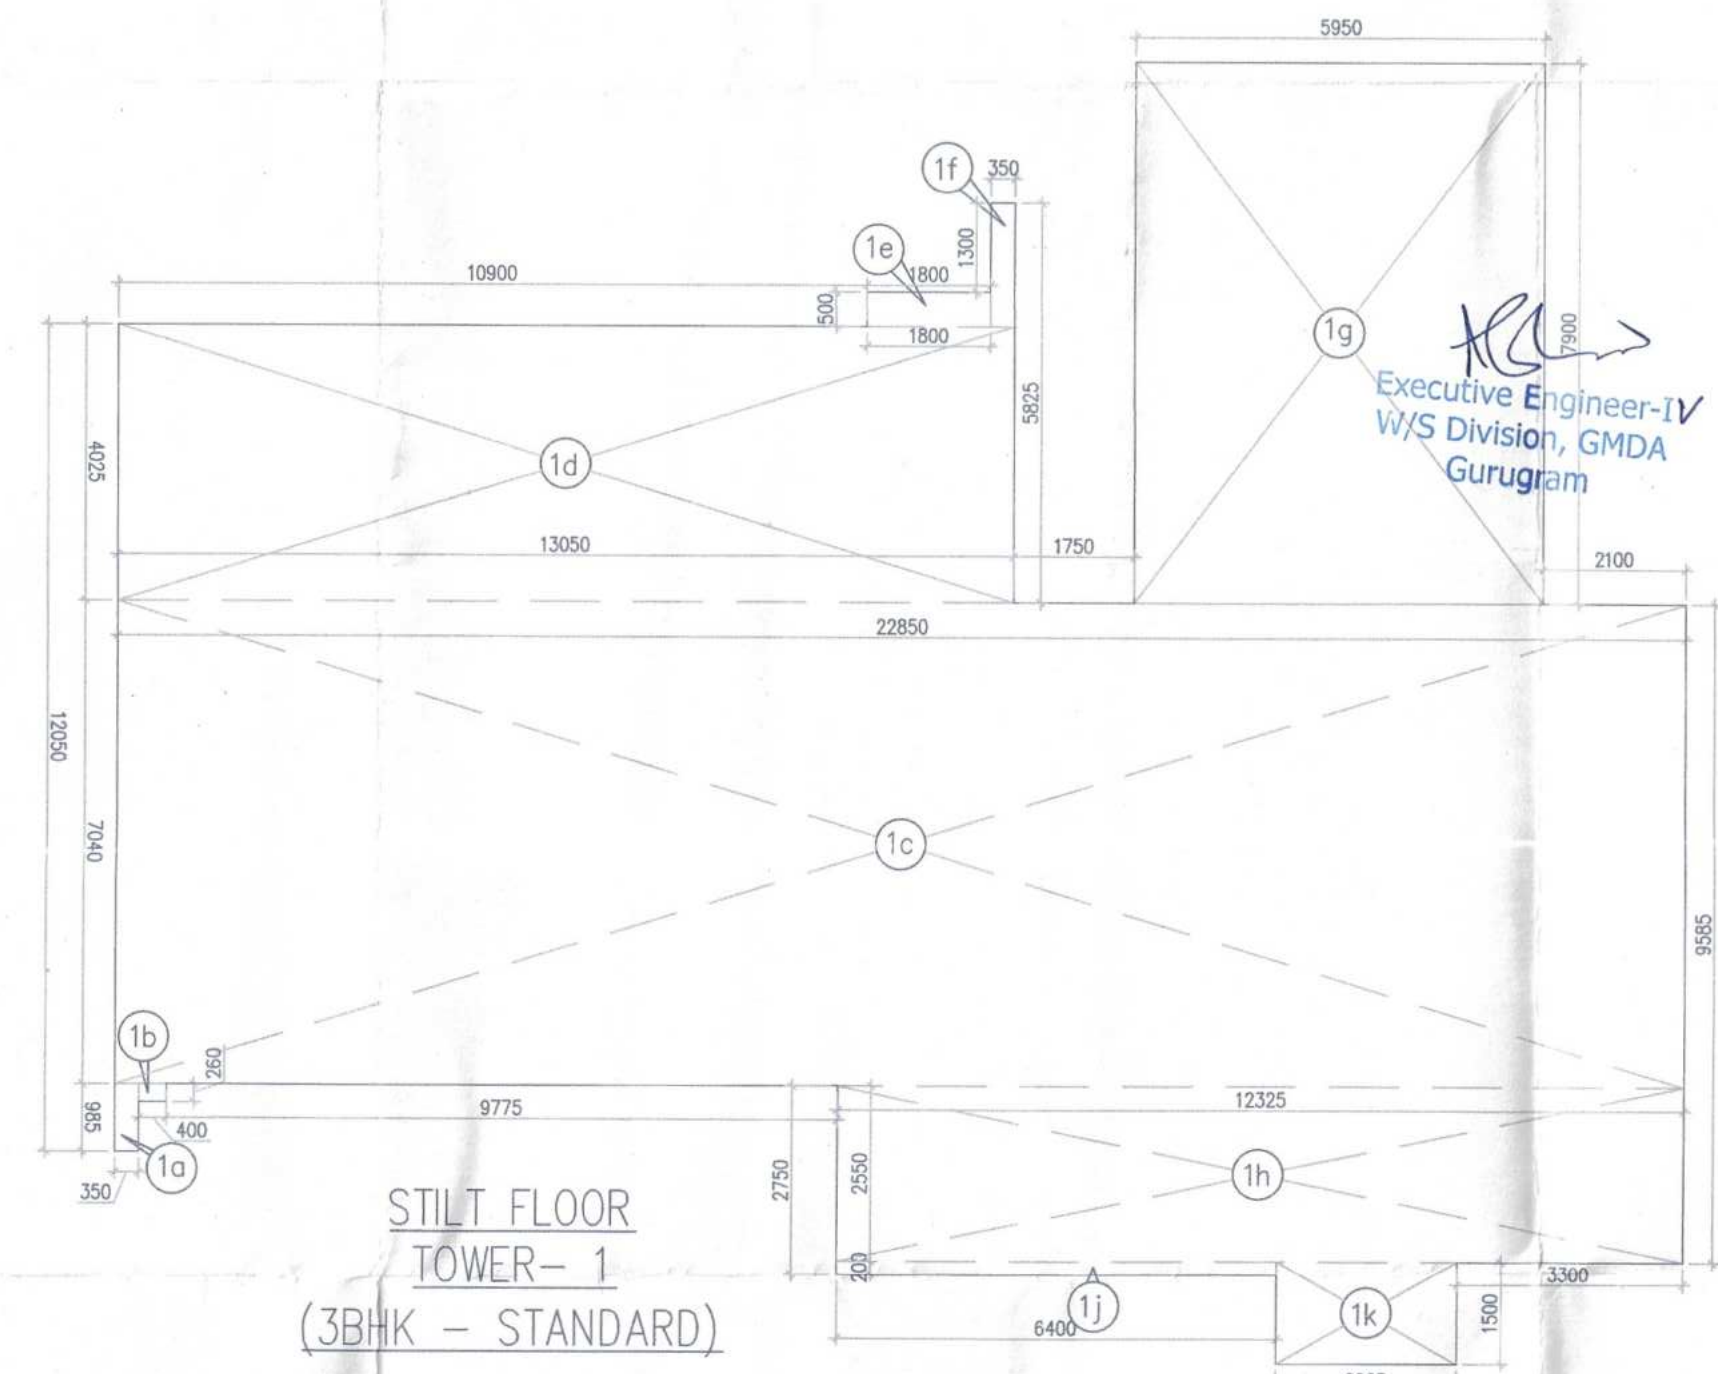

STILT FLOOR
TOWER-1
(3BHK - STANDARD)

CONVENIENT SHOPPING AREA CALCULATION (UNDER TOWER-2)

GROSS - CS	CS	CS	CS	CS	CS	CS	CS	CS	CS
1	1	1	1	1	1	1	1	1	1
TOTAL									72.138

STILT FLOOR AREA CALCULATION (TOWER-2)

GROSS - A	CS	CS	CS	CS	CS	CS	CS	CS	CS
1	1	1	1	1	1	1	1	1	1
TOTAL									350.869

FAR AREA OF STILT FLOOR (TOWER-2)

GROSS-A	CS	CS	CS	CS	CS	CS	CS	CS	CS
1	1	1	1	1	1	1	1	1	1
TOTAL									350.869

NON FAR'S TILT AREA (TOWER-2)

GROUND COVERAGE	FAR OF STILT
648.362	350.869
TOTAL	497.493

NO OF CAR ACHIEVABLE OF (TOWER-2)

CARS	OR SAT
28	18

CONVENIENT SHOPPING AREA CALCULATION (UNDER TOWER-1)

GROSS - CS	CS	CS	CS	CS	CS	CS	CS	CS	CS
1	1	1	1	1	1	1	1	1	1
TOTAL									72.138

STILT FLOOR AREA CALCULATION (TOWER-1)

GROSS - A	CS	CS	CS	CS	CS	CS	CS	CS	CS
1	1	1	1	1	1	1	1	1	1
TOTAL									298.845

FAR AREA OF STILT FLOOR (TOWER-1)

GROSS-A	CS	CS	CS	CS	CS	CS	CS	CS	CS
1	1	1	1	1	1	1	1	1	1
TOTAL									298.845

NON FAR'S TILT AREA (TOWER-1)

GROUND COVERAGE	FAR OF STILT
648.362	298.845
TOTAL	648.517

NO OF CAR ACHIEVABLE OF (TOWER-1)

CARS	OR SAT
28	20

Building Plans have been checked and found in order as per Public Health Services point of view.

Executive Engineer-V, Sew. Division, GMDA, Gurugram

Executive Engineer-III, Drainage Division, GMDA, Gurugram

Chief Engineer, (Infra-4), GMDA Gurugram

Sanctioned by
DINESH KUMAR PA(HQ)
DDT MEMBER BPAC

TO BE READ WITH THIS OFFICE MEMO NO. DATED:


PROJECT:
PROPOSED BUILDING PLAN OF GROUP HOUSING COLONY MEASURING 24.10 ACRES (LICENCE NO 80 OF 2012 DATED 17/08/2012) IN SECTOR 106, GURUGRAM MANESAR URBAN COMPLEX BEING DEVELOPED BY AIRMD DEVELOPERS LTD. & OTHERS.

OWNER'S SEAL & SIGNATURE

ARCHITECT'S SEAL & SIGNATURE

AVINASH CHANDRA VAIDYA
Architect No. CA/050005
H. No. 163, PH-II,
New Palm Vihar, Gurugram

AUG-2022 Scale : 1:100
Drawing Title: TOWER-1 & 2
STILT/GROUND FLOOR PLAN & FAR AREA CALCULATION, DIAGRAM, CONVENIENT SHOPPING PLAN & AREA DETAILS.
Drawing No.: B-01

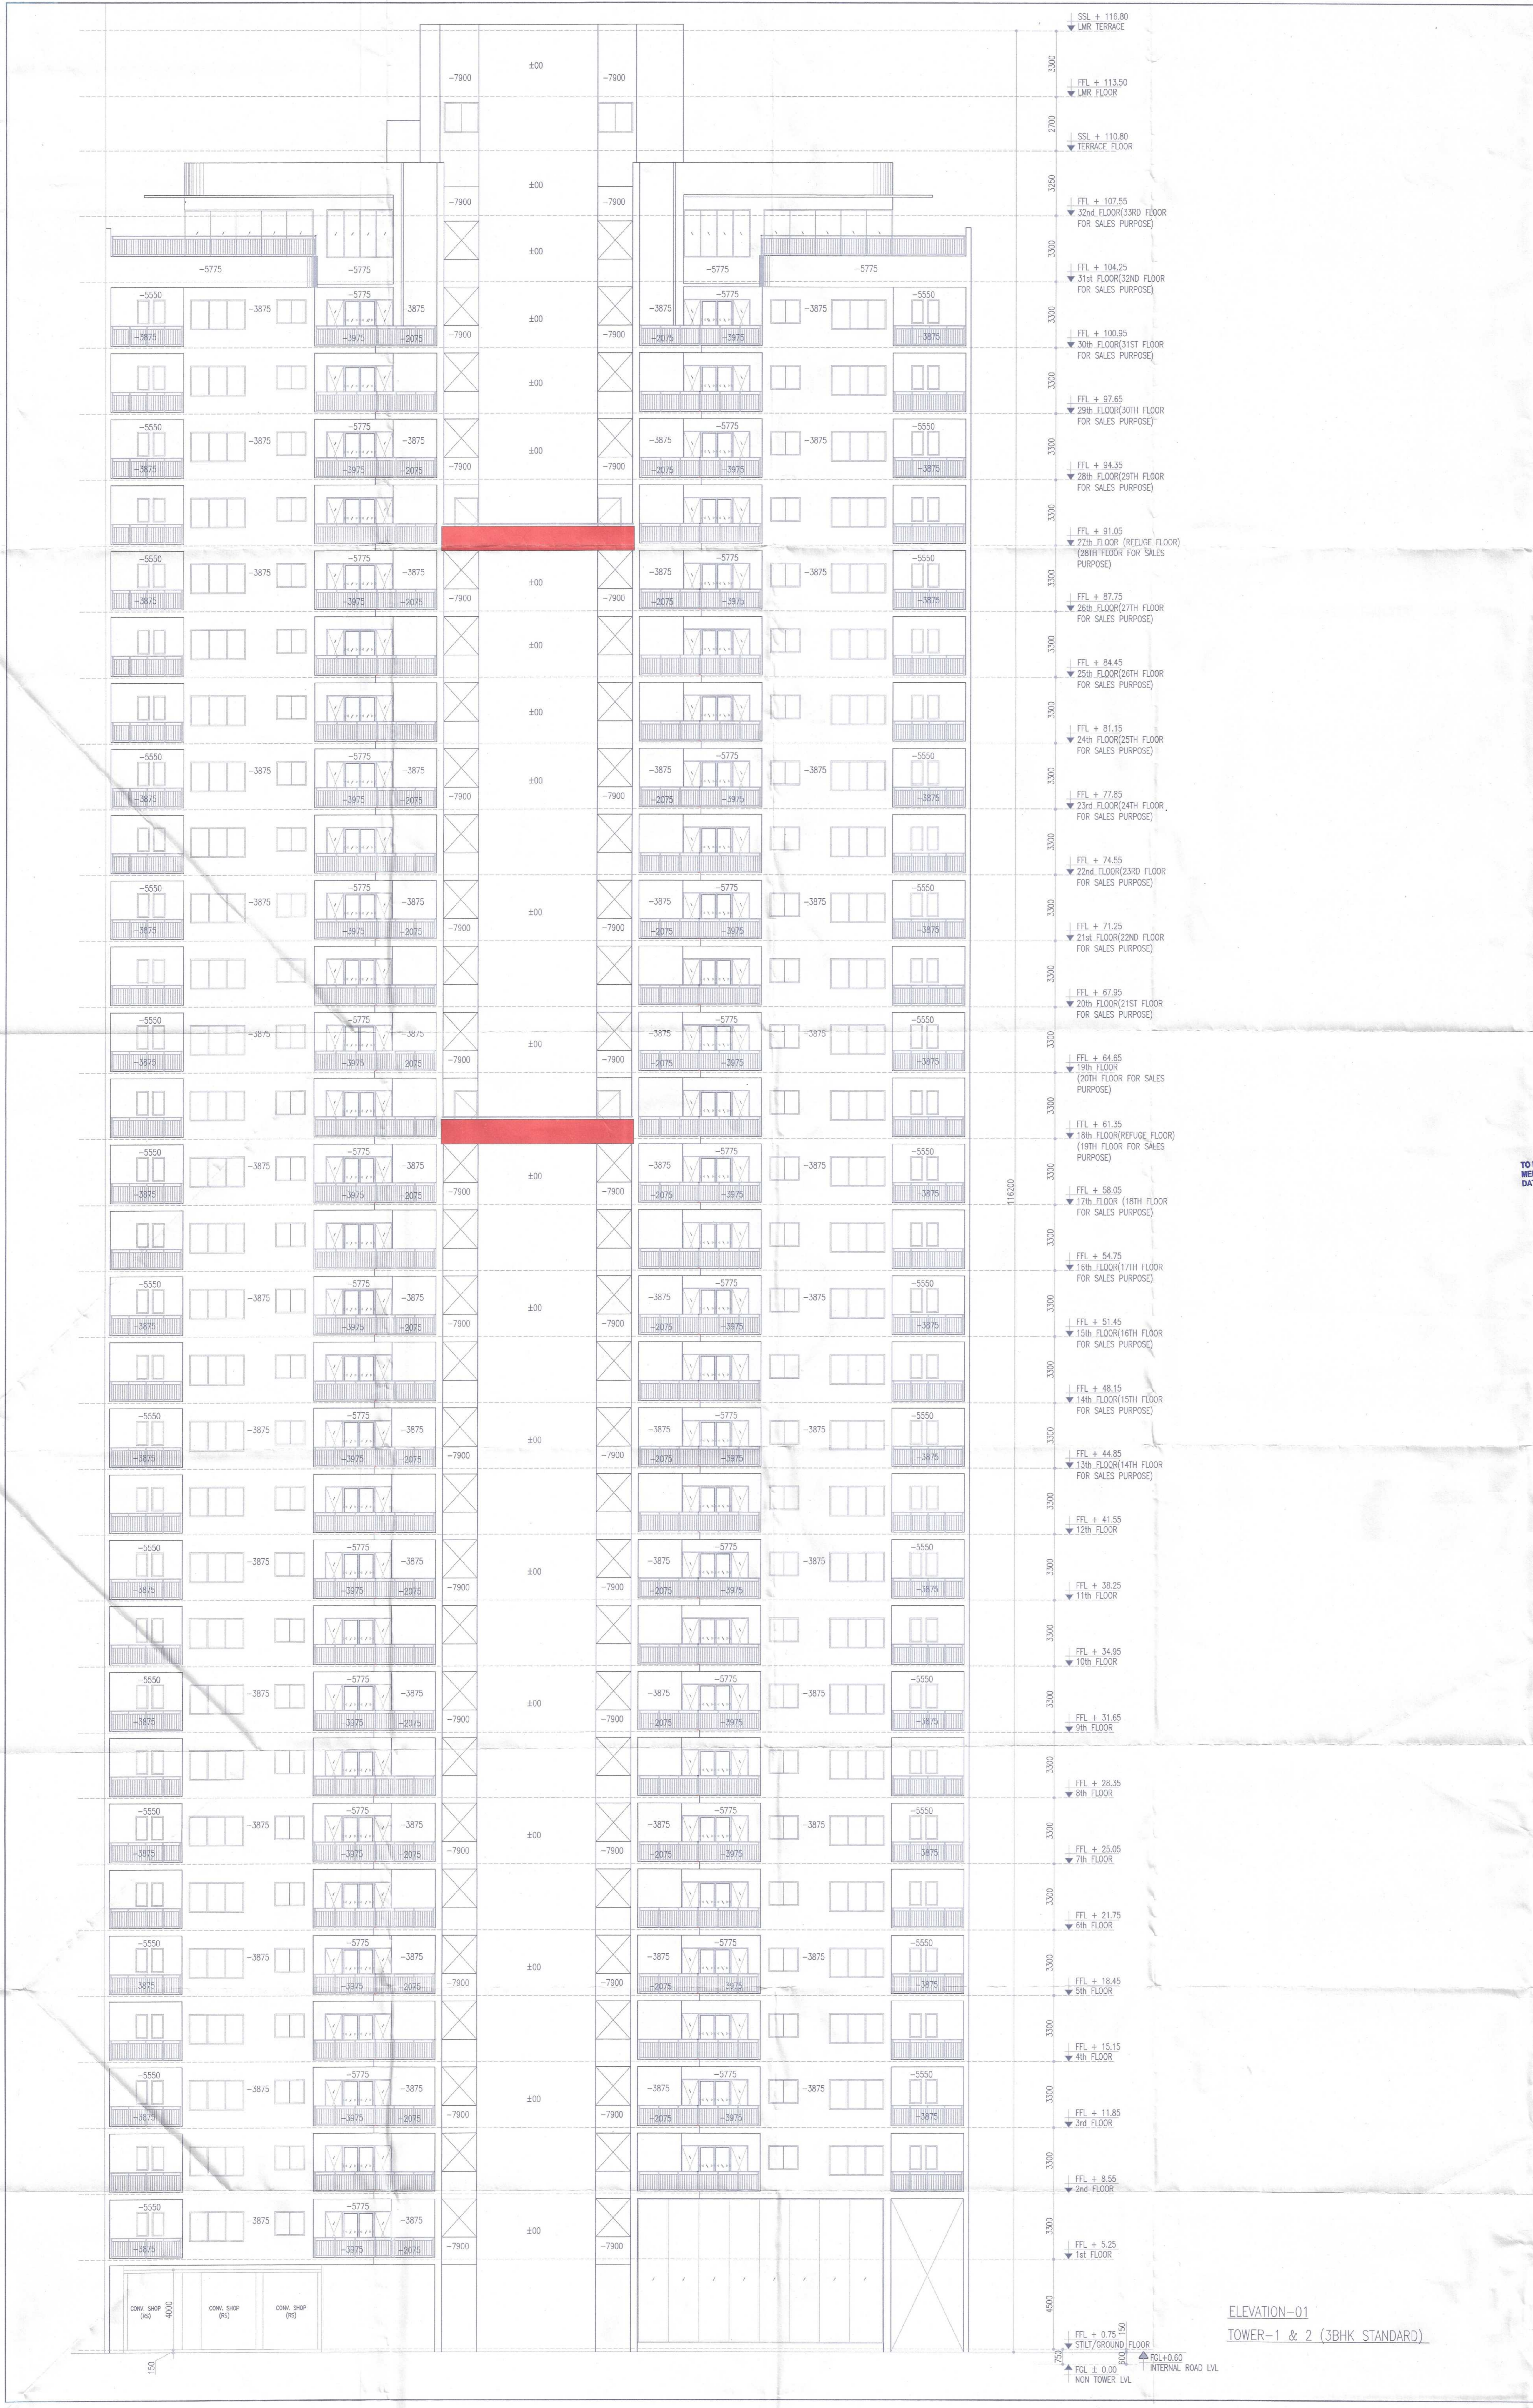

Note:-

- BUILDING HAS AUTOMATIC SPRINKLER SYSTEM WHEREVER REQUIRED BY NBC.
- BUILDING WILL BE DESIGNED (STRUCTURES) AS PER RELEVANT IS CODES FOR EARTH QUAKE RESISTANCE.

KEY PLAN

FFL + 116.80
LNR TERRACE

FFL + 113.50
LNR FLOOR

SSL + 116.80
TERRACE FLOOR

FFL + 107.55
32nd FLOOR(33RD FLOOR FOR SALES PURPOSE)

FFL + 104.25
31st FLOOR(32ND FLOOR FOR SALES PURPOSE)

FFL + 100.95
30th FLOOR(31ST FLOOR FOR SALES PURPOSE)

FFL + 97.65
29th FLOOR(30TH FLOOR FOR SALES PURPOSE)

FFL + 94.35
28th FLOOR(29TH FLOOR FOR SALES PURPOSE)

FFL + 91.05
27th FLOOR (REFUGE FLOOR)
(28TH FLOOR FOR SALES PURPOSE)

FFL + 87.75
26th FLOOR(27TH FLOOR FOR SALES PURPOSE)

FFL + 84.45
25th FLOOR(26TH FLOOR FOR SALES PURPOSE)

FFL + 81.15
24th FLOOR(25TH FLOOR FOR SALES PURPOSE)

FFL + 77.85
23rd FLOOR(24TH FLOOR FOR SALES PURPOSE)

FFL + 74.55
22nd FLOOR(23RD FLOOR FOR SALES PURPOSE)

FFL + 71.25
21st FLOOR(22ND FLOOR FOR SALES PURPOSE)

FFL + 67.95
20th FLOOR(21ST FLOOR FOR SALES PURPOSE)

FFL + 64.65
19th FLOOR
(20TH FLOOR FOR SALES PURPOSE)

FFL + 61.35
18th FLOOR(REFUGE FLOOR)
(19TH FLOOR FOR SALES PURPOSE)

FFL + 58.05
17th FLOOR (18TH FLOOR FOR SALES PURPOSE)

FFL + 54.75
16th FLOOR(17TH FLOOR FOR SALES PURPOSE)

FFL + 51.45
15th FLOOR(16TH FLOOR FOR SALES PURPOSE)

FFL + 48.15
14th FLOOR(15TH FLOOR FOR SALES PURPOSE)

FFL + 44.85
13th FLOOR(14TH FLOOR FOR SALES PURPOSE)

FFL + 41.55
12th FLOOR

FFL + 38.25
11th FLOOR

FFL + 34.95
10th FLOOR

FFL + 31.65
9th FLOOR

FFL + 28.35
8th FLOOR

FFL + 25.05
7th FLOOR

FFL + 21.75
6th FLOOR

FFL + 18.45
5th FLOOR

FFL + 15.15
4th FLOOR

FFL + 11.85
3rd FLOOR

FFL + 8.55
2nd FLOOR

FFL + 5.25
1st FLOOR

FFL + 0.75
STLT/GROUND FLOOR

FFL ± 0.00
NON TOWER LVL

FFL + 0.60
INTERNAL ROAD LVL

Sanctioned to be read with this office memo No. DATED: _____

(Signature)
A.T.P. (P) Member B.P.A.C.
S.T.P. (P) Member B.P.A.C.
S.T.P. (P) Member B.P.A.C.

(Signature)
DINESH KUMAR (A/HQ)
D.N.T. MEMBER B.P.A.C.

PROJECT:

PROPOSED BUILDING PLAN OF GROUP HOUSING COLONY MEASURING 24.10 ACRES (LICENCE NO 80 OF 2012 DATED 17/08/2012) IN SECTOR 106, GURUGRAM MANESAR URBAN COMPLEX BEING DEVELOPED BY AIRMID DEVELOPERS LTD. & OTHERS.

OWNER'S SEAL & SIGNATURE

(Signature)
Airmid Developers Limited
Authorised Signatory

ARCHITECT'S SEAL & SIGNATURE


(Signature)
ANISH CHETIA
Architect No. U-1/502008
H.No. 163, PH-II
New Palam Vihar, Gurugram

AUG-2022 Scale: 1:100

Drawing Title: TOWER-1 & 2 ELEVATION-1

Drawing No: B-07

ELEVATION-01
TOWER-1 & 2 (3BHK STANDARD)

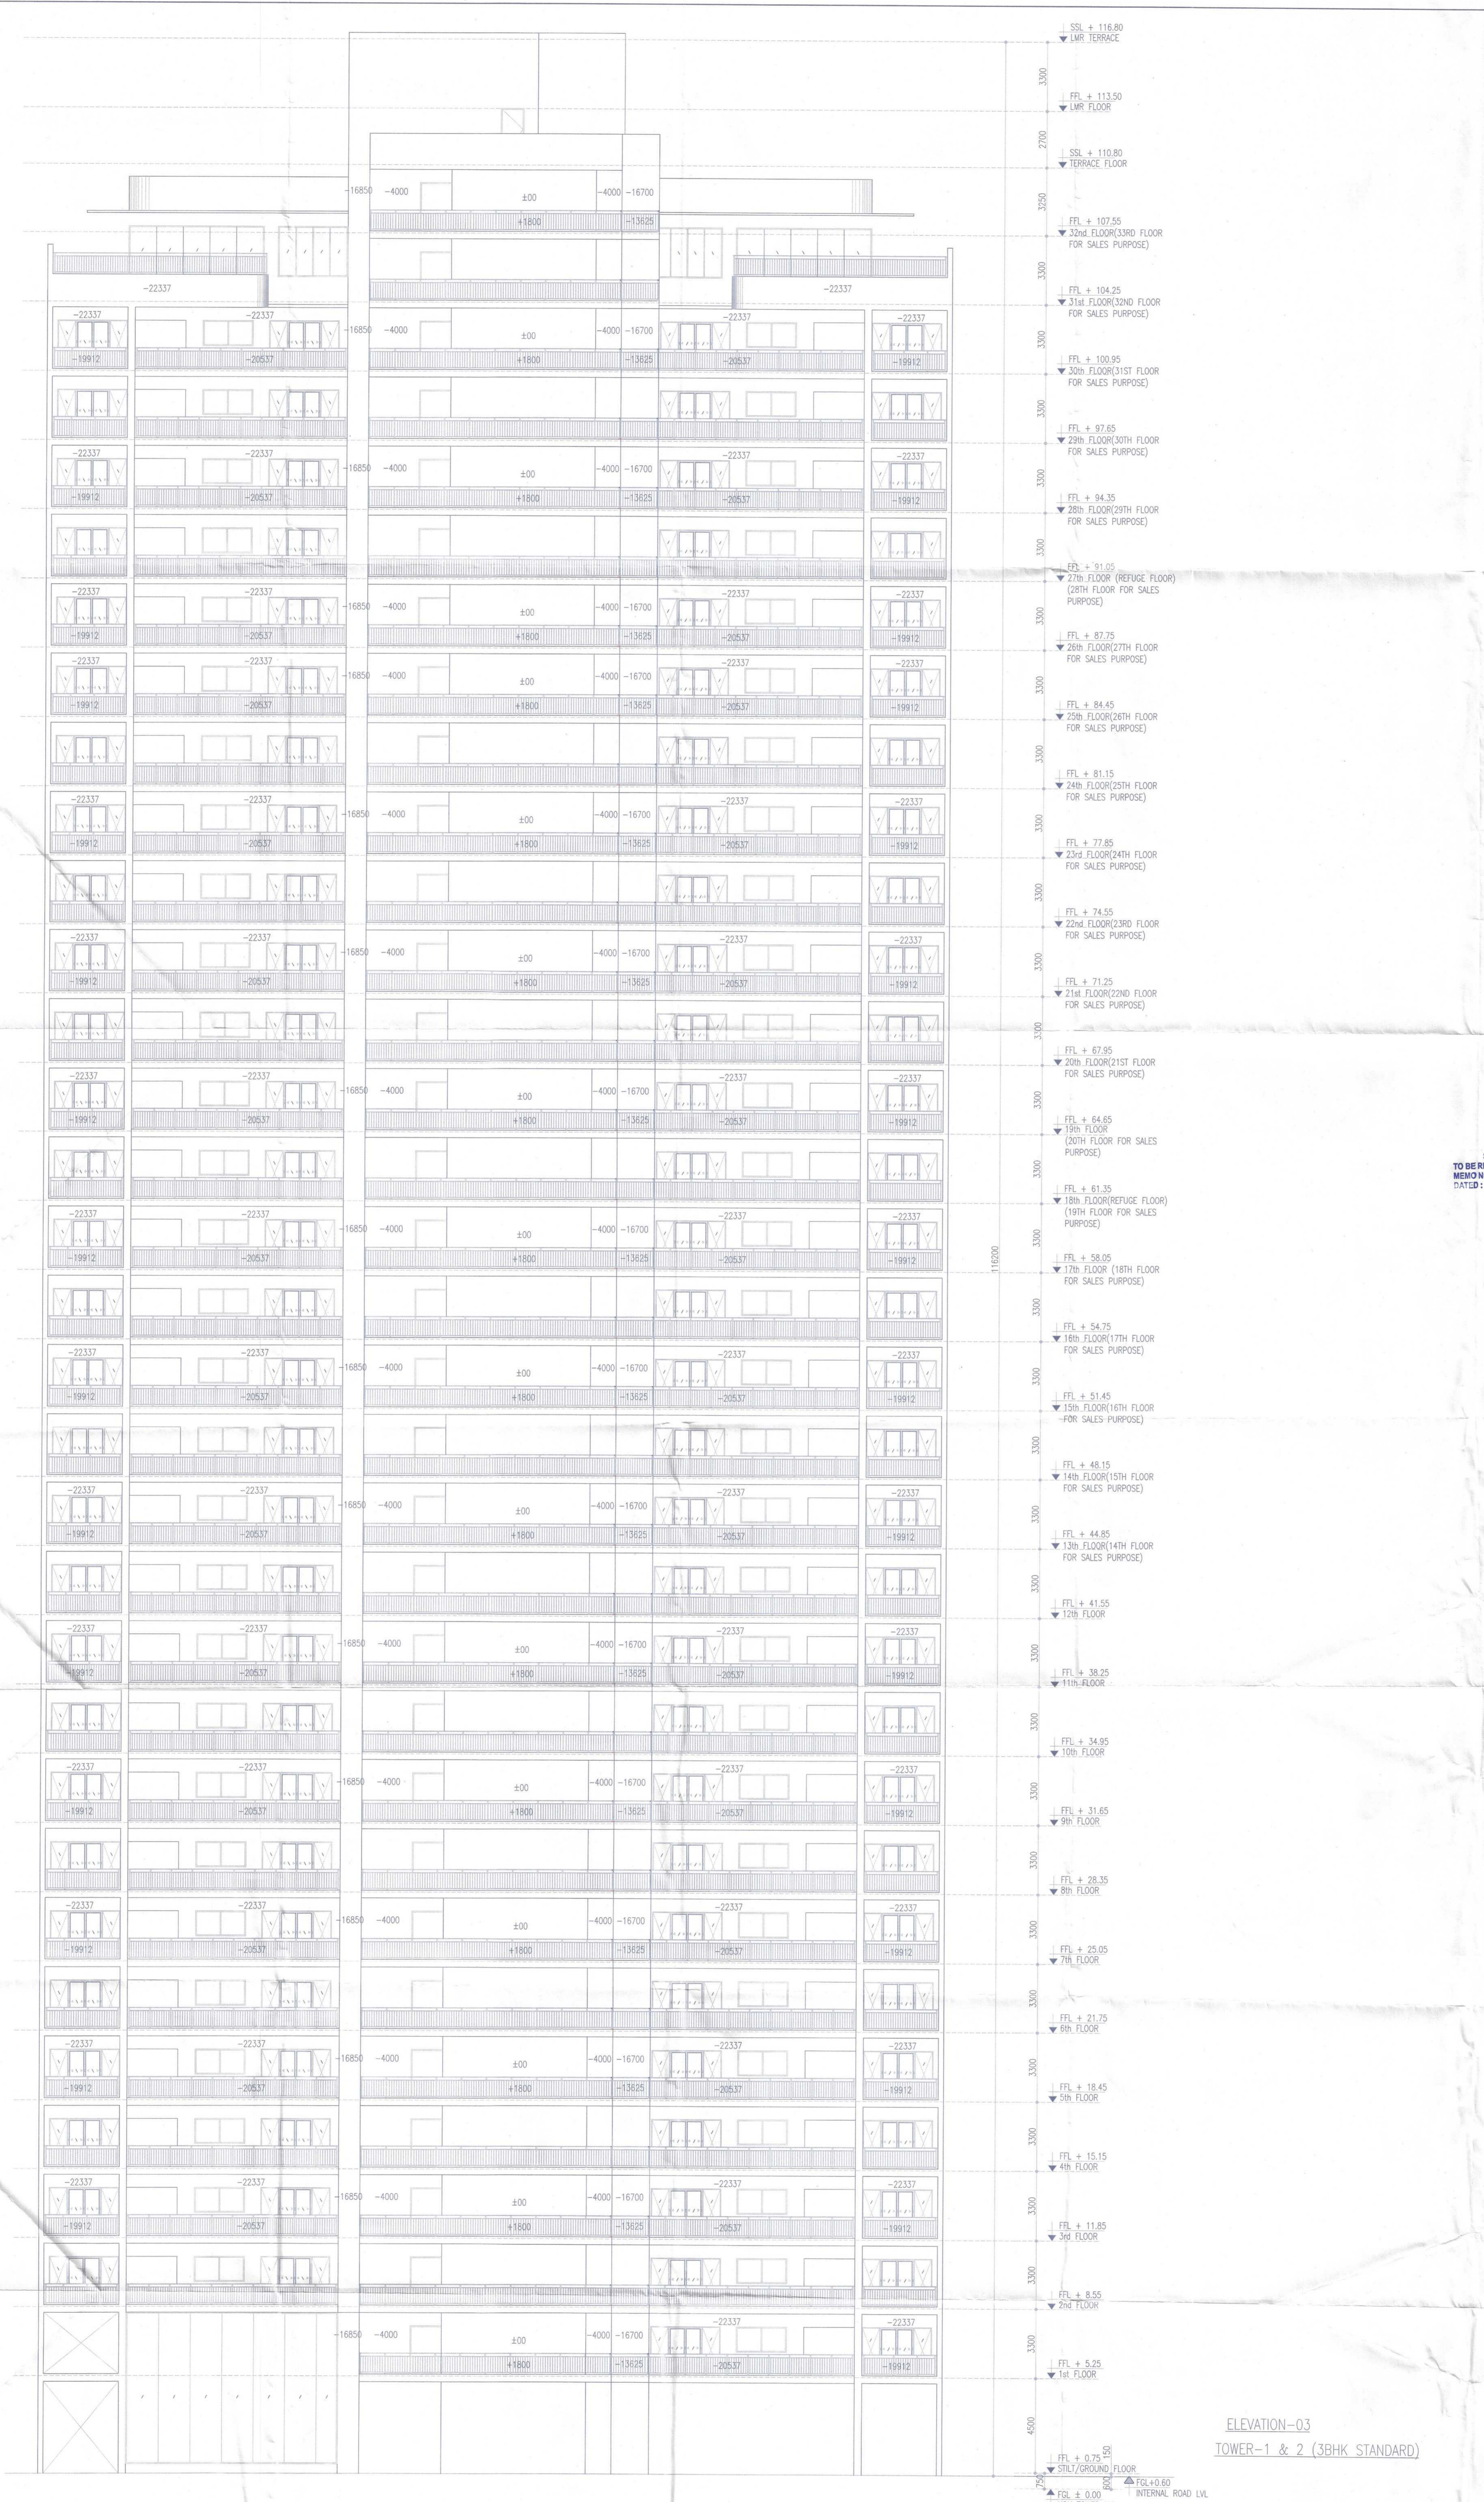

Note:-

- BUILDING HAS AUTOMATIC SPRINKLER SYSTEM WHEREVER REQUIRED BY NBC.
- BUILDING WILL BE DESIGNED (STRUCTURES) AS PER RELEVANT IS CODES FOR EARTH QUAKE RESISTANCE.

KEY PLAN

TO BE READ WITH THIS OFFICE MEMO NO. DATED:

SANCTIONED

DINESH KUMAR PATHAK
 MEMBER B.P.A.C.

J.D.

P.A.

A.T.P.

MEMBER B.P.A.C.

PROJECT:

PROPOSED BUILDING PLAN OF GROUP HOUSING COLONY MEASURING 24.10 ACRES (LICENCE NO 80 OF 2012 DATED 17/08/2012) IN SECTOR 106, GURUGRAM MANESAR URBAN COMPLEX BEING DEVELOPED BY AIRMID DEVELOPERS LTD. & OTHERS.

OWNER'S SEAL & SIGNATURE

Airmid Developers Limited

ARCHITECT'S SEAL & SIGNATURE


ANVISH CHANDRA VAIDYA
 Architect No. CA/7502006
 H. No. 163, PH-II
 New Palm Vihar, Gurgaon

AUG.-2022. Scale : 1:100

Drawing Title:- **TOWER-1 & 2 ELEVATION-3**

Drawing No:- **B-09**

ELEVATION-03
TOWER-1 & 2 (3BHK STANDARD)

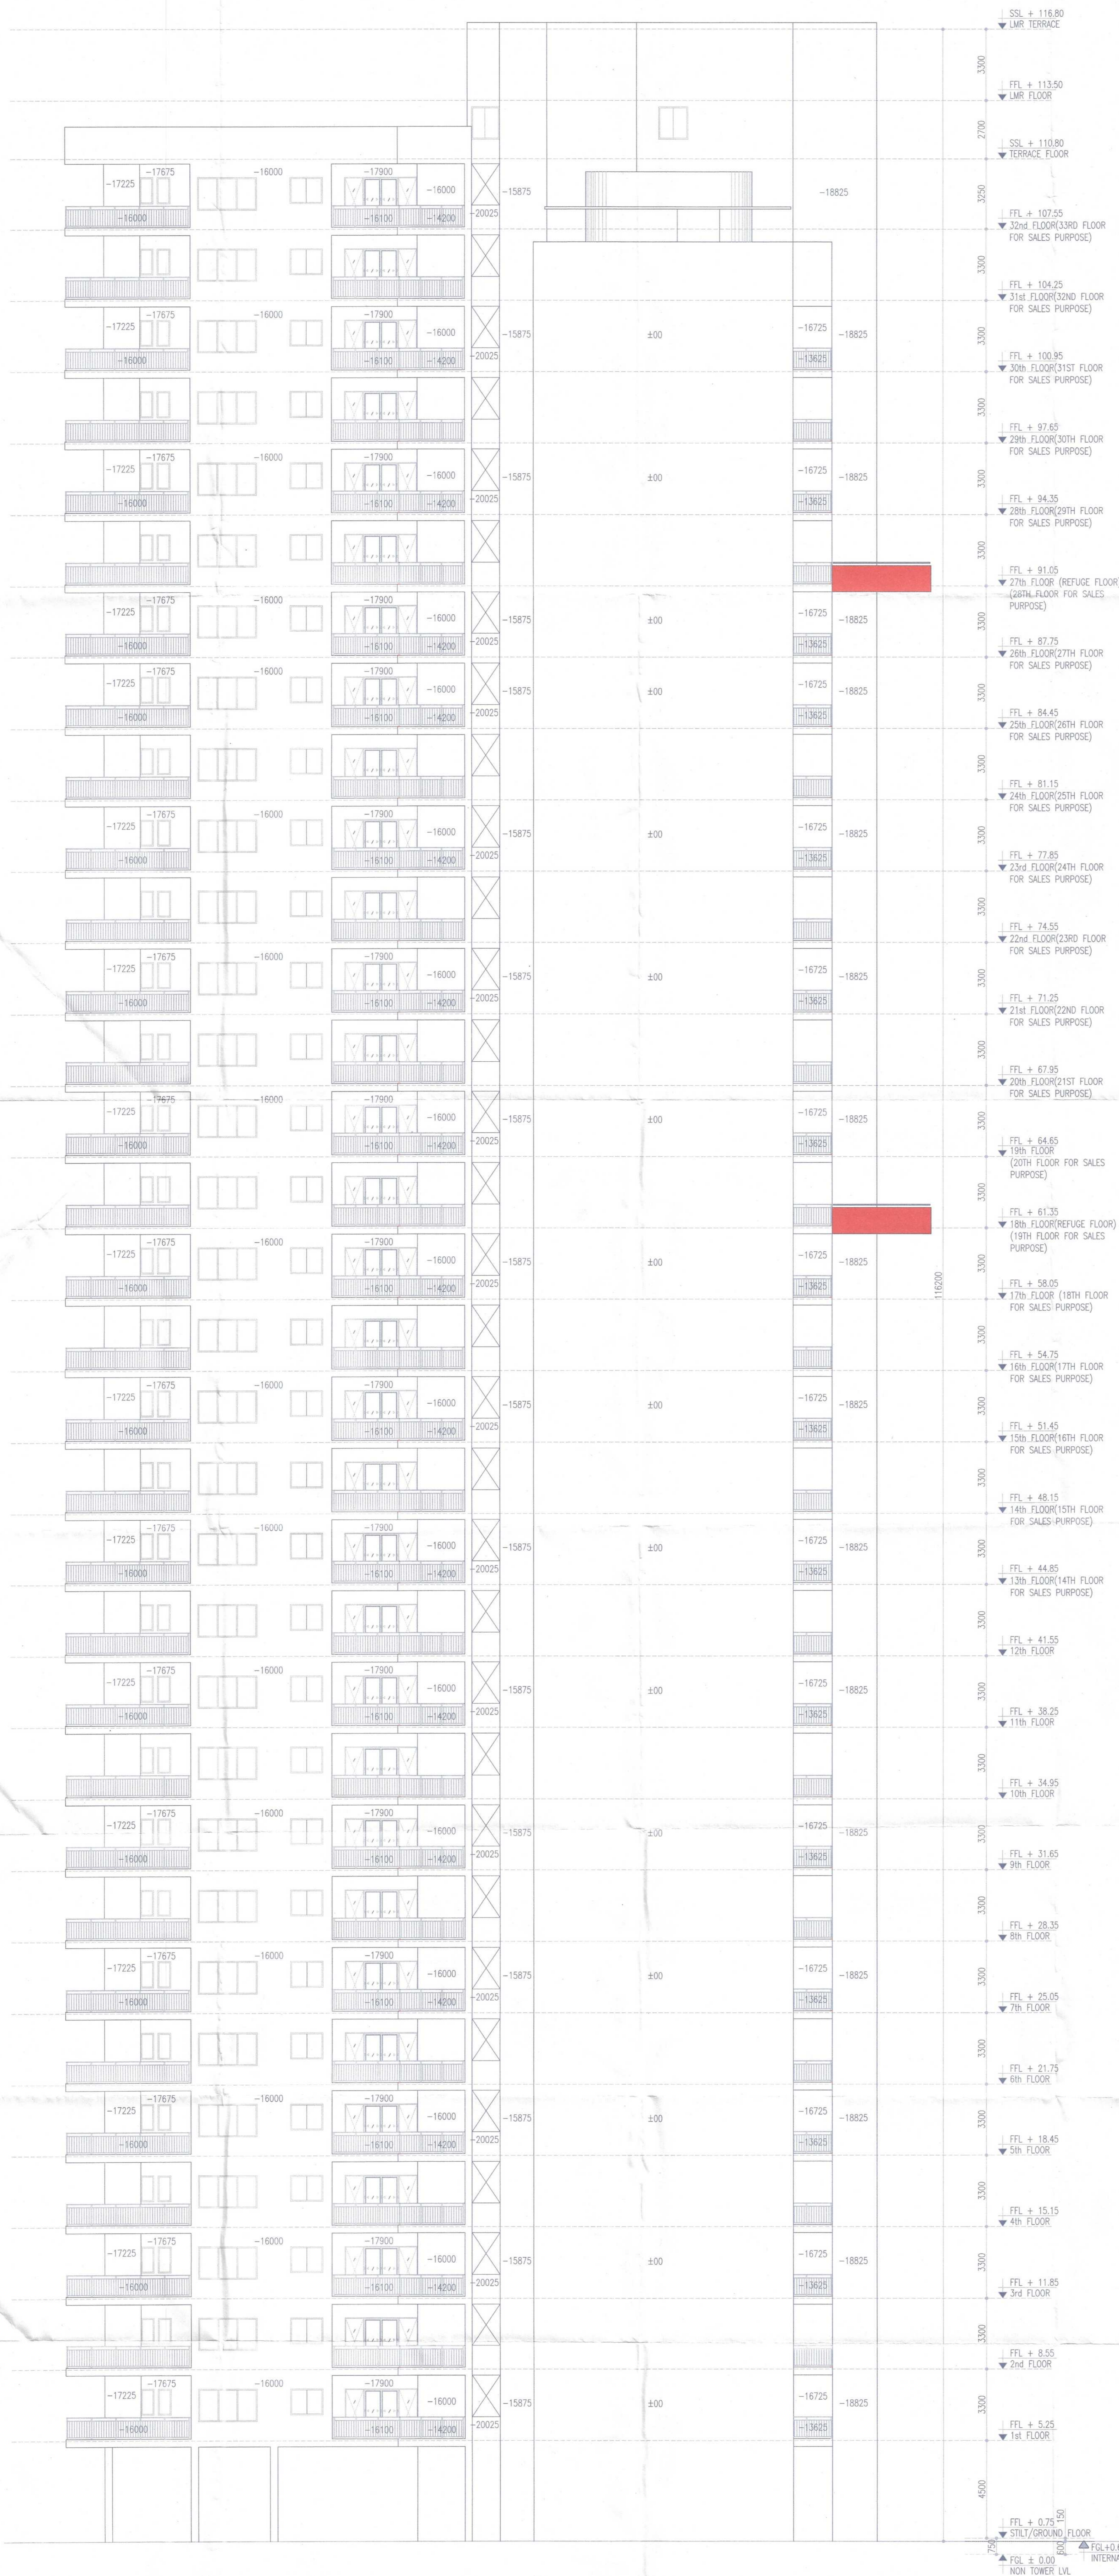

ELEVATION-04
TOWER-1 & 2 (3BHK STANDARD)

Note:-

- BUILDING HAS AUTOMATIC SPRINKLER SYSTEM WHEREVER REQUIRED BY NBC.
- BUILDING WILL BE DESIGNED (STRUCTURES) AS PER RELEVANT IS CODES FOR EARTH QUAKE RESISTANCE.

KEY PLAN

SANCTIONED TO BE READ WITH THIS OFFICE MEMO NO. DATED:

DINESH KUMAR PA(HQ)
 MEMBER B.P.A.C.
 DD(T) MEMBER B.P.A.C.

J.D.
 P.A.
 R.P.

PROJECT:

PROPOSED BUILDING PLAN OF GROUP HOUSING COLONY MEASURING 24.10 ACRES (LICENCE NO 80 OF 2012 DATED 17/08/2012) IN SECTOR 106, GURUGRAM MANESAR URBAN COMPLEX BEING DEVELOPED BY AIRMID DEVELOPERS LTD. & OTHERS.

OWNER'S SEAL & SIGNATURE

Airmid Developers Limited

ARCHITECT'S SEAL & SIGNATURE



AIRMID CHANDRA VAIDYA
 Architect No. CA/5/02006
 H. No. 163, PH-II
 New Patam Vihar, Gurugram

AUG.-2022. Scale : 1:100
 Drawing Title:- TOWER-1 & 2 ELEVATION-4 Drawing No:- B-10

Note:-

- 1. BUILDING HAS AUTOMATIC SPRINKLER SYSTEM WHEREVER REQUIRED BY NBC.
- 2. BUILDING WILL BE DESIGNED (STRUCTURES) AS PER RELEVANT IS CODES FOR EARTHQUAKE RESISTANCE.

KEY PLAN

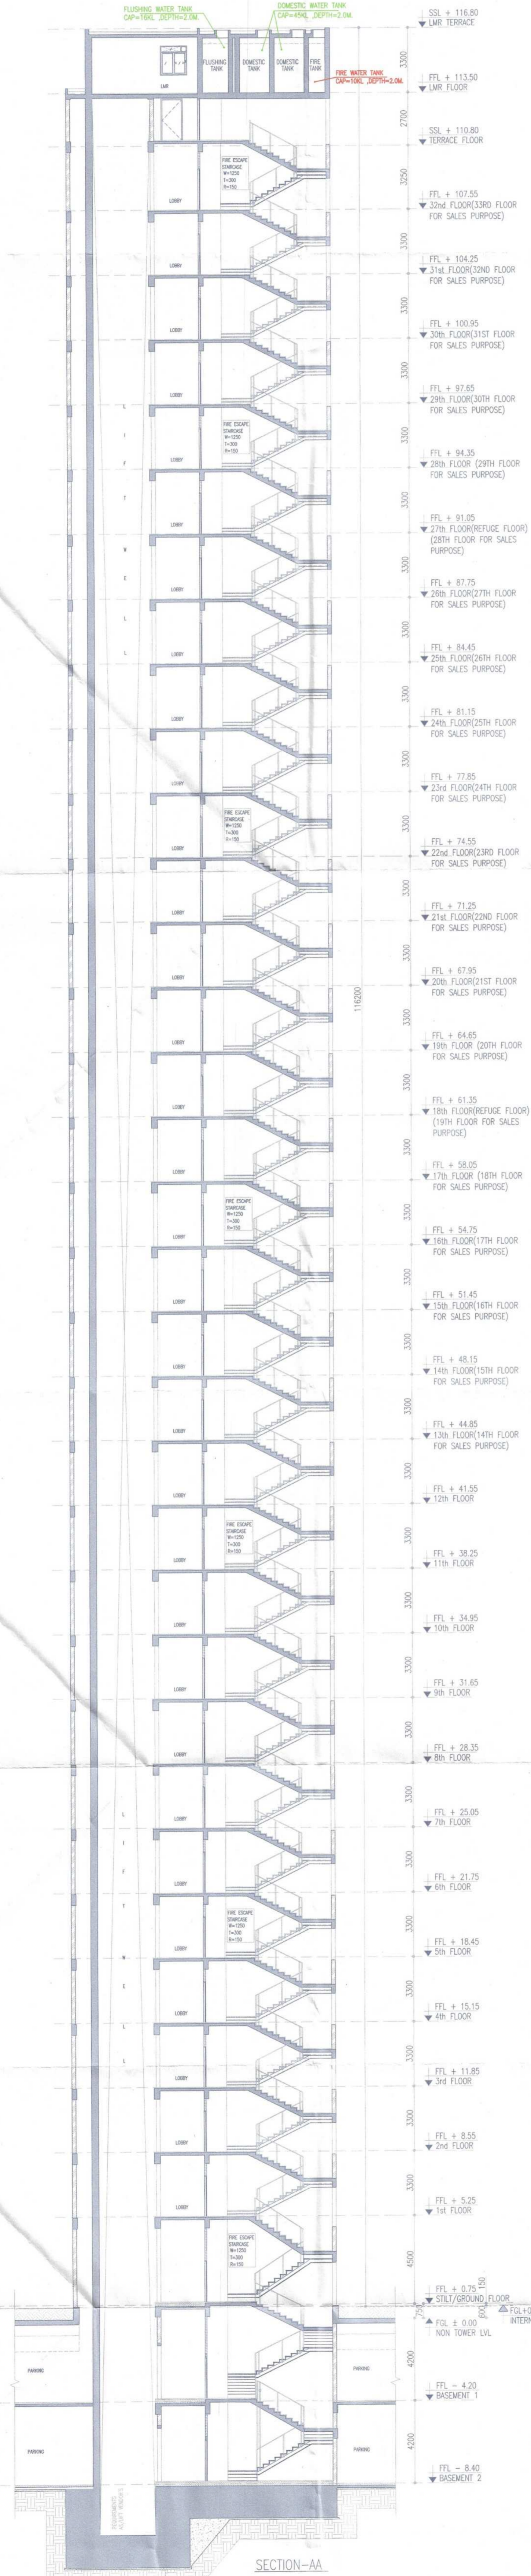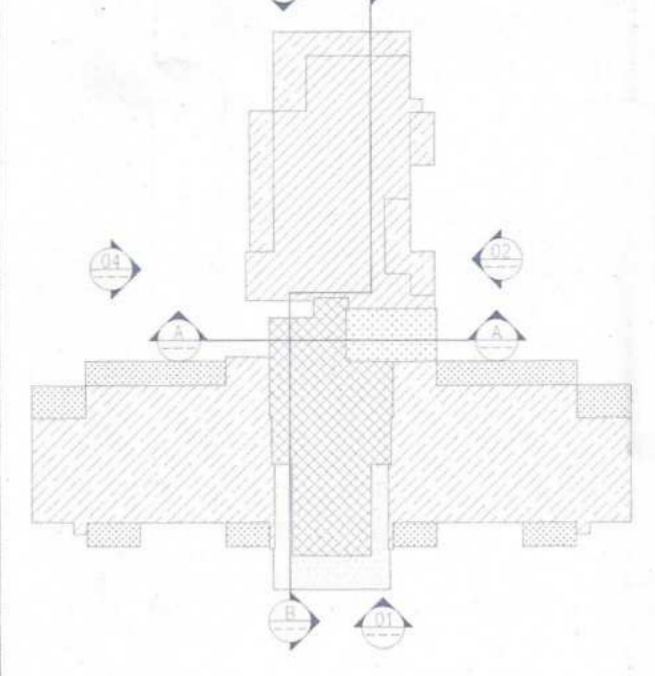

SECTION-AA



SECTION-BB



Sanctioned
MEMO NO. DATED: 17/08/2012

TO BE READ WITH THIS OFFICE

J.D. P.A. A.P.

MEMBER BPAC

PROJECT:
PROPOSED BUILDING PLAN OF GROUP HOUSING COLONY MEASURING 24.10 ACRES (LICENSE NO 80 OF 2012 DATED 17/08/2012) IN SECTOR 106, GURUGRAM URBAN DEVELOPERS LTD. & OTHERS.

OWNER'S SEAL & SIGNATURE
Armid Developers Limited
Authorized Signatory

ARCHITECT'S SEAL & SIGNATURE
ANAND KUMAR WADIA
Architect No. CA7502008
H. No. 163, PH-II
New Palam Vihar, Gurugram


AUG-2022 Scale: 1:100
Drawing Title: TOWER-3,4,5 & 6 SECTION-AA & BB
Drawing No: B-11

Note :-
 1. BUILDING HAS AUTOMATIC SPRINKLER SYSTEM WHEREVER REQUIRED BY NBC.
 2. BUILDING WILL BE DESIGNED STRUCTURES AS PER RELEVANT IS CODES FOR EARTH QUAKE RESISTANCE.




SCHEDULE OF DOORS + WINDOWS


SCHEDULE OF OPENINGS					
TYPE	SIZE	LOCATION	DESCRIPTION	SILL FROM FFL	LINTEL FROM FFL
FD	1200x2400	FAN RM	FIRE DOOR	---	+2400
FD1	2930x2400	DC RM/PUMP RM ELEC. RM/OWC RM	DG-FIRE/ACOUSTICS DOOR	---	+2400
FD2	1500x2300	STAIRCASE	FIRE DOOR	+100	+2400
FD3	1100x2400	REFUGE AREA	FIRE DOOR	---	+2400
FD4	1100x2400	STAIRCASE/LIFT LOBBY	FIRE DOOR	---	+2400
FD5	750x2300	ELECTRICAL/AV/LV/CWP SHAFT	FIRE DOOR	+100	+2400
FD6	500x2300	CWP	FIRE DOOR	+100	+2400

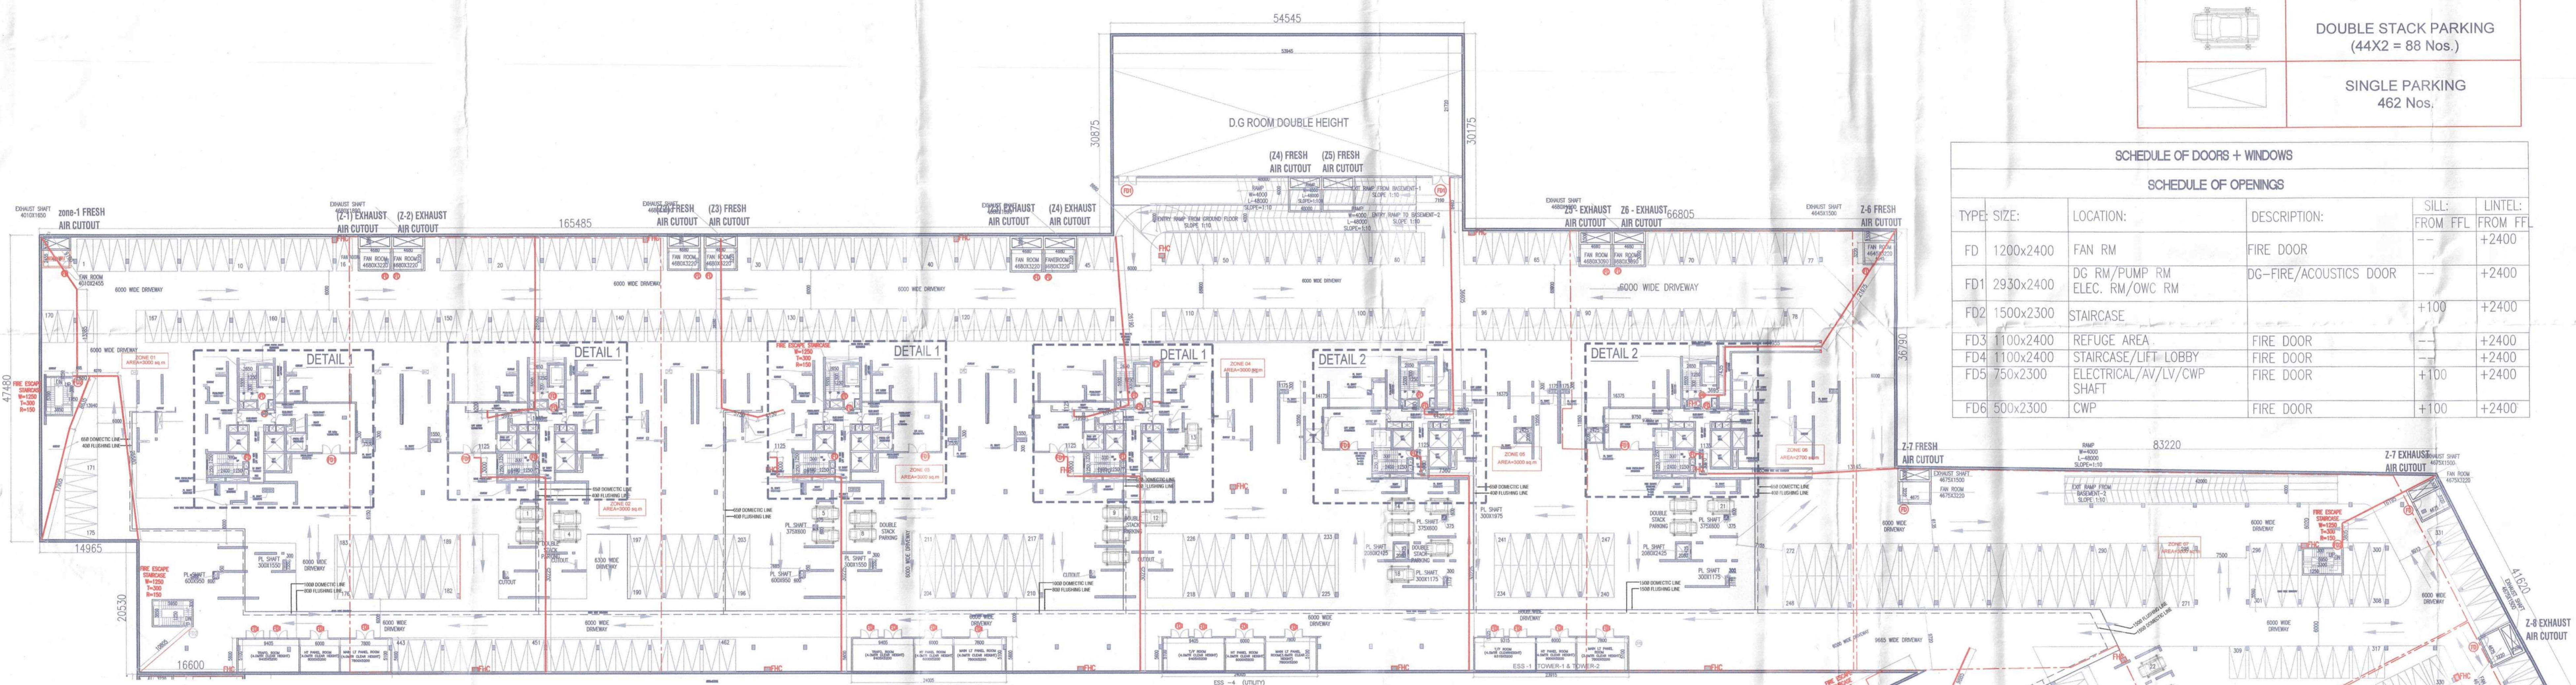


BASEMENT-1 PHASE 1
 LEVEL-4200MM
 SINGLE LEVEL PARKING=462
 DOUBLE STACK PARKING=44X2=88
 NO.OF CAR PARKING=550 Nos.

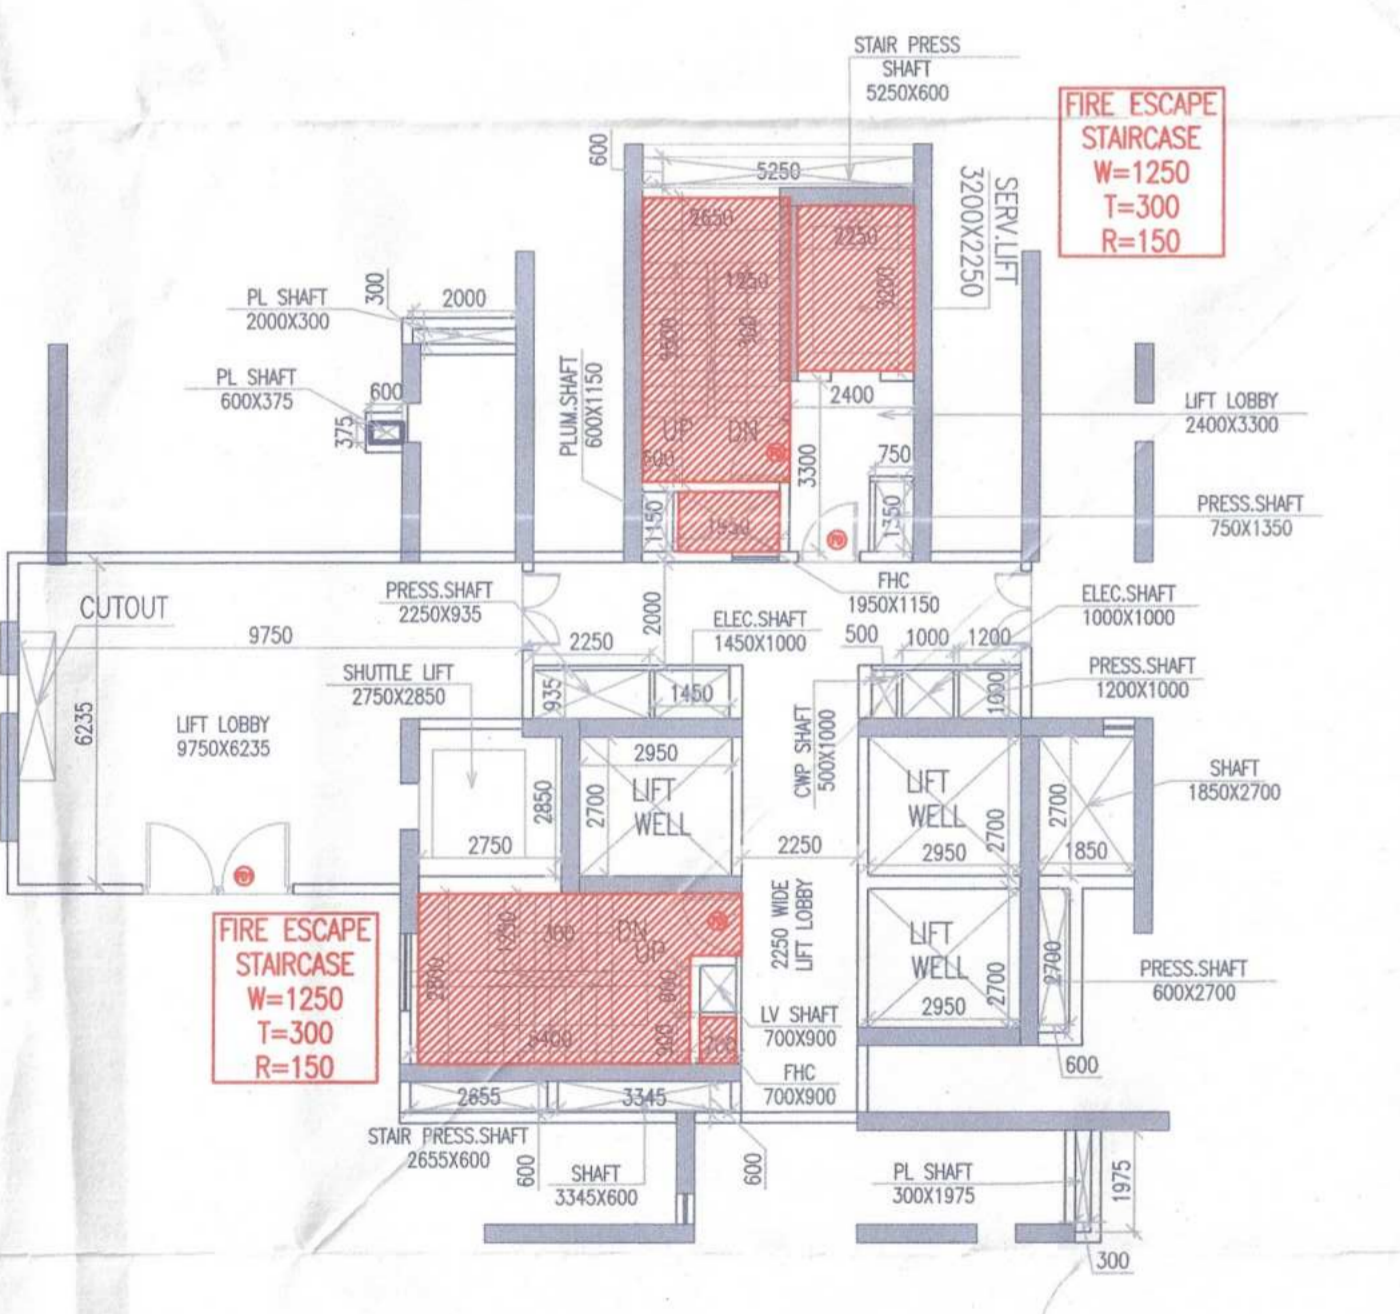


DETAIL 1

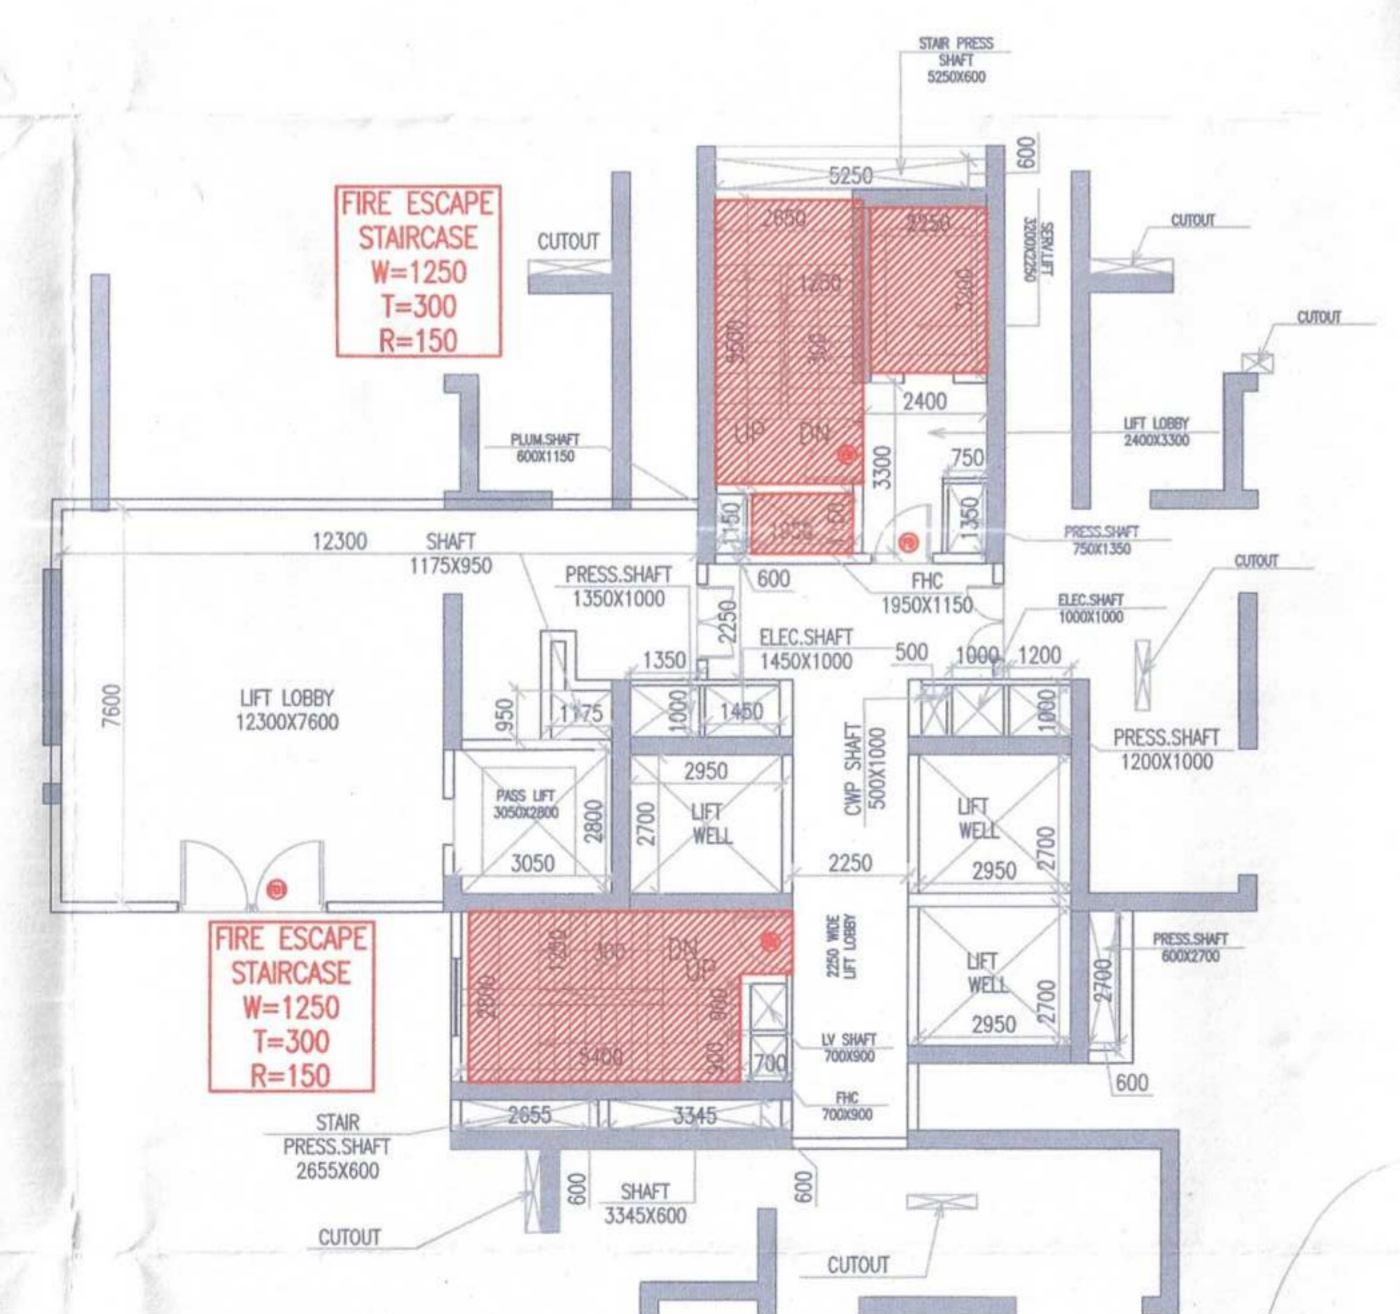

DETAIL 2

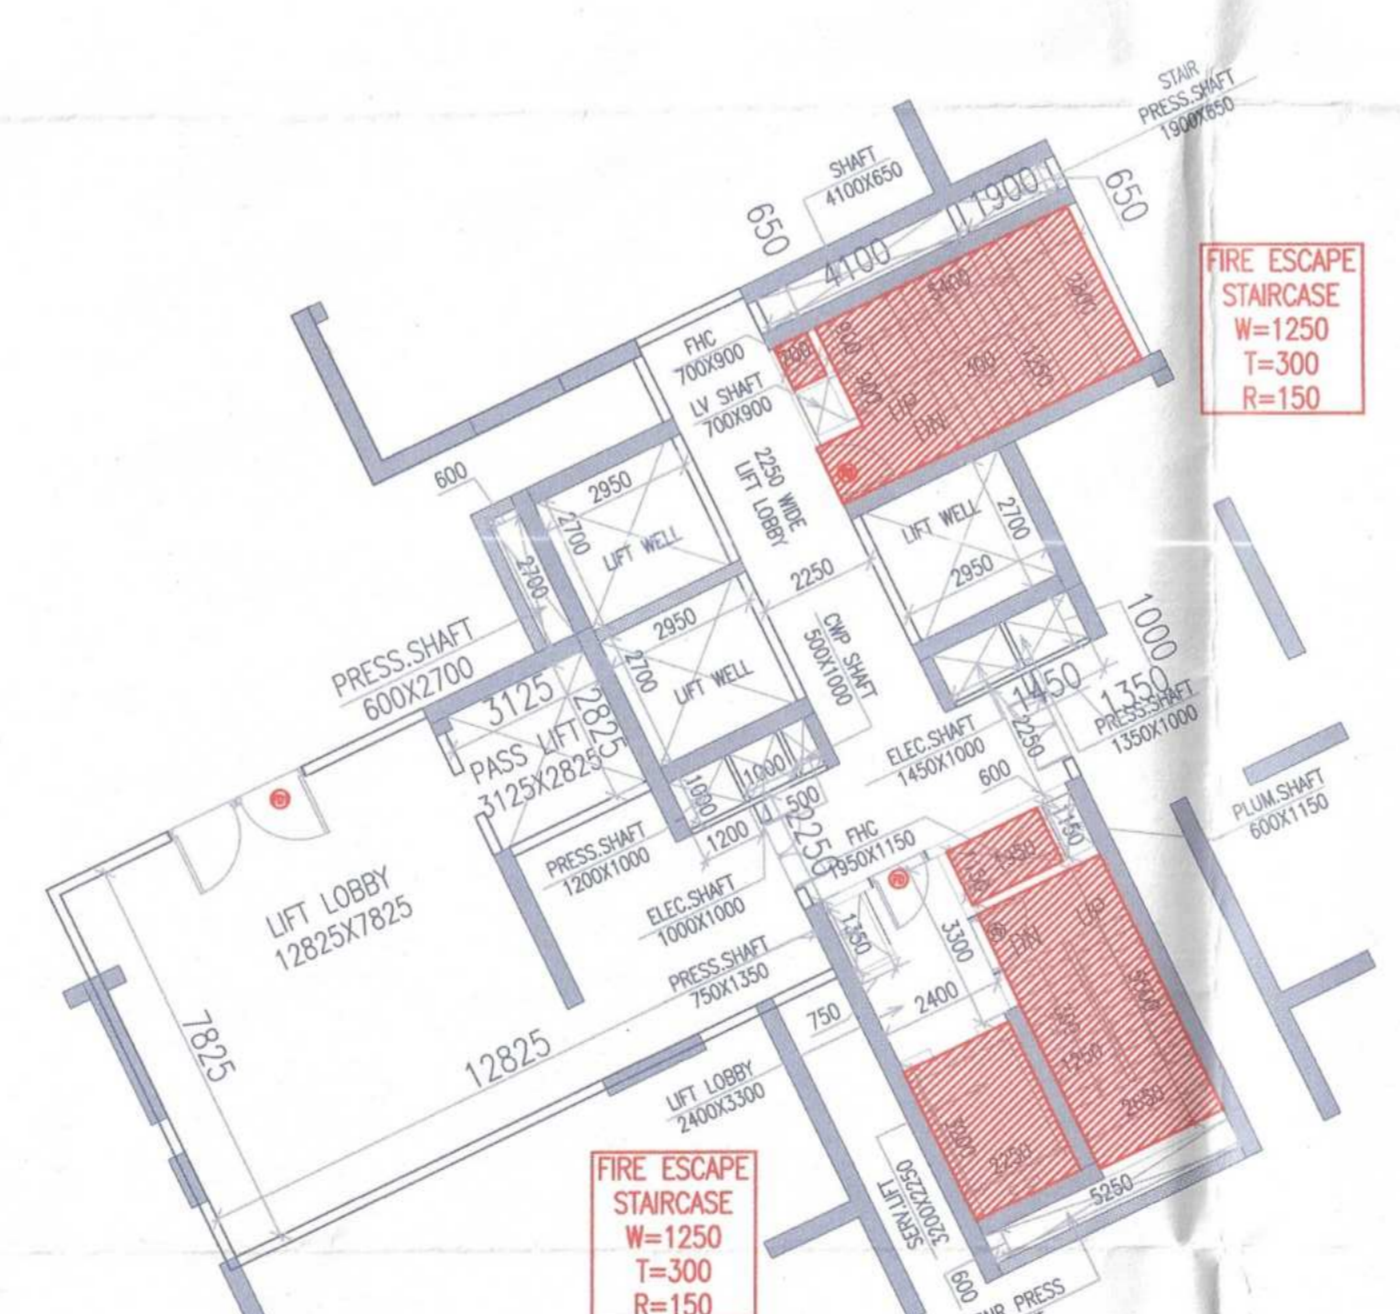

DETAIL 3

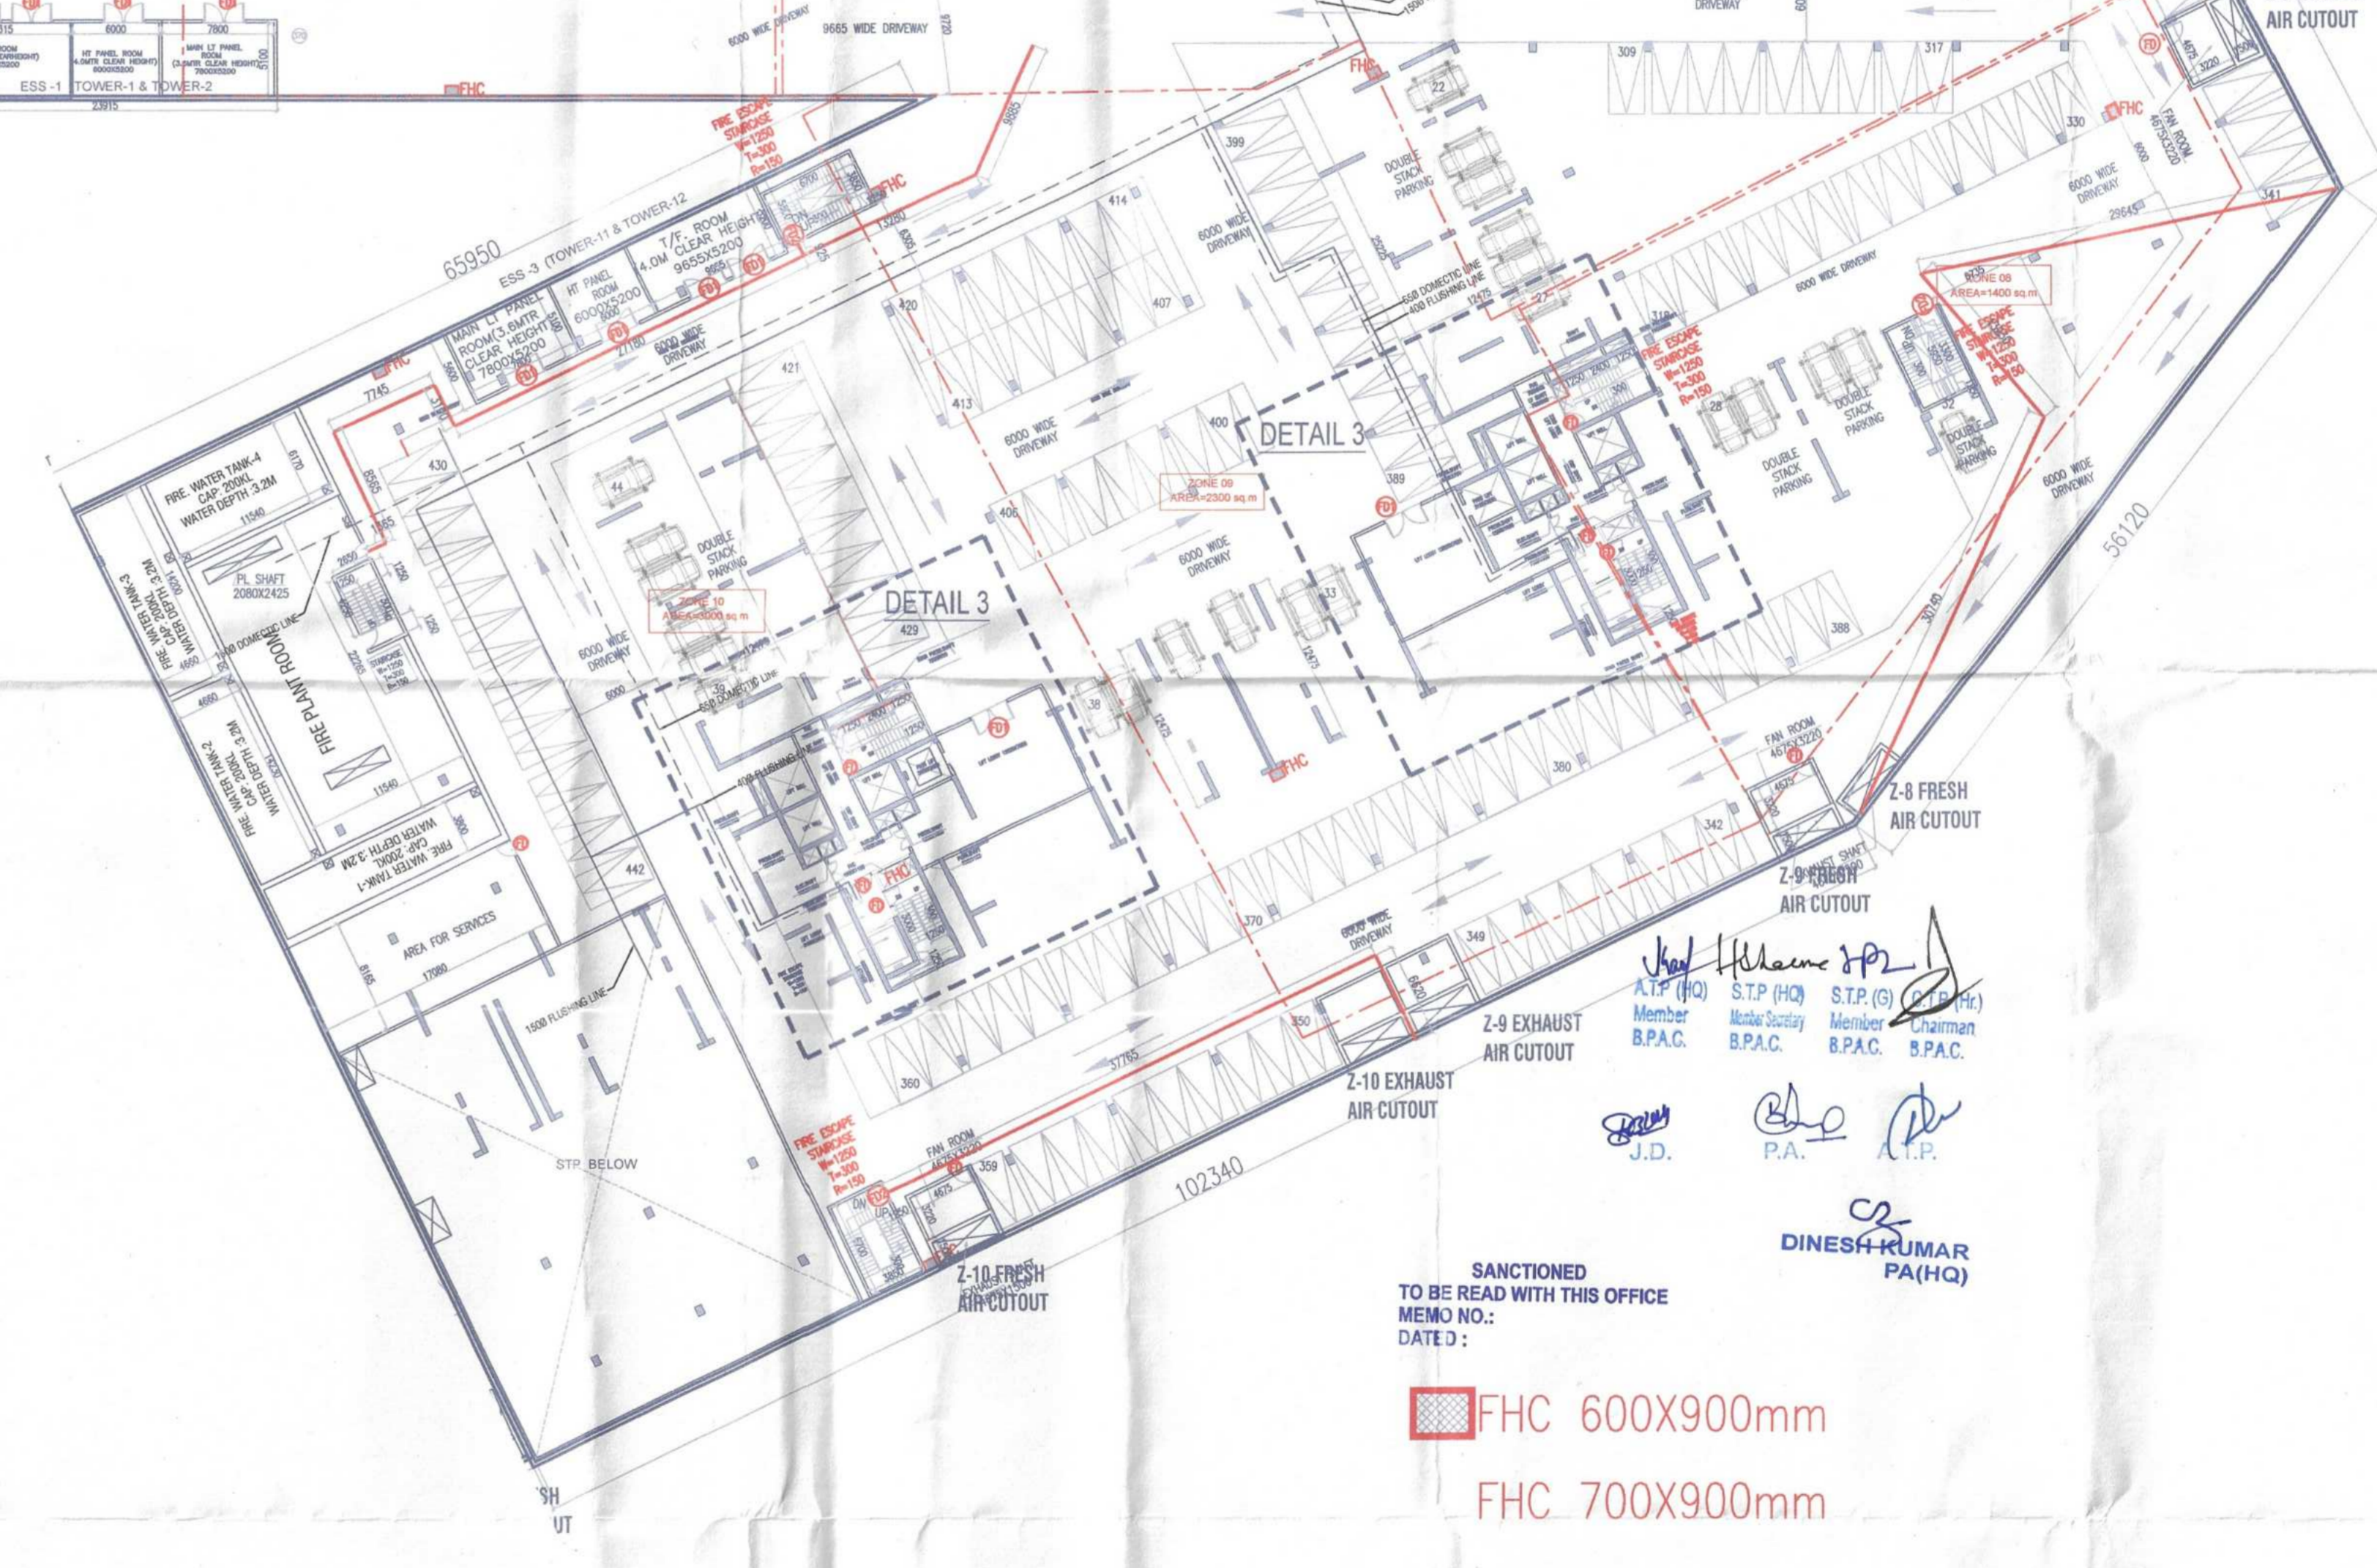

FHC 600X900mm
 FHC 700X900mm
 FHC 600X900mm

TO BE READ WITH THIS OFFICE MEMO NO: DATE:

(Signatures)
 J.D. P.A. P.A.
 DINESH KUMAR PA(HQ)

Executive Engineer-III
 W/S Division, CMDA
 Gurugram

Executive Engineer-III
 Drainage Division, CMDA,
 Gurugram

Executive Engineer-V,
 Sew. Division, CMDA,
 Gurugram

Chief Engineer,
 (Civil), CMDA
 Gurugram

PROJECT: DD (NT) MEMBERSHIP COLONY
 PROPOSED Building Plan MEMBERING COLONY
 MEASUR: 24.10 ACRES (LICENCE NO. 80 OF 2012 DATED 17/08/2012)
 IN SECTOR 106, GURUGRAM MANESAR URBAN COMPLEX BEING DEVELOPED BY ARMD DEVELOPERS LTD. & OTHERS.



OWNER'S SEAL & SIGNATURE: Armd Developers Limited
 Authorized Signatory

ARCHITECT'S SEAL & SIGNATURE: AVINASH CHANDRA VAIDYA
 Architect No. CA/1600006
 H. No. 163, PII-II
 New Palm Vihar, Gurugram

AUG-2022. Scale: 1:300
 Drawing Title: PHASE 1- BASEMENT-1- PLANS
 Drawing No: BA-01

Note:-





- 1. BUILDING HAS AUTOMATIC SPRINKLER SYSTEM WHEREVER REQUIRED BY NBC.
- 2. BUILDING WILL BE DESIGNED STRUCTURES AS PER RELEVANT IS CODES FOR EARTH QUAKE RESISTANCE.

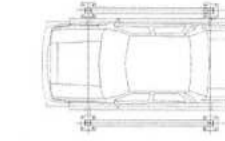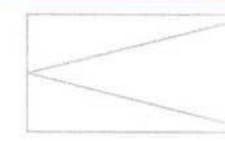	DOUBLE STACK PARKING (44X2 = 88 Nos.)
	SINGLE PARKING 462 Nos.

SCHEDULE OF DOORS + WINDOWS

SCHEDULE OF OPENINGS

TYPE	SIZE	LOCATION	DESCRIPTION	SILL FROM FFL	LINTEL FROM FFL
FD	1200x2400	FAN RM	FIRE DOOR	---	+2400
FD1	2930x2400	DG RM/PUMP RM ELEC. RM/OWC RM	DG-FIRE/ACOUSTICS DOOR	---	+2400
FD2	1500x2300	STAIRCASE	FIRE DOOR	+100	+2400
FD3	1100x2400	REFUGE AREA	FIRE DOOR	---	+2400
FD4	1100x2400	STAIRCASE/LIFT LOBBY	FIRE DOOR	---	+2400
FD5	750x2300	ELECTRICAL/AV/LV/CWP SHAFT	FIRE DOOR	+100	+2400
FD6	500x2300	CWP	FIRE DOOR	+100	+2400

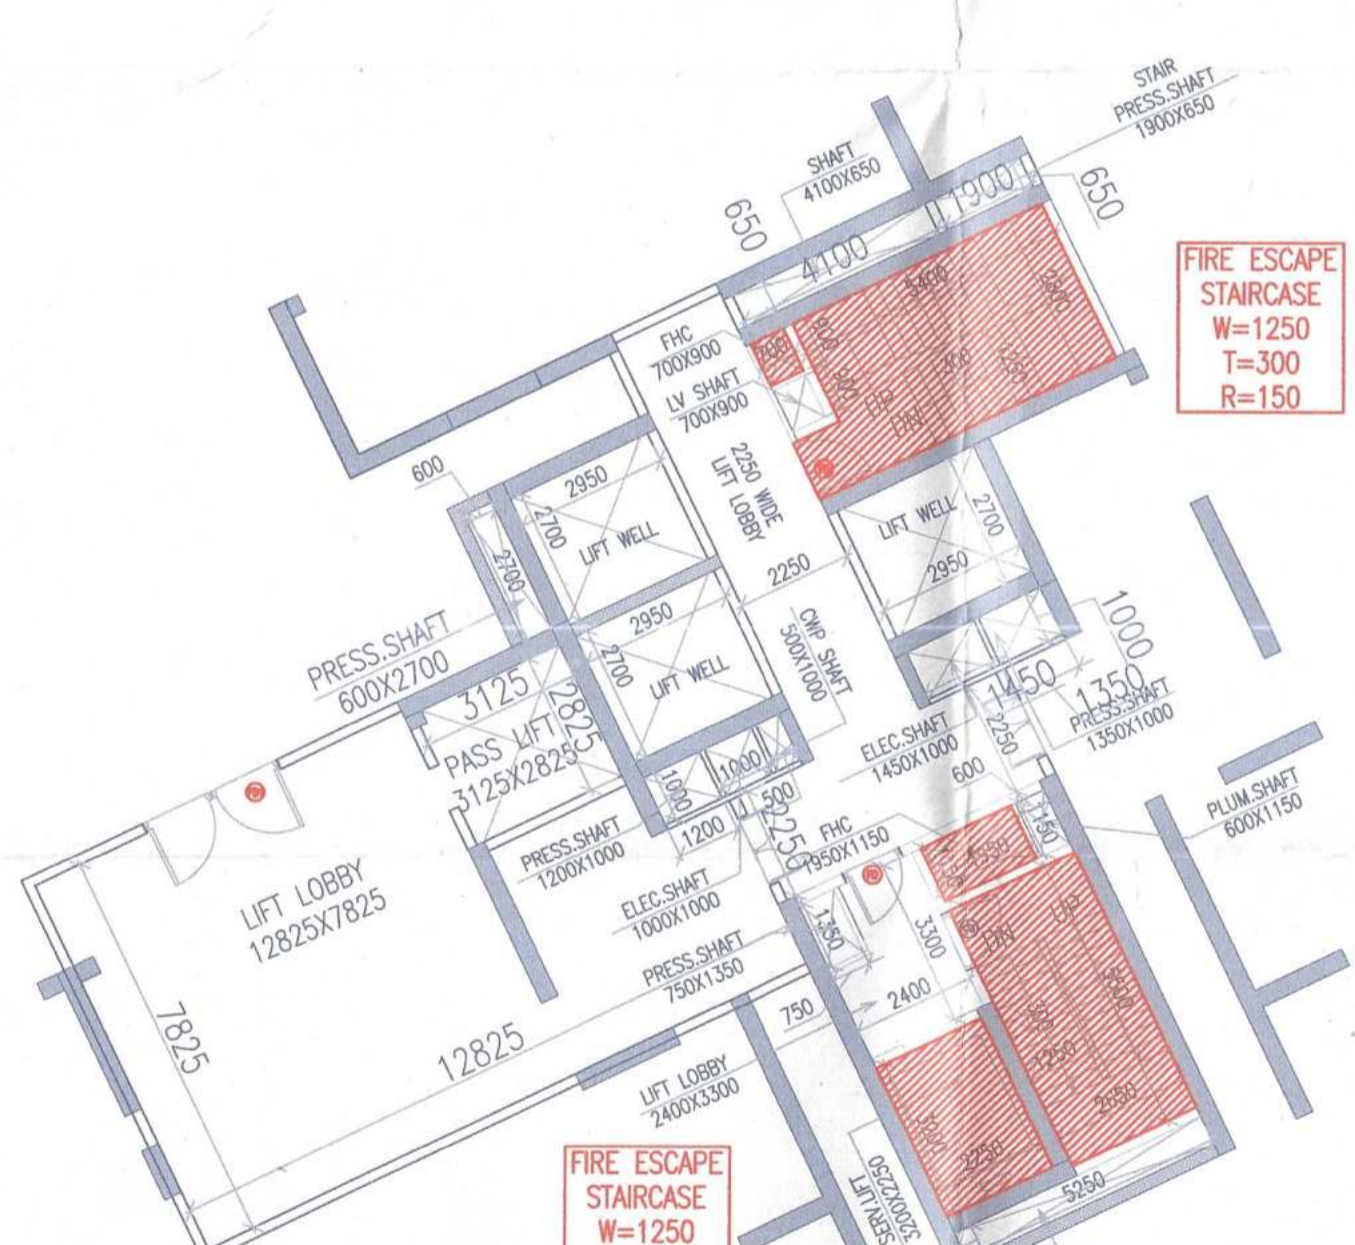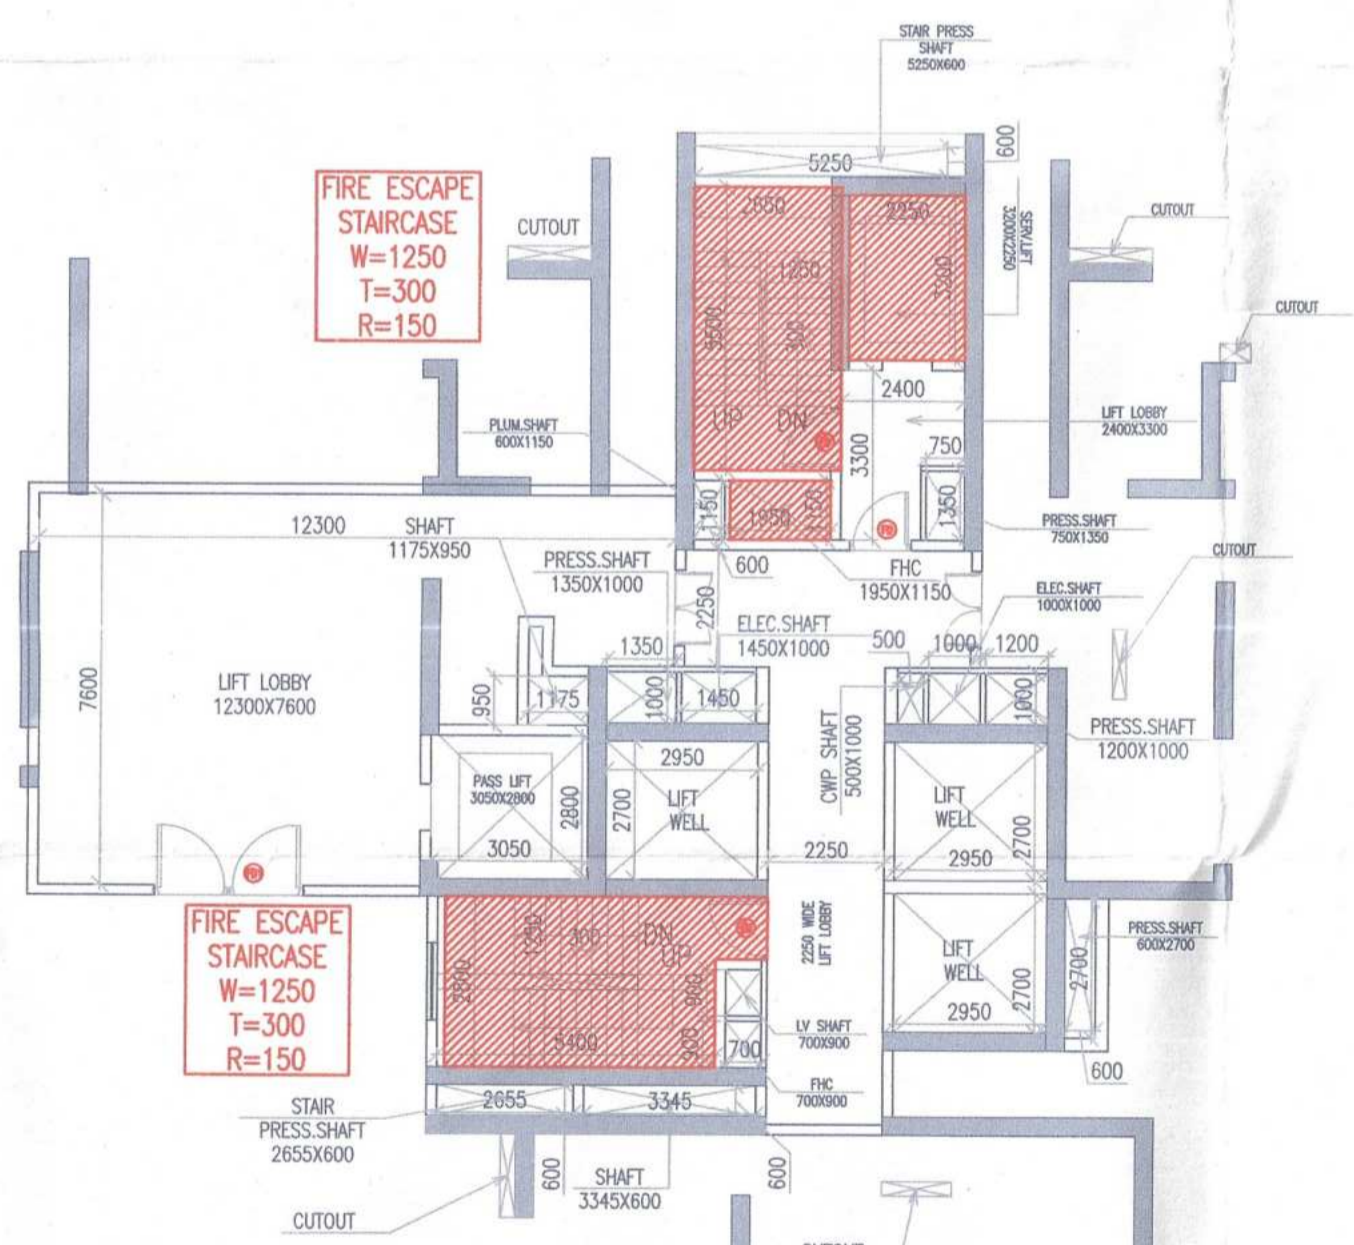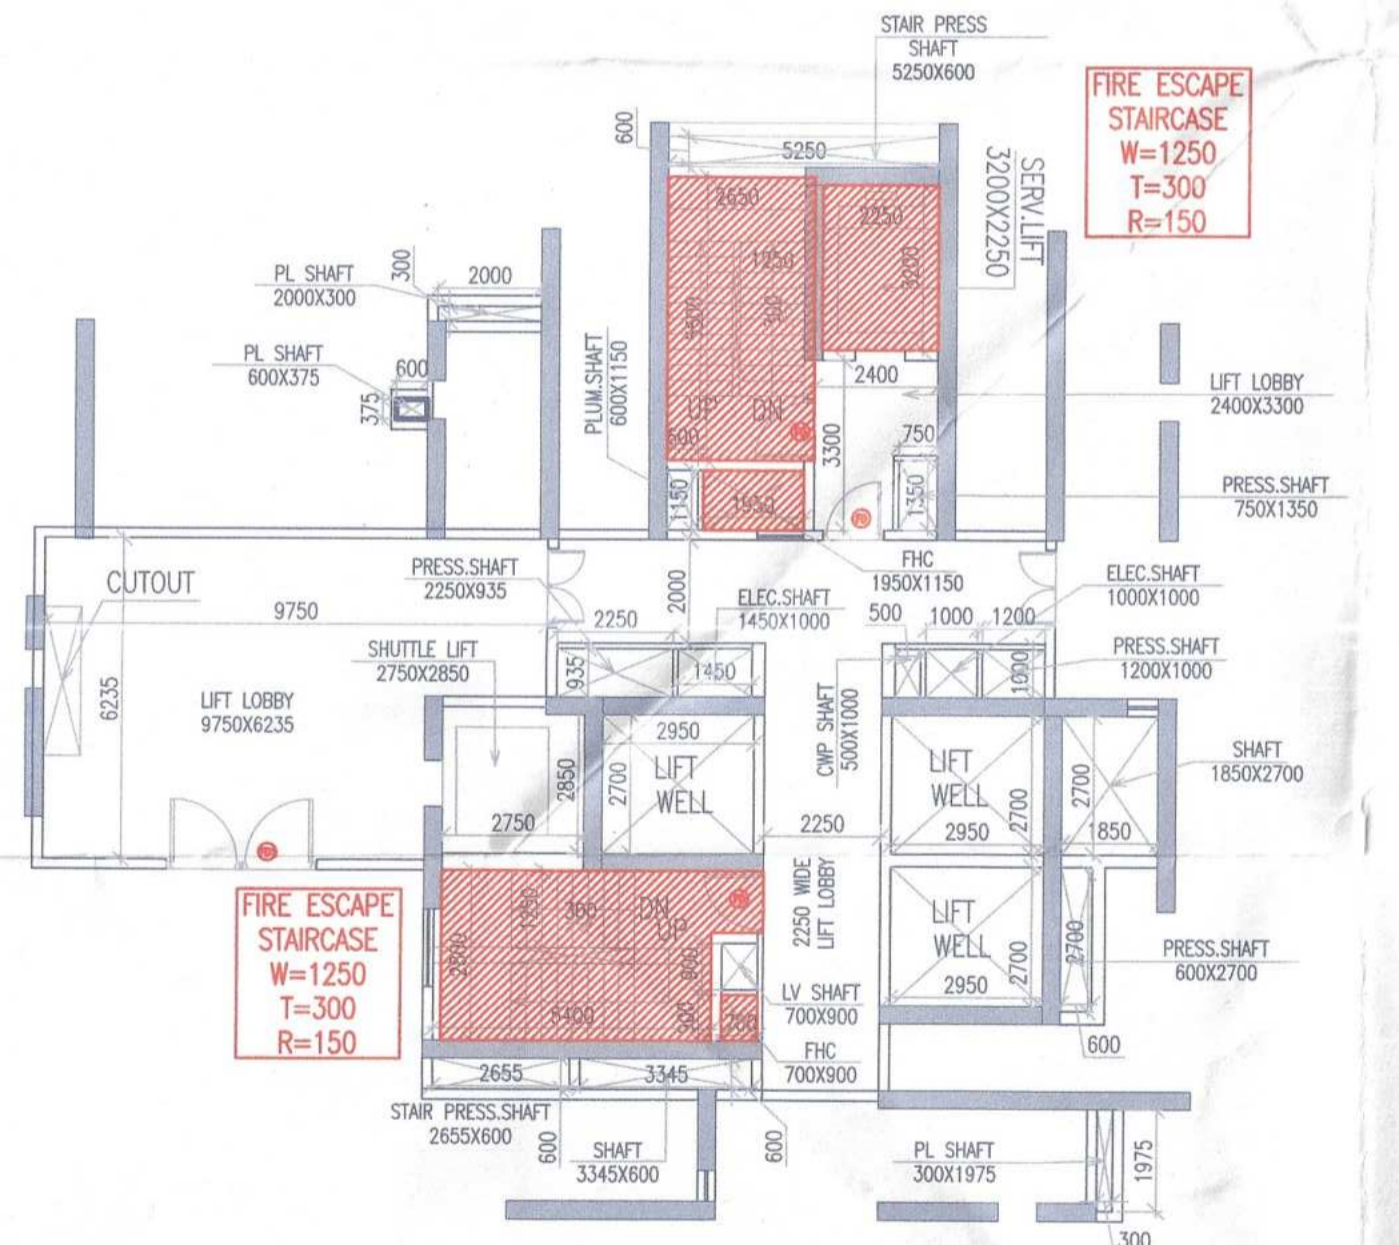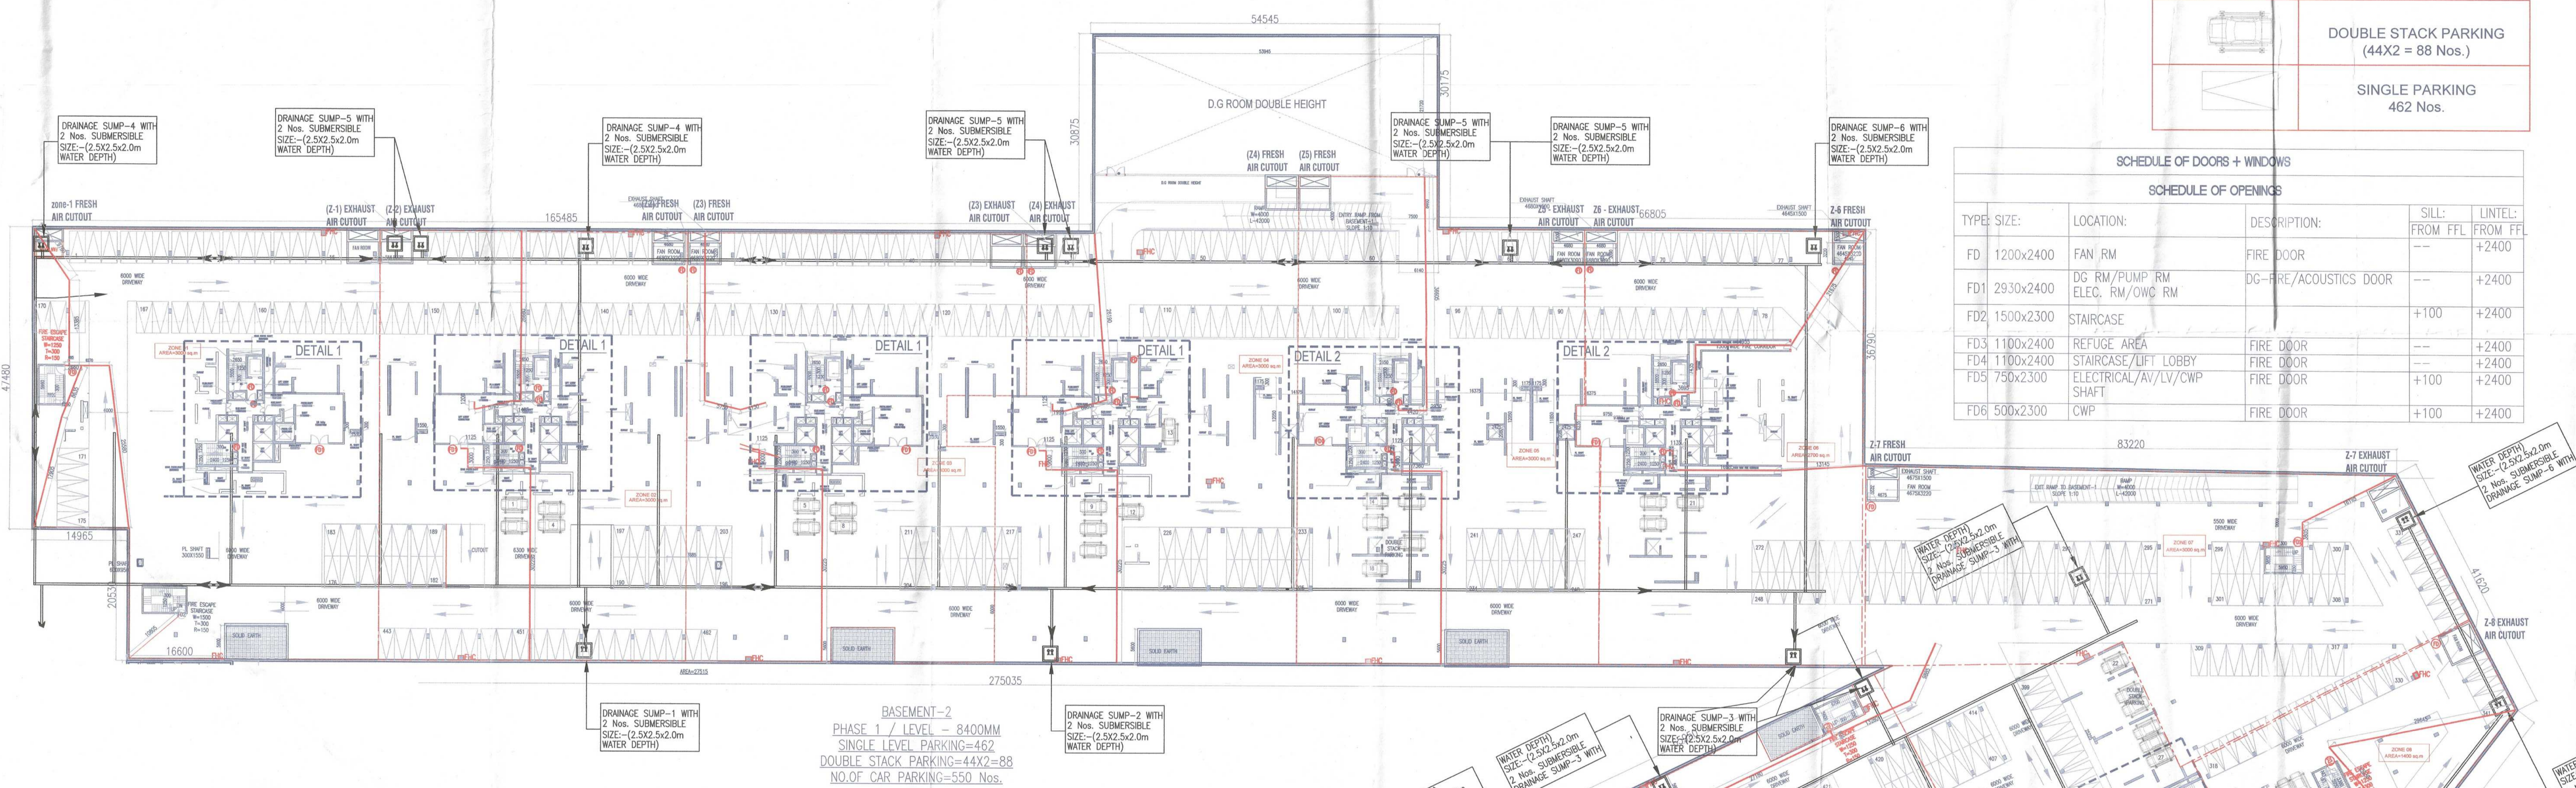

- FHC 600X900mm
- FHC 700X900mm
- FHC 600X900mm

Executive Engineer-IV
W/S Division, CMDA
Gurugram

Executive Engineer-III
Drainage Division, CMDA
Gurugram

Sanctioned
EPFAD WITH THIS OFFICE
Chief Engineer,
(Infra-4), CMDA
Gurugram

DDT (N)
MEMBER
BPAC

DINESH KUMAR
PA(HQ)

PROJECT:
PROPOSED Building Plan GROUP HOUSING COLONY
MEASURING
24.10 ACRES (LICENCE NO 80 OF
2012 DATED 17/08/2012)
IN SECTOR 106, GURUGRAM MANESAR URBAN
COMPLEX BEING DEVELOPED BY ARMD
DEVELOPERS LTD. & OTHERS.

OWNER'S SEAL
& SIGNATURE

Aimd Developers Limited
Authorised Signatory


ARCHITECT'S SEAL
& SIGNATURE

AVINASH CHANDRA VAIDYA
Architect No. CA7502009
M. No. 163, PH-I
New Palam Vihar, Gurugram

AUG-2022. Scale: 1:300
Drawing Title:-
PHASE 1
BASEMENT-2- PLANS

Drawing No:-
BA-03

Note:-
 1. BUILDING HAS AUTOMATIC SPRINKLER SYSTEM WHEREVER REQUIRED BY NBC.
 2. BUILDING WILL BE DESIGNED (STRUCTURES) AS PER RELEVANT CODES FOR EARTH QUAKE RESISTANCE.

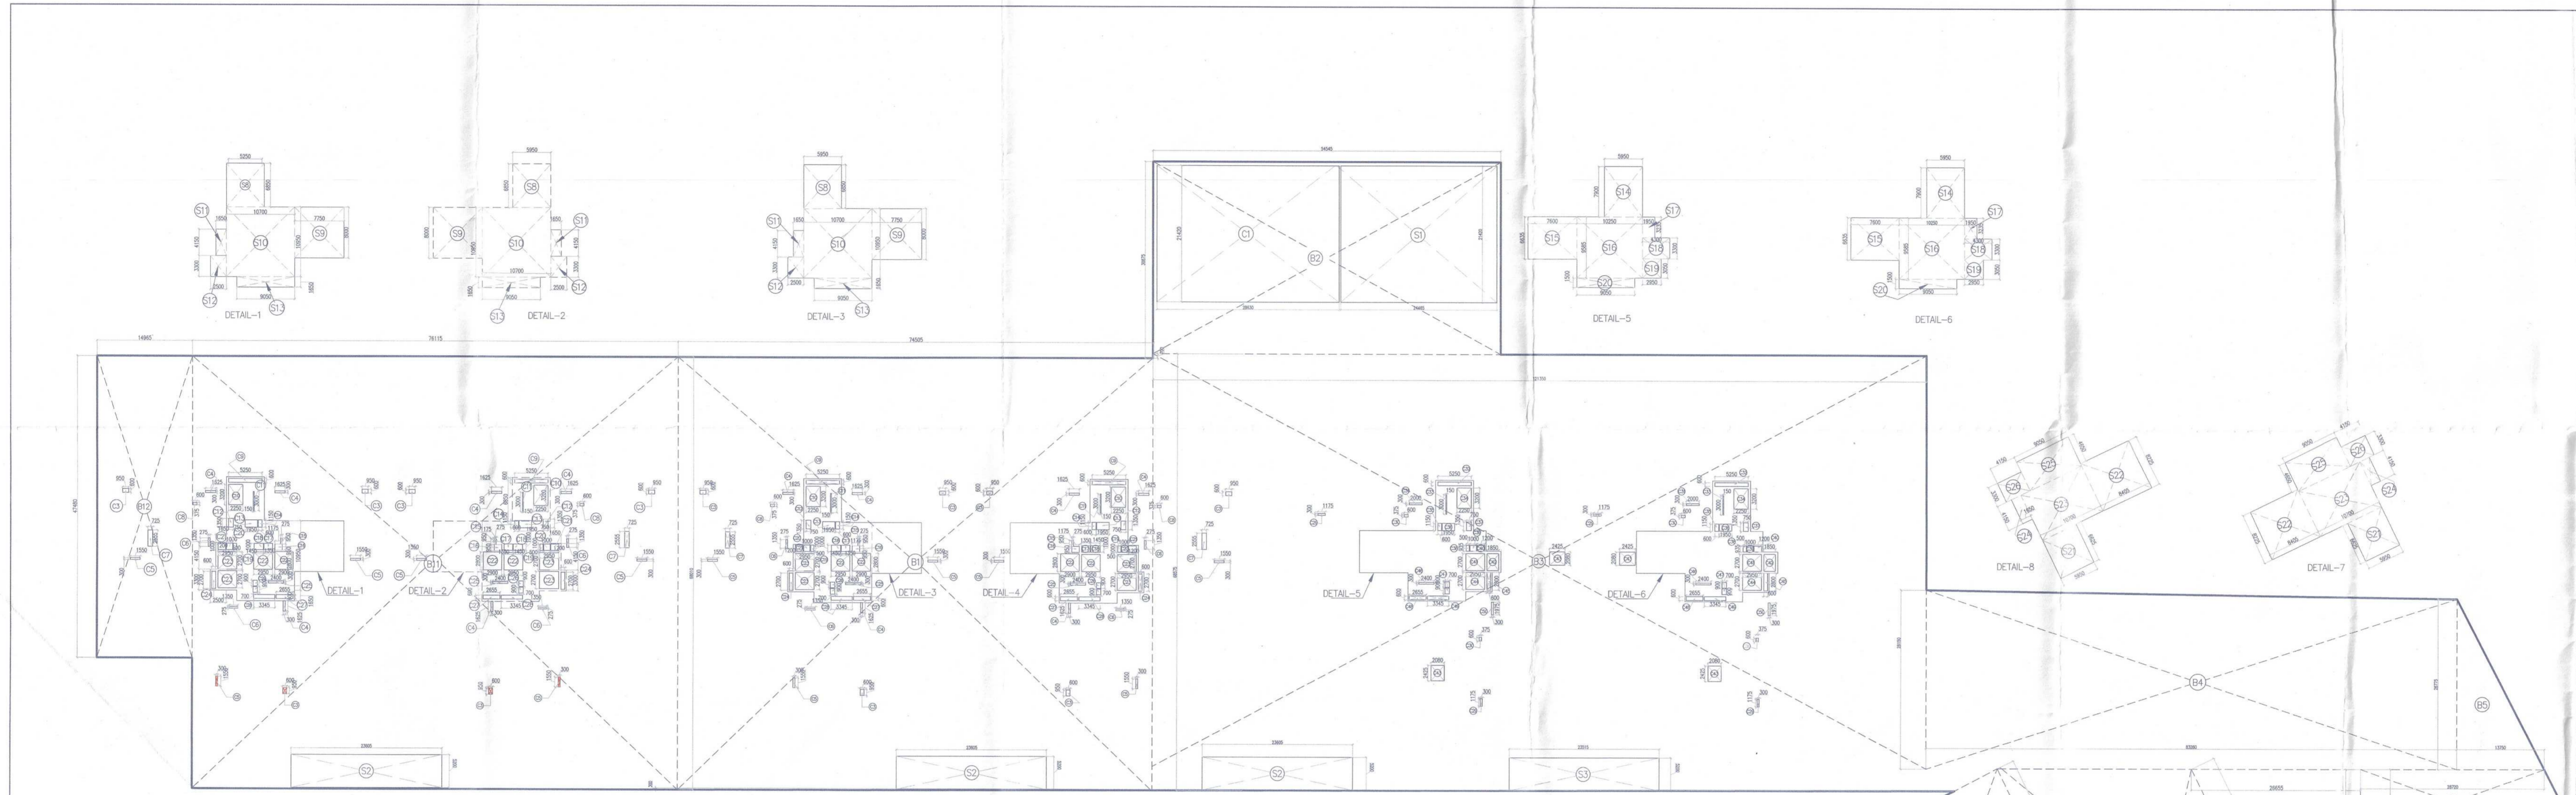

BASEMENT-01

BASEMENT-02 AREA CALCULATION			
GROSS - 1			
S11 = 1 X	74.855	X	58.770 = 5112.309 SQM
S12 = 1 X	54.845	X	35.175 = 1928.895 SQM
S13 = 1 X	52.950	X	68.770 = 3641.095 SQM
S14 = 0.5 X	(28.04+7.75)	X	63.290 = 291.948 SQM
S15 = 0.5 X	13.750	X	29.770 = 144.075 SQM
S16 = 0.5 X	(28.720+33.850)	X	15.250 = 381.338 SQM
S17 = 0.5 X	33.850	X	14.600 = 139.175 SQM
S18 = 0.5 X	26.850	X	54.970 = 711.813 SQM
S19 = 0.5 X	(61.040+13.300)	X	27.420 = 1965.873 SQM
S110 = 0.5 X	74.855	X	74.370 = 797.534 SQM
S111 = 1 X	78.118	X	68.970 = 5376.981 SQM
S112 = 1 X	14.885	X	47.490 = 710.538 SQM
TOTAL			34215.797 SQM
SERVICE AREA			
GROSS AREA UNDER TOWERS			
S1 = 1 X	38.000	X	20.000 = 760.000 SQM
S2 = 1 X	26.000	X	20.000 = 520.000 SQM
S3 = 1 X	4.500	X	20.000 = 90.000 SQM
S4 = 1 X	33.000	X	18.750 = 615.750 SQM
S5 = 1 X	43.000	X	18.000 = 774.000 SQM
S6 = 1 X	25.910	X	32.150 = 833.007 SQM
TOTAL			2880.328 SQM
S7 = 1 X	6.900	X	8.800 = 60.720 SQM
S8 = 1 X	7.700	X	8.000 = 61.600 SQM
S9 = 1 X	10.700	X	9.900 = 105.930 SQM
S10 = 1 X	1.800	X	8.300 = 14.940 SQM
S11 = 1 X	2.900	X	3.900 = 11.310 SQM
S12 = 1 X	9.000	X	1.800 = 16.200 SQM
SUB TOTAL			288.953 SQM
NO OF TYPICAL TOWER			8
TOTAL AREA			889.810 SQM
S14 = 1 X	5.900	X	7.800 = 47.000 SQM
S15 = 1 X	7.800	X	8.800 = 68.640 SQM
S16 = 1 X	10.200	X	8.800 = 89.760 SQM
S17 = 1 X	1.800	X	3.100 = 5.580 SQM
S18 = 1 X	4.300	X	3.300 = 14.190 SQM
S19 = 1 X	2.900	X	3.000 = 8.700 SQM
S20 = 1 X	9.000	X	1.800 = 16.200 SQM
SUB TOTAL			238.748 SQM
NO OF TYPICAL TOWER			2
TOTAL AREA			477.496 SQM
S21 = 1 X	5.900	X	6.600 = 38.910 SQM
S22 = 1 X	8.400	X	7.800 = 65.520 SQM
S23 = 1 X	10.700	X	3.800 = 37.460 SQM
S24 = 1 X	1.800	X	4.100 = 7.380 SQM
S25 = 1 X	9.000	X	4.600 = 41.400 SQM
S26 = 1 X	4.100	X	3.300 = 13.530 SQM
SUB TOTAL			205.893 SQM
NO OF TYPICAL TOWER			2
TOTAL AREA			411.786 SQM
TOTAL SERVICE AREA UNDER TOWERS			4789.008 SQM
CUT OUT SHAFTS			
GROSS 3 AREA UNDER CUT OUT SHAFTS			
C1 = 2 X	8.400	X	5.700 = 102.270 SQM
C2 = 2 X	9.750	X	5.700 = 109.500 SQM
C3 = 1 X	8.600	X	5.700 = 59.518 SQM
TOTAL			269.828 SQM
NET AREA OF BASEMENT - 02	GROSS - 1	GROSS - 2	GROSS - 3
TOTAL	34215.797 SQM	398.828 SQM	269.828 SQM
SERVICE AREA OF BASEMENT - 02	GROSS - 1	GROSS - 2	GROSS - 3
TOTAL	4789.008 SQM	4789.008 SQM	269.828 SQM
NET FAVORABLE AREA OF BASEMENT - 02	GROSS - 1	GROSS - 2	GROSS - 3
TOTAL	29115.873 SQM	4789.008 SQM	269.828 SQM
NO OF CAR AVAILABLE OF BASEMENT - 02	29115.873	31	
ORWAY	811.748	CARR	
	811	CARR	

Be it remembered that all the above mentioned drawings have been checked and found in order as per Public Health Services point of view.

Executive Engineer-V, Sew. Drainage, GMDA, Gurugram

Executive Engineer-III, Drainage Division, GMDA, Gurugram

Executive Engineer-V, W/S Division, GMDA, Gurugram

Chief Engineer, (In-charge), GMDA, Gurugram

Members: STP (A), STP (B), STP (C), STP (D), STP (E), STP (F), STP (G), STP (H), STP (I), STP (J), STP (K), STP (L), STP (M), STP (N), STP (O), STP (P), STP (Q), STP (R), STP (S), STP (T), STP (U), STP (V), STP (W), STP (X), STP (Y), STP (Z)

DINESH KUMAR PAI(HQ)

SANCTIONED TO BE READ WITH THIS OFFICE MEMO NO: DATED:


DDA (T) MEMBER BPAC

PROJECT:
 PROPOSED Building Plan GROUP HOUSING COLONY MEASURING 24.10 ACRES (LICENSE NO 80 OF 2012 DATED 17/08/2012) IN SECTOR 106, GURUGRAM MANESAR URBAN COMPLEX BEING DEVELOPED BY AIRMD DEVELOPERS LTD. & OTHERS.

OWNER'S SEAL & SIGNATURE
 Airmid Developers Limited
 Authorised Signatory

ARCHITECT'S SEAL & SIGNATURE
 AVINASH CHANDRAY
 Architect No. CA/760/
 H. No. 163, P-11
 New Palam Vihar, Gurugram

AUG-2022 Scale : 1:300
 Drawing Title: PHASE 1 BASEMENT-2- AREA CHART
 Drawing No: BA-04

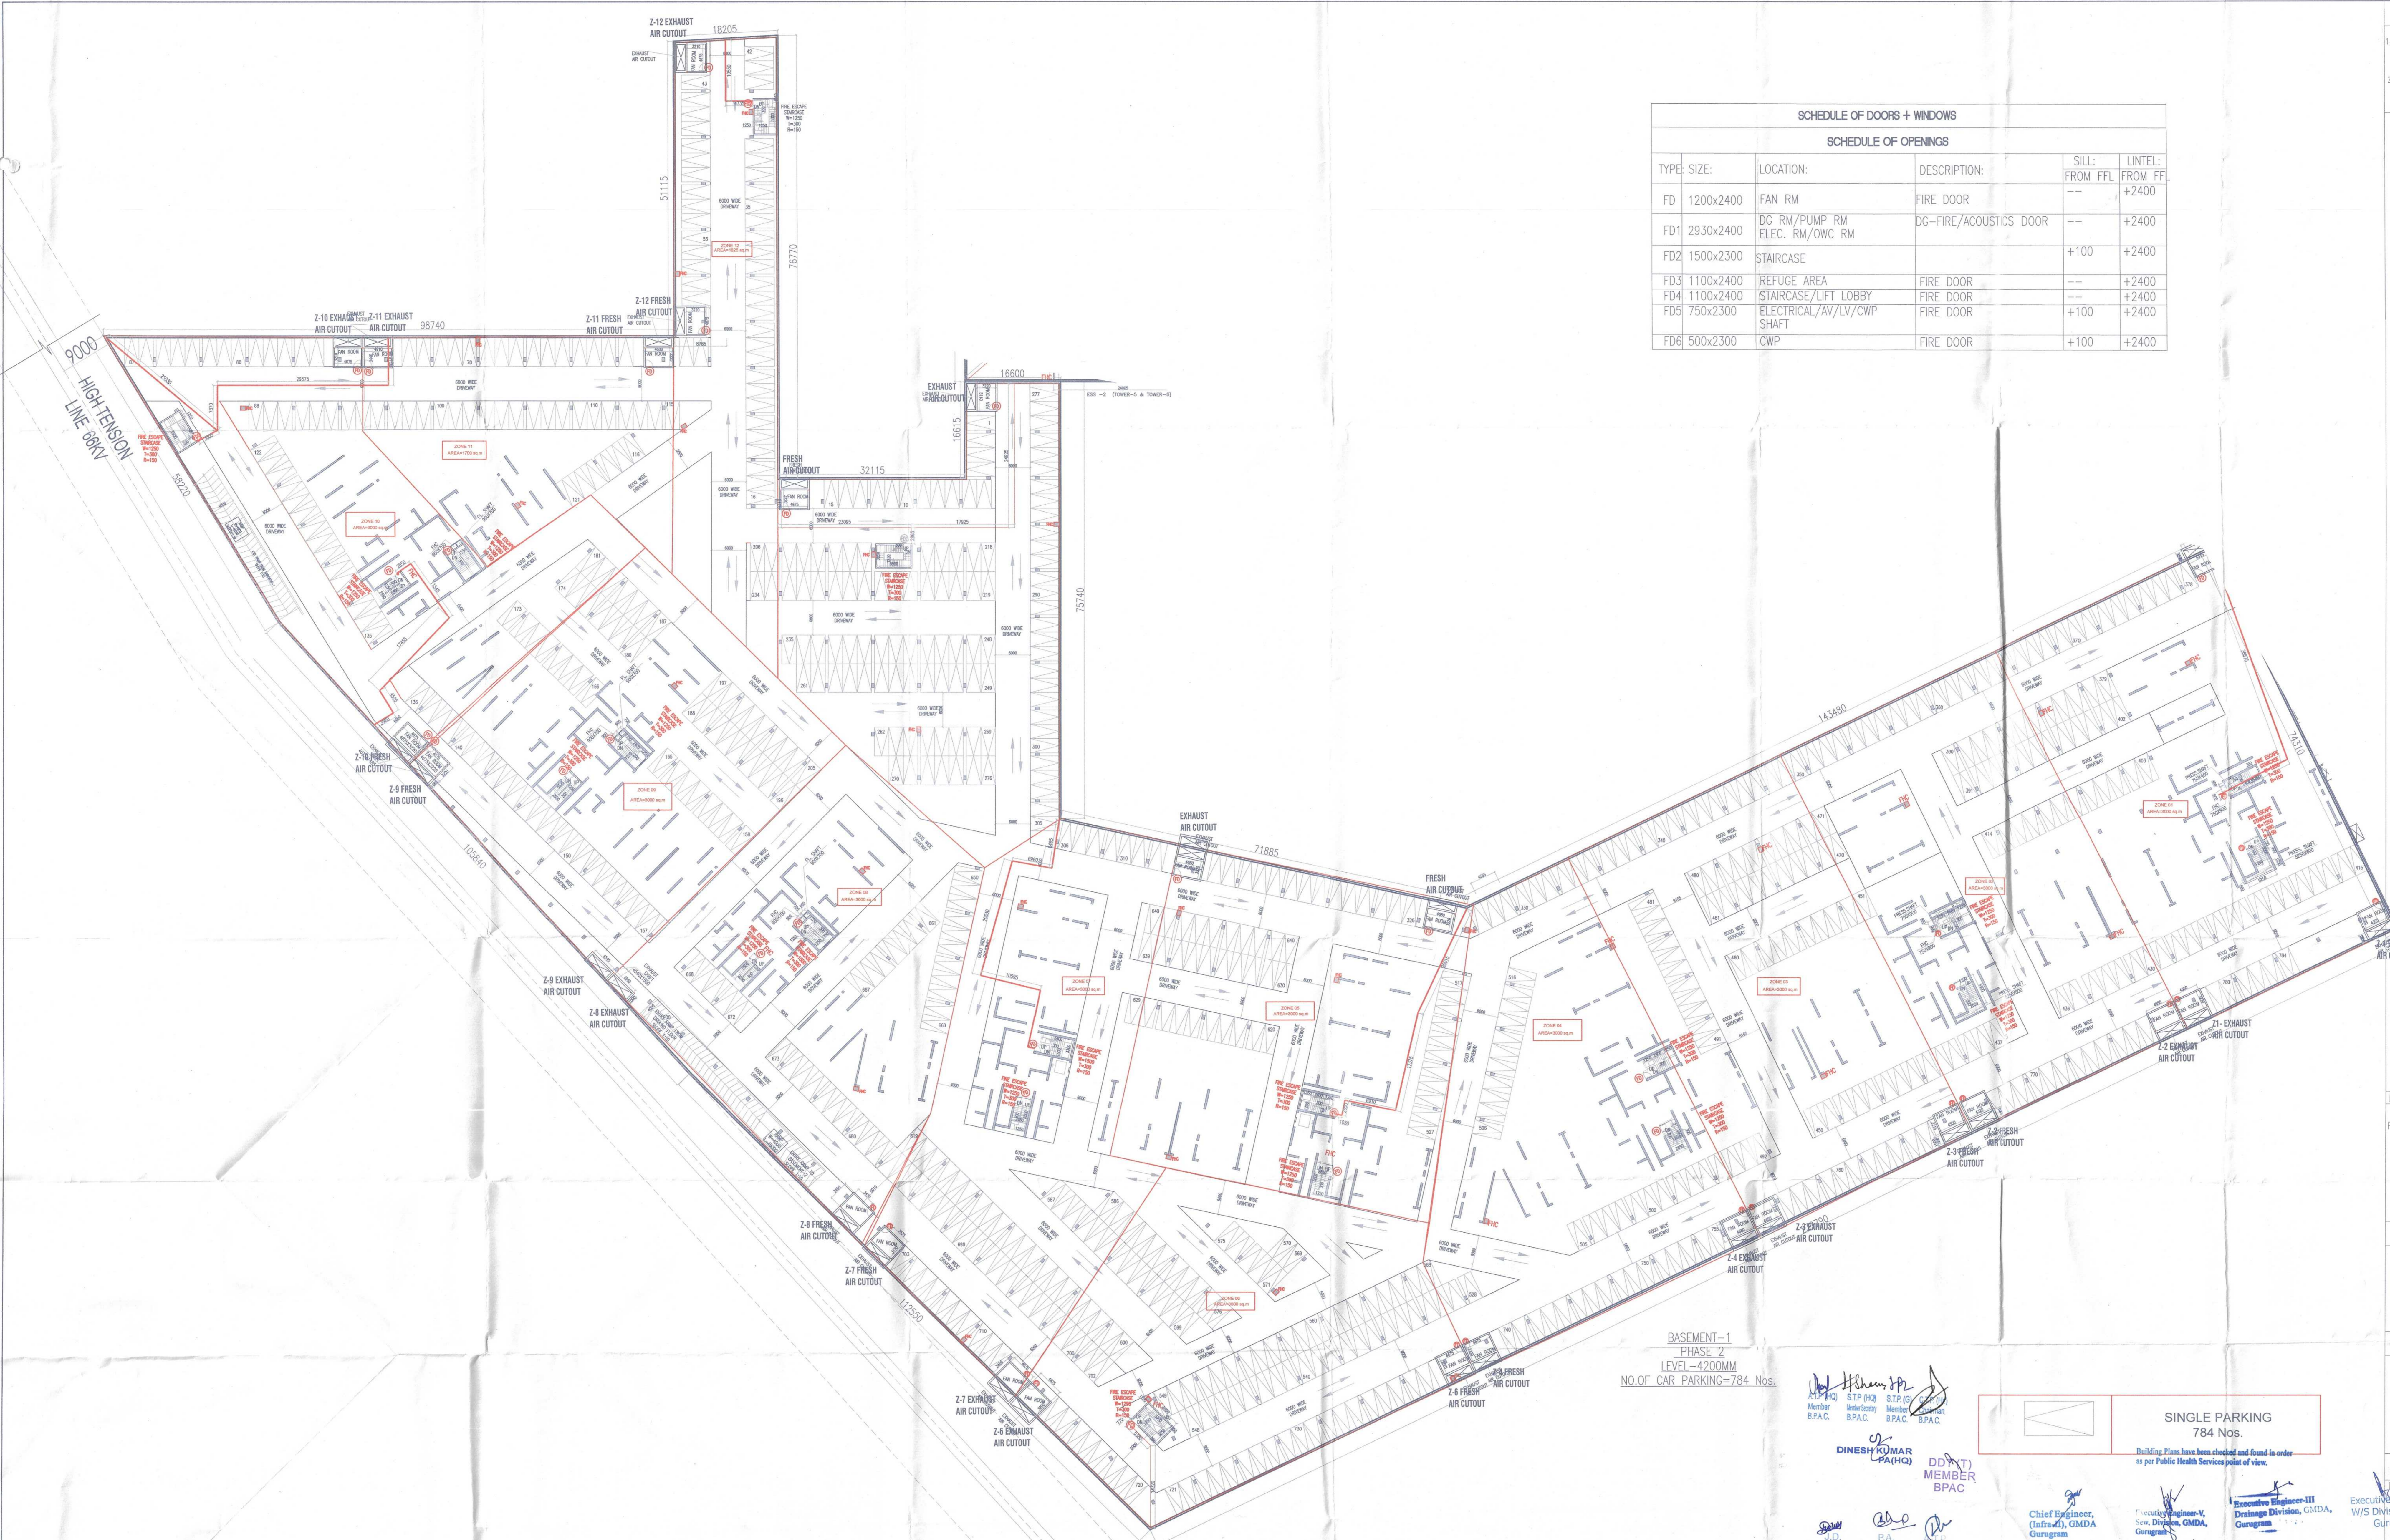

SCHEDULE OF DOORS + WINDOWS					
SCHEDULE OF OPENINGS					
TYPE:	SIZE:	LOCATION:	DESCRIPTION:	SILL: FROM FFL	LINTEL: FROM FF
FD	1200x2400	FAN RM	FIRE DOOR	---	+2400
FD1	2930x2400	DG RM/PUMP RM ELEC. RM/OWC RM	DG-FIRE/ACOUSTICS DOOR	---	+2400
FD2	1500x2300	STAIRCASE		+100	+2400
FD3	1100x2400	REFUGE AREA	FIRE DOOR	---	+2400
FD4	1100x2400	STAIRCASE/LIFT LOBBY	FIRE DOOR	---	+2400
FD5	750x2300	ELECTRICAL/AV/LV/CWP SHAFT	FIRE DOOR	+100	+2400
FD6	500x2300	CWP	FIRE DOOR	+100	+2400

Note:-
 1. BUILDING HAS AUTOMATIC SPRINKLER SYSTEM WHEREVER REQUIRED BY NBC.
 2. BUILDING WILL BE DESIGNED (STRUCTURES) AS PER RELEVANT IS CODES FOR EARTH QUAKE RESISTANCE.

BASEMENT-1
 PHASE 2
 LEVEL-4200MM
 NO. OF CAR PARKING=784 Nos.

(Signature)
 DINESH KUMAR
 P.A.(H)
 MEMBER
 B.P.A.C.

SINGLE PARKING
 784 Nos.
 Building Plans have been checked and found in order as per Public Health Services point of view.

Chief Engineer,
 (Infra), GMDA
 Gurugram

Executive Engineer-III,
 Sew. Division, GMDA,
 Gurugram

Executive Engineer-III,
 Drainage Division, GMDA,
 Gurugram

PROJECT:
 PROPOSED Building Plan GROUP HOUSING COLONY
 MEASURING
 24.10 ACRES (LICENCE NO 80 OF
 2012 DATED 17/08/2012)
 IN SECTOR 106, GURUGRAM MANESAR URBAN
 COMPLEX BEING DEVELOPED BY ARMD
 DEVELOPERS LTD. & OTHERS.

OWNER'S SEAL
 & SIGNATURE

(Signature)
 Authorised Signatory,
 Armd Developers Limited

ARCHITECT'S SEAL
 & SIGNATURE

(Signature)
 AVINASH CHANDRA VAIDYA
 Architect No. CA/75/02008
 H. No. 103, P/14B
 New Palam Vihar, Gurugram

AUG-2022 Scale: 1:300
 Drawing Title:
 Executive Engineer-IV
 W/S Division, GMDA
 Gurugram PHASE 2
 BASEMENT-1- PLANS
 Drawing No:
 BA-05

SANCTIONED
 TO BE READ WITH THIS OFFICE
 MEMO NO. DATED:



BASEMENT-01 AREA CALCULATION					
GROSS - 1					
B1 = 0.5 X 1 X	1.010	X	18.175	=	9.178 SQM
B2 = 1 X 1 X	18.175	X	51.115	=	929.015 SQM
B3 = 0.5 X 1 X	42.550	X	70.110	=	1491.590 SQM
B4 = 1 X 1 X	74.365	X	70.110	=	5213.730 SQM
B5 = 1 X 1 X	16.260	X	16.915	=	275.038 SQM
B6 = 0.5 X 1 X	29.315	X	29.010	=	425.214 SQM
B7 = 1 X 1 X	45.075	X	29.010	=	1307.626 SQM
B8 = 1 X 1 X	48.715	X	74.475	=	3628.050 SQM
B9 = 0.5 X 1 X	15.350	X	70.225	=	538.977 SQM
B10 = 0.5 X 1 X	74.980	X	122.660	=	4592.390 SQM
B11 = 0.5 X 1 X	26.350	X	74.330	=	979.298 SQM
B12 = 1 X 1 X	239.495	X	74.330	=	17801.663 SQM
					TOTAL = 37191.770 SQM
GROSS - 2					
S1 = 1 X 4 X	7.100	X	4.250	=	120.700 SQM
S2 = 1 X 6 X	3.200	X	5.900	=	113.280 SQM
S3 = 1 X 6 X	6.800	X	4.000	=	158.400 SQM
S4 = 1 X 1 X	6.600	X	5.000	=	33.000 SQM
S5 = 1 X 1 X	3.200	X	6.750	=	21.600 SQM
S6 = 1 X 1 X	2.750	X	1.200	=	3.300 SQM
					TOTAL = 450.280 SQM
CUTOUT					
C1 = 1 X 4 X	3.450	X	1.350	=	18.630 SQM
C2 = 1 X 7 X	1.500	X	3.000	=	31.500 SQM
C3 = 1 X 7 X	2.400	X	0.300	=	5.040 SQM
C4 = 1 X 16 X	0.900	X	0.700	=	10.080 SQM
C5 = 1 X 1 X	4.100	X	0.650	=	2.865 SQM
C6 = 1 X 1 X	1.900	X	0.650	=	1.235 SQM
C7 = 1 X 1 X	5.250	X	0.650	=	3.413 SQM
					TOTAL = 72.563 SQM
NET AREA OF BASEMENT - 01					
			GROSS - 1	-	GROSS - 3
			37191.770 SQM		72.563 SQM
			TOTAL		37119.207 SQM
SERVICE AREA OF BASEMENT - 01					
					GROSS - 2
					450.280 SQM
					TOTAL
					36668.927 SQM
NET PARKING AREA OF BASEMENT - 01					
			GROSS - 1	-	GROSS - 2
			37191.770 SQM		450.280 SQM
					GROSS - 3
					72.563 SQM
			TOTAL		36668.927 SQM
NO OF CAR ACHEIVABLE OF BASEMENT -01					
					1146 CARS
OR SAY					
					1146 CARS

Note :-
 1. BUILDING HAS AUTOMATIC SPRINKLER SYSTEM WHEREVER REQUIRED BY NBC.
 2. BUILDING WILL BE DESIGNED STRUCTURES! AS PER RELEVANT IS CODES FOR EARTH QUAKE RESISTANCE

PROJECT:
 PROPOSED Building Plan GROUP HOUSING COLONY MEASURING 24.10 ACRES (LICENCE NO 80 OF 2012 DATED 17/08/2012) IN SECTOR 106, GURUGRAM MANESAR URBAN COMPLEX BEING DEVELOPED BY AIRMID DEVELOPERS LTD. & OTHERS.

OWNER'S SEAL & SIGNATURE
 Airmid Developers Limited

ARCHITECT'S SEAL & SIGNATURE
 Authorized Signatory


Signature
 Member B.P.A.C. B.P.A.C. B.P.A.C. B.P.A.C.
DINESH KUMAR
 P.A. (H.O.)

Building Plans have been checked and found in order as per Public Health Services point of view.
 Chief Engineer, W/S Division, GHDA Gurugram
 Executive Engineer-V, Sew. Division, GHDA Gurugram
 Executive Engineer-III, Drainage Division, GHDA Gurugram

Signature
 Architect No. CA/7502/2008 H. No. 163, P/41 New Palam Vihar, Gurugram

SANCTIONED TO BE READ WITH THIS OFFICE MEMO NO. naven:
 DD (CT) MEMBER BPAC

Scale : 1:300
 PHASE 2 AREA OF BASEMENT-1
 Drawing No. BA-06
 Executive Engineer-1 W/S Division, GHDA Gurugram

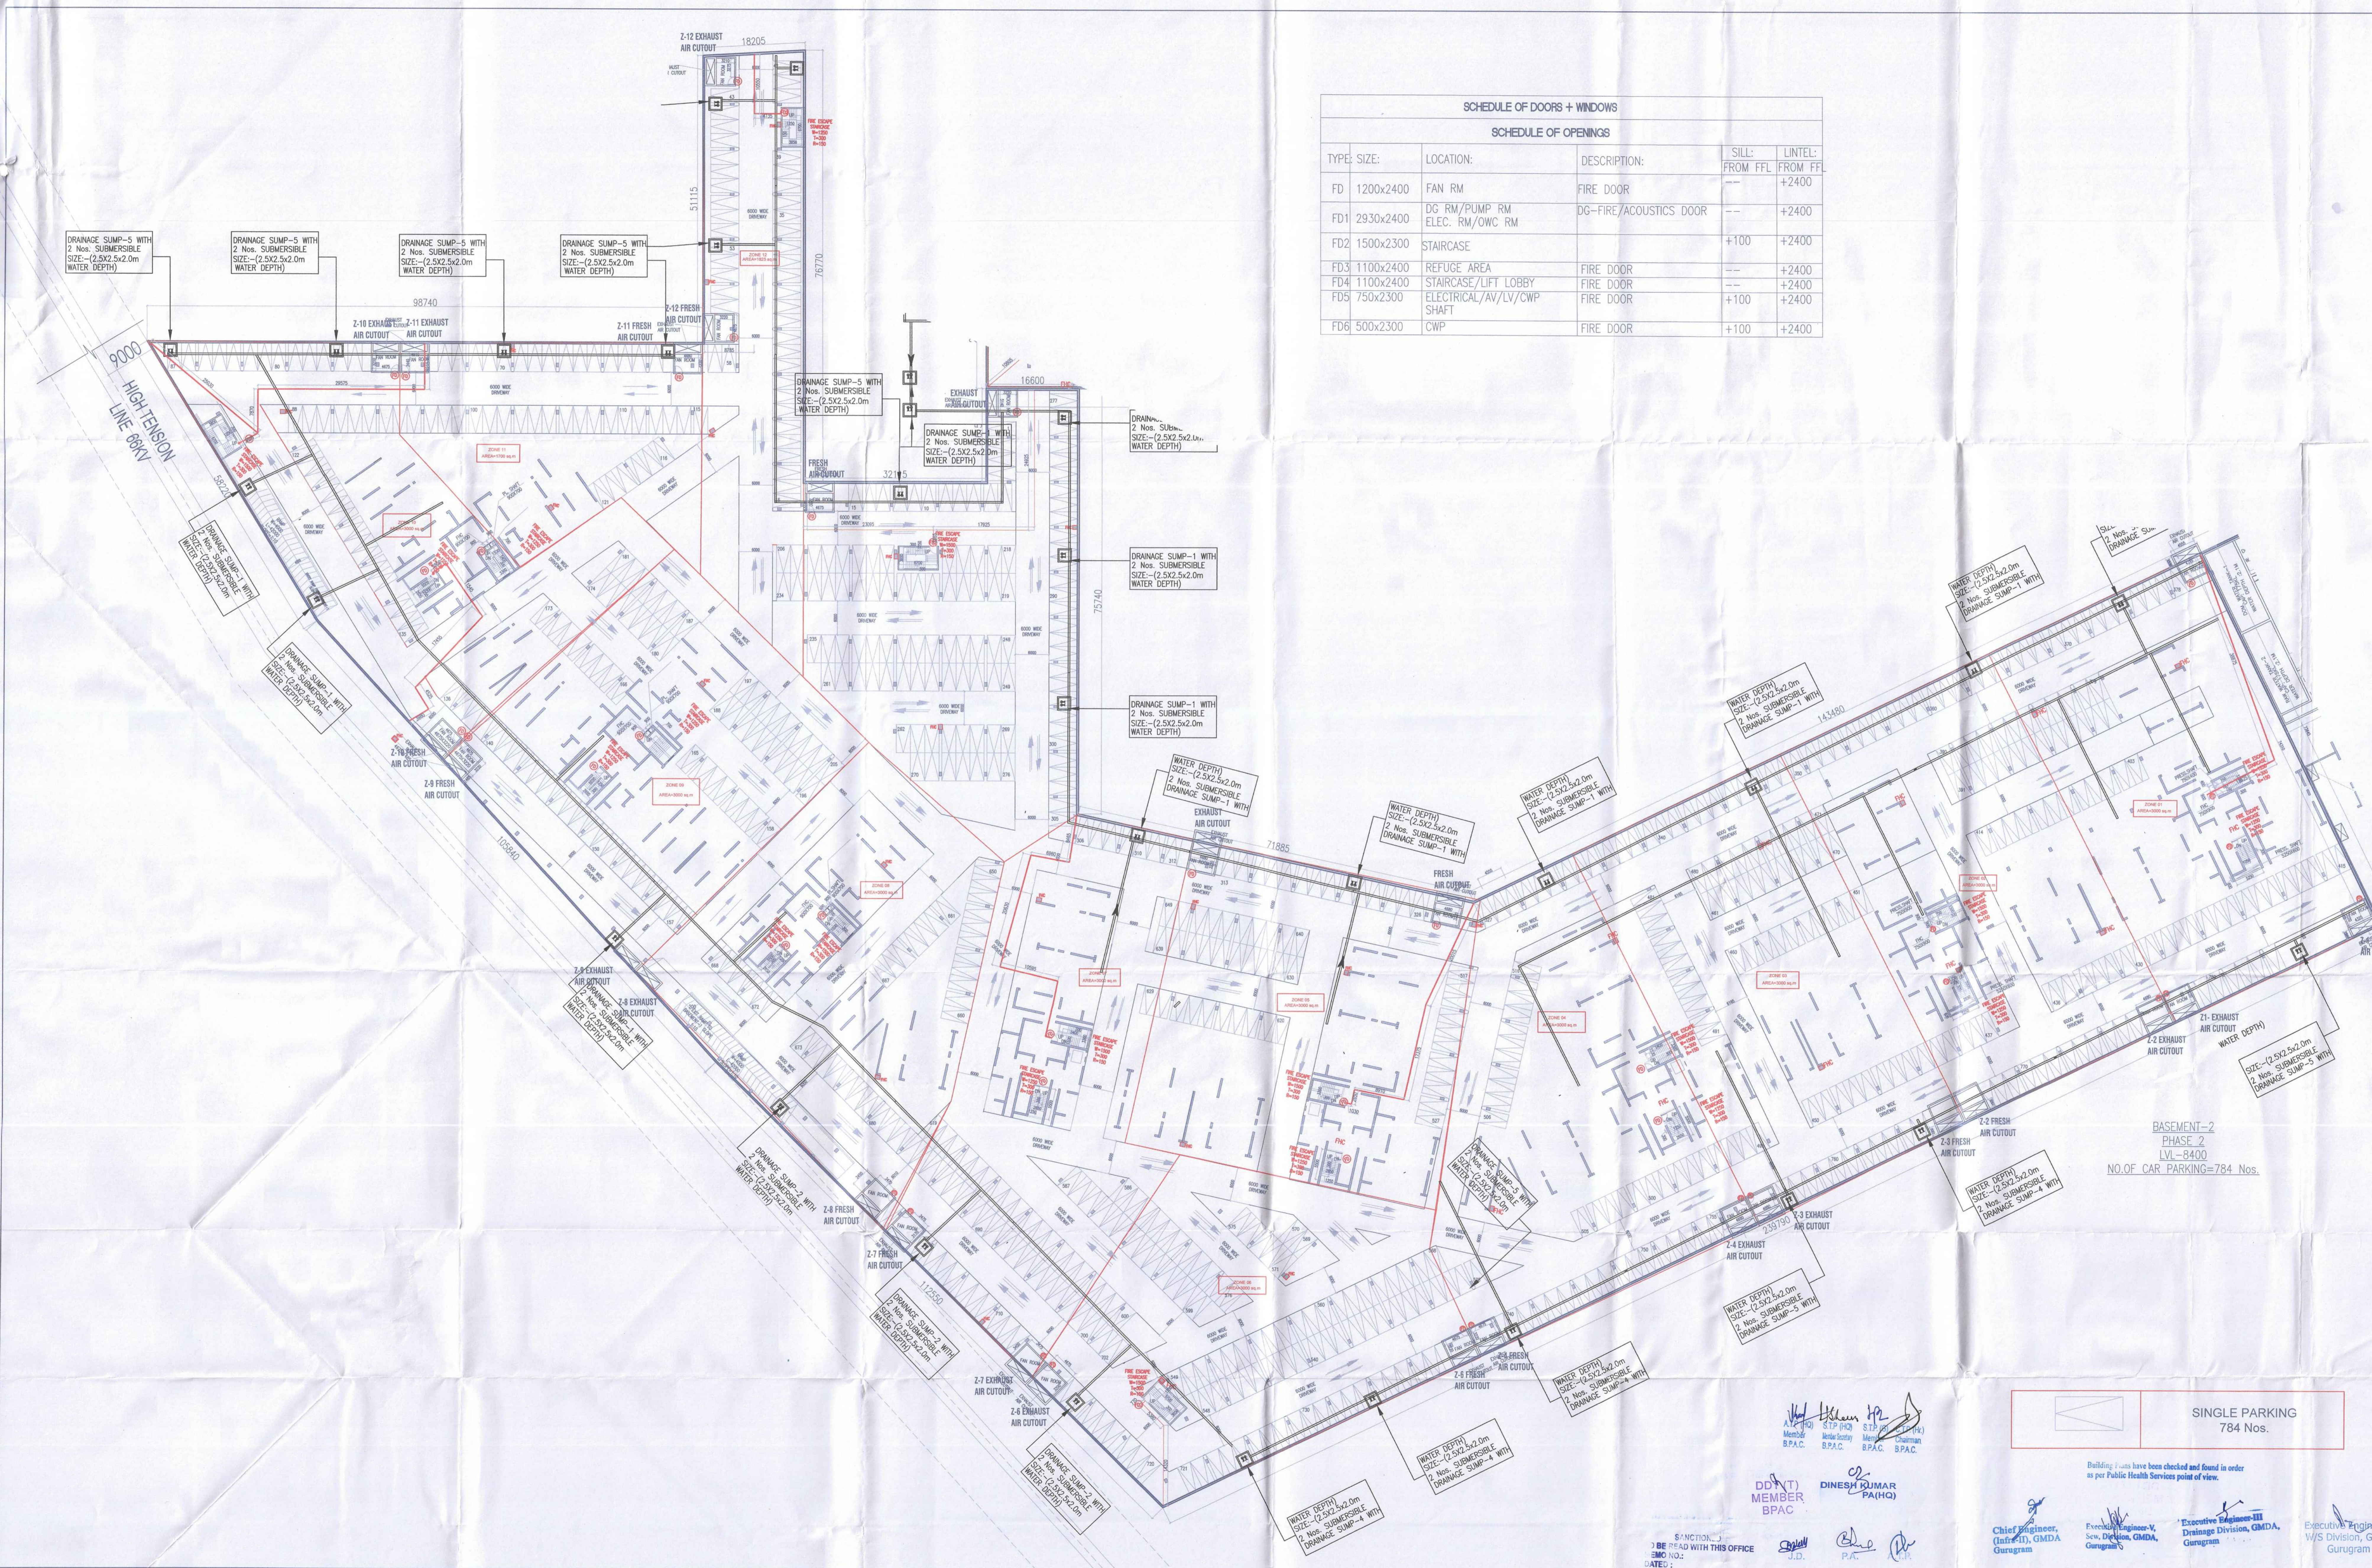

SCHEDULE OF DOORS + WINDOWS

SCHEDULE OF OPENINGS

TYPE:	SIZE:	LOCATION:	DESCRIPTION:	SILL: FROM FFL:	LINTEL: FROM FF:
FD	1200x2400	FAN RM	FIRE DOOR	---	+2400
FD1	2930x2400	DC RM/PUMP RM ELEC. RM/OWC RM	DG-FIRE/ACOUSTICS DOOR	---	+2400
FD2	1500x2300	STAIRCASE	---	+100	+2400
FD3	1100x2400	REFUGE AREA	FIRE DOOR	---	+2400
FD4	1100x2400	STAIRCASE/LIFT LOBBY	FIRE DOOR	---	+2400
FD5	750x2300	ELECTRICAL/AV/LV/CWP SHAFT	FIRE DOOR	+100	+2400
FD6	500x2300	CWP	FIRE DOOR	+100	+2400

Note:-

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BASEMENT-2
PHASE 2
 LVL-8400
 NO.OF CAR PARKING=784 Nos.

SINGLE PARKING
 784 Nos.

DDNT MEMBER BPAC
DINESH KUMAR PA(HG)

Chief Engineer, (Inf-III), GMDA Gurugram
Executive Engineer, Drainage Division, GMDA Gurugram
Executive Engineer, W/S Division, GMDA Gurugram

AVIRASH CHANDRA VAIDYA
 Architect No. CA7800000
 H. No. 163, PH-II
 New Palm Vihar, Gurugram

AUG-2022 Scale: 1:300
 Drawing Title: PHASE 2 BASEMENT-02
 Drawing No: BA-07

PROJECT:
 PROPOSED Building Plan GROUP HOUSING COLONY MEASURING 24.10 ACRES (LICENCE NO. 80 OF 2012 DATED 17/08/2012) IN SECTOR 106, GURUGRAM MANESAR URBAN COMPLEX BEING DEVELOPED BY ARMD DEVELOPERS LTD. & OTHERS.

OWNER'S SEAL & SIGNATURE
 Armd Developers Limited

ARCHITECT'S SEAL & SIGNATURE
 Avirash Chandra Vaidya



BASEMENT-02 AREA CALCULATION											
GROSS - 1											
B1	=	0.5	X	1	X	1.010	X	18.175	=	9.178	SQM
B2	=	1	X	1	X	18.175	X	51.115	=	929.015	SQM
B3	=	0.5	X	1	X	42.550	X	70.110	=	1491.590	SQM
B4	=	1	X	1	X	74.365	X	70.110	=	5213.730	SQM
B5	=	1	X	1	X	16.260	X	16.915	=	275.038	SQM
B6	=	0.5	X	1	X	29.315	X	29.010	=	425.214	SQM
B7	=	1	X	1	X	45.075	X	29.010	=	1307.626	SQM
B8	=	1	X	1	X	48.715	X	74.475	=	3628.050	SQM
B9	=	0.5	X	1	X	15.350	X	70.225	=	538.977	SQM
B10	=	0.5	X	1	X	74.880	X	122.660	=	4592.390	SQM
B11	=	0.5	X	1	X	26.350	X	74.330	=	979.298	SQM
B12	=	1	X	1	X	239.495	X	74.330	=	17801.663	SQM
TOTAL									=	37191.770	SQM
SERVICE AREA											
GROSS - 2											
S1	=	1	X	4	X	7.100	X	4.250	=	120.700	SQM
S2	=	1	X	6	X	3.200	X	5.900	=	113.280	SQM
S3	=	1	X	6	X	6.600	X	4.000	=	158.400	SQM
S4	=	1	X	1	X	6.600	X	5.000	=	33.000	SQM
S5	=	1	X	1	X	3.200	X	6.750	=	21.600	SQM
S6	=	1	X	1	X	2.750	X	1.200	=	3.300	SQM
TOTAL									=	450.280	SQM
NET AREA OF BASEMENT - 02									GROSS - 1		
									37191.770	SQM	
SERVICE AREA OF BASEMENT - 02									=	GROSS - 2	
TOTAL									=	450.280	SQM
NET PARKING AREA OF BASEMENT - 02									=	GROSS - 1	-
									=	37191.770	-
TOTAL									=	36741.490	SQM
NO OF CAR ACHIEVABLE OF BASEMENT - 02									=	36741.490	/
OR SAY									=	1148	CARS

Note :-
 1. BUILDING HAS AUTOMATIC SPRINKLER SYSTEM WHEREVER REQUIRED BY NBC.
 2. BUILDING WILL BE DESIGNED STRUCTURE AS PER RELEVANT IS CODES FOR EARTHQUAKE RESISTANCE.

PROJECT:
 PROPOSED Building Plan GROUP HOUSING COLONY MEASURING 24.10 ACRES (LICENCE NO RD OF 2012 DATED 17/08/2012) IN SECTOR 106, GURUGRAM MANESAR URBAN COMPLEX BEING DEVELOPED BY ARIMD DEVELOPERS LTD. & OTHERS.

OWNER'S SEAL & SIGNATURE
 Arimd Developers Limited
 Authorized Signatory

ARCHITECT'S SEAL & SIGNATURE
 ANITASH CHANDRA
 Architect No. 10000
 H. No. 363, P.H.II
 New Patam Vihar, Gurugram

AUG.-2022. Scale : 1:300
 Drawing Title:- PHASE 2 AREA OF BASEMENT-1
 Drawing No:- BS-08

Executive Engineer-IV
 W/S Division, GMDA
 Gurugram

Executive Engineer-V
 Sewerage Division, GMDA
 Gurugram

Executive Engineer-III
 Design Division, GMDA, B.P.A.C.
 Gurugram

Member
 B.P.A.C.

Member
 B.P.A.C.

Member
 B.P.A.C.

Member
 B.P.A.C.

Member
 B.P.A.C.

DINESH KUMAR
 P.A.(HQ)

Chief Engineer,
 (Traffic), GMDA
 Gurugram

J.D.
 P.A.

P.P.

DDP (N)
 MEMBER
 BPAC

SANCTIONED
 BE READ WITH THIS OFFICE
 NO.:-
 SD:-



ELEVATION-03
TOWER-3 & 4

Note:-
1. BUILDING HAS AUTOMATIC SPRINKLER SYSTEM WHEREVER REQUIRED BY NBC.
2. BUILDING WILL BE DESIGNED (STRUCTURES) AS PER RELEVANT IS CODES FOR EARTH QUAKE RESISTANCE.

KEY PLAN

Sanctioned
MEMO NO.:-
DATED:-

DINESH KUMAR
PA(HQ)

DD (NT)
MEMBER
BPAC

Architect's Seal & Signature

PROJECT:
PROPOSED BUILDING PLAN OF GROUP HOUSING COLONY MEASURING 24.10 ACRES (LICENCE NO 80 OF 2012 DATED 17/08/2012) IN SECTOR 106, GURUGRAM MANESAR URBAN COMPLEX BEING DEVELOPED BY ARMID DEVELOPERS LTD. & OTHERS.

OWNER'S SEAL & SIGNATURE

ARCHITECT'S SEAL & SIGNATURE


Architect's Seal & Signature

Architect's Seal & Signature

Architect No. CA7502006
H. No. 163, Ph-II
New Palam Vihar, Gurugram


AUG.-2022. Scale : 1:100
Drawing Title:- TOWER- 3,4,5 & 6 ELEVATION-1
Drawing No:- C-07

ELEVATION-01
TOWER-3 & 4

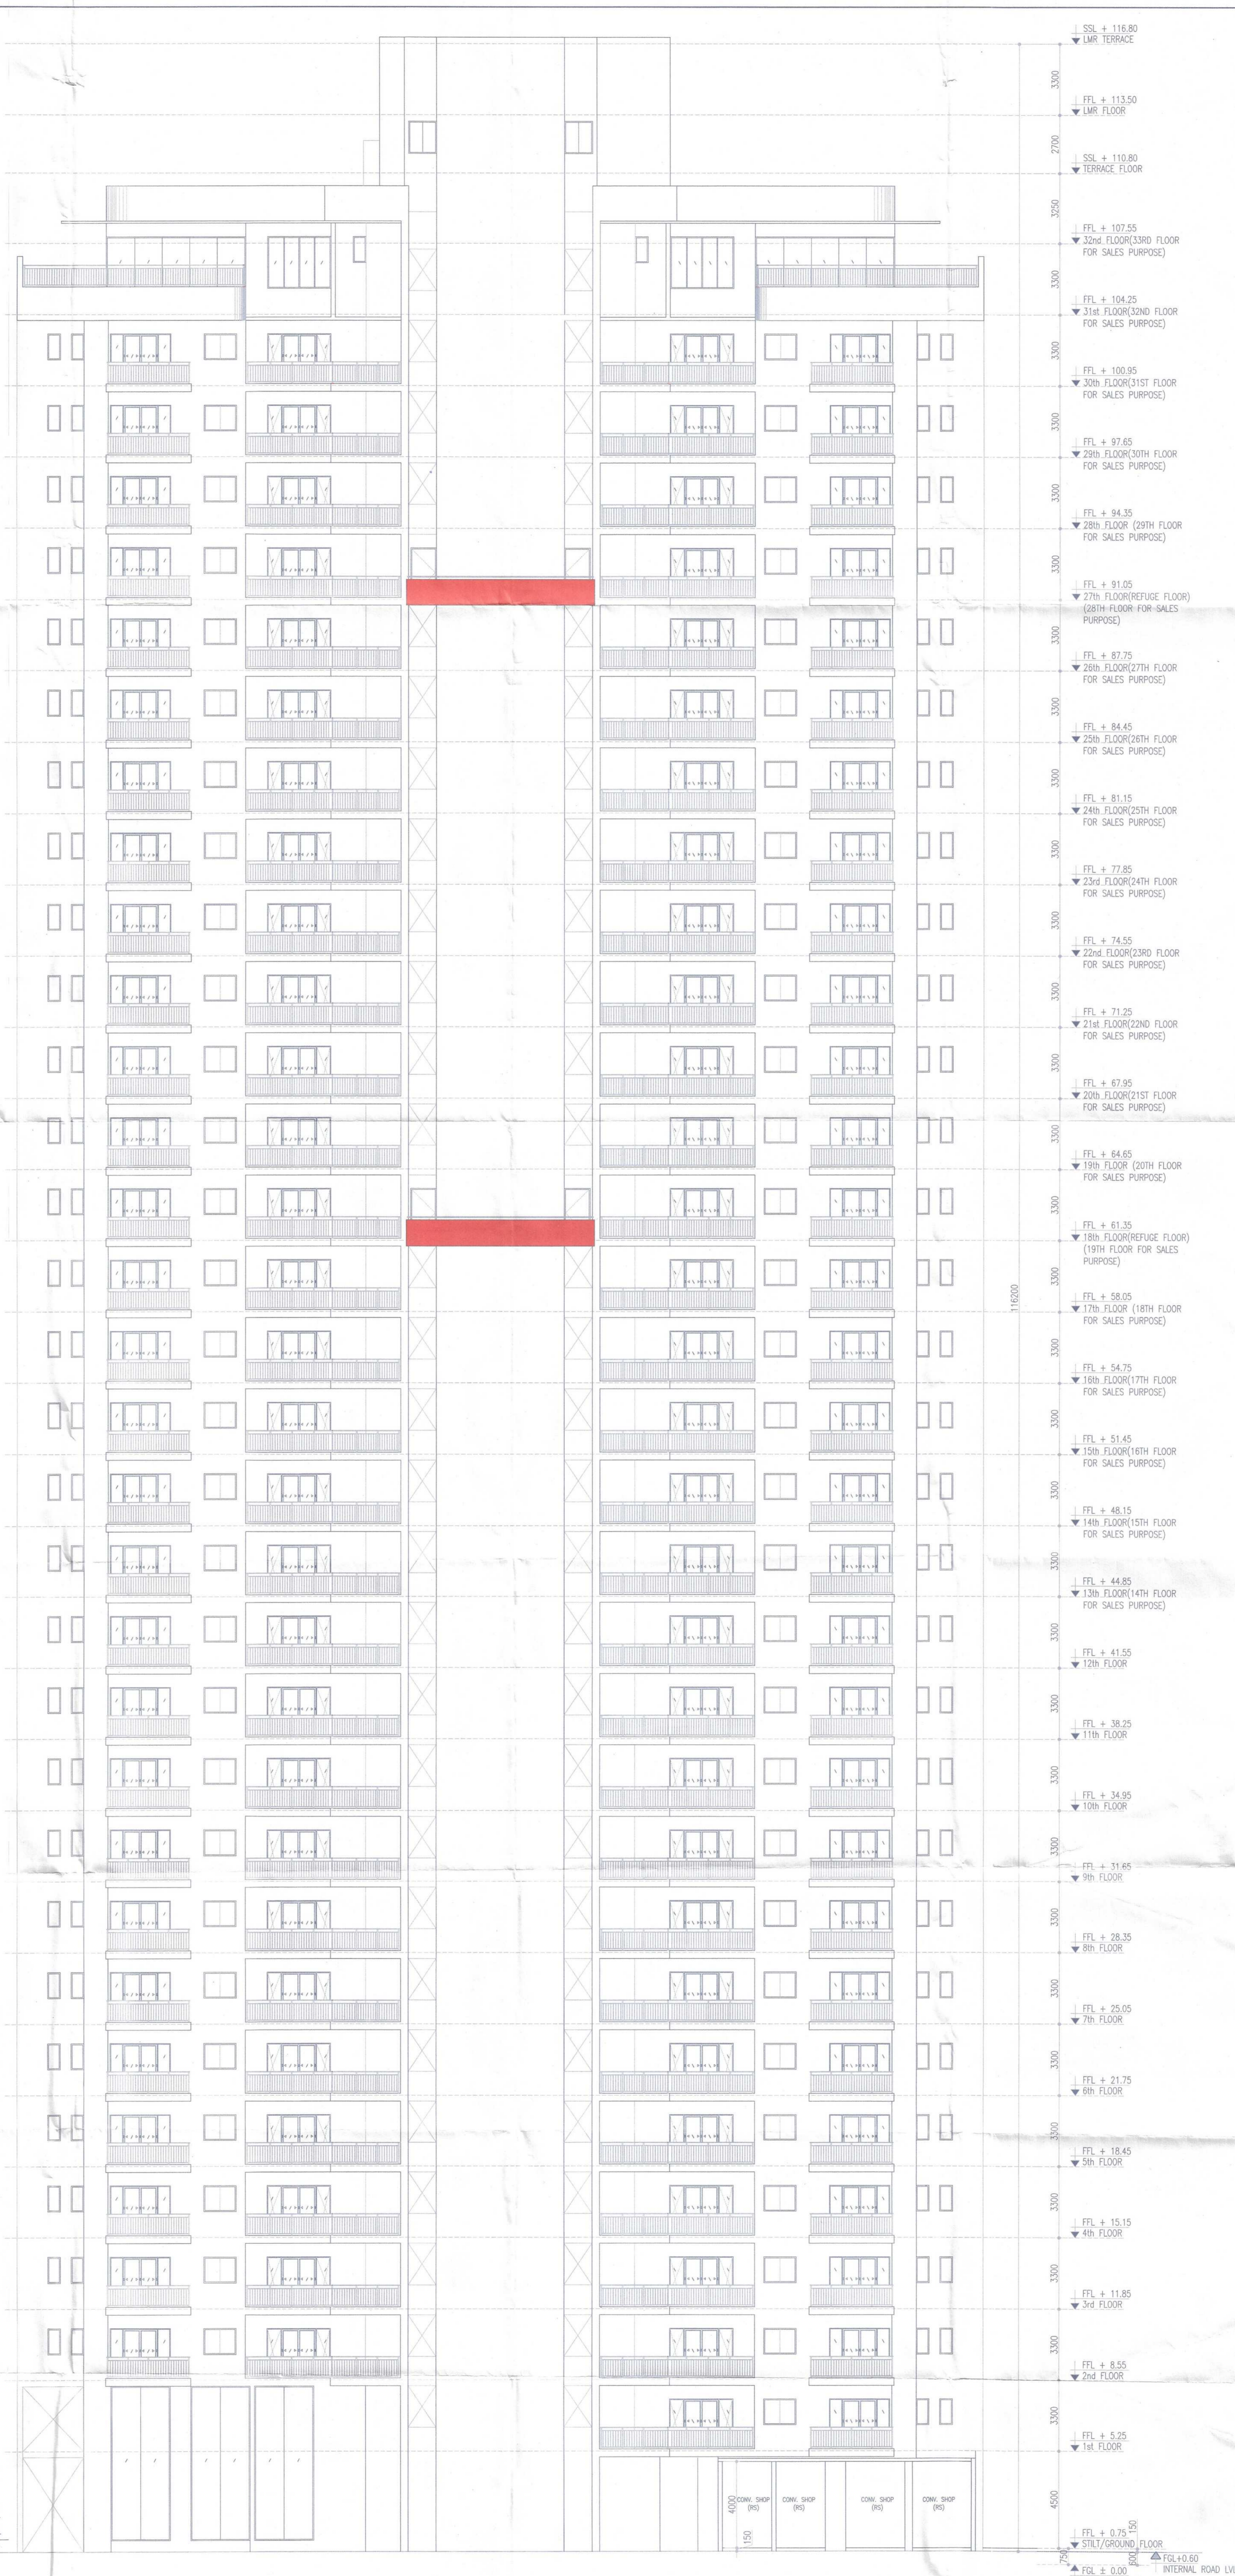

SSL + 116.80 LMR TERRACE	3300
FFL + 113.50 LMR FLOOR	2700
SSL + 110.80 TERRACE FLOOR	3250
FFL + 107.55 32nd FLOOR(33RD FLOOR FOR SALES PURPOSE)	3300
FFL + 104.25 31st FLOOR(32ND FLOOR FOR SALES PURPOSE)	3300
FFL + 100.95 30th FLOOR(31ST FLOOR FOR SALES PURPOSE)	3300
FFL + 97.65 29th FLOOR(30TH FLOOR FOR SALES PURPOSE)	3300
FFL + 94.35 28th FLOOR(29TH FLOOR FOR SALES PURPOSE)	3300
FFL + 91.05 27th FLOOR(REFUGE FLOOR) (28TH FLOOR FOR SALES PURPOSE)	3300
FFL + 87.75 26th FLOOR(27TH FLOOR FOR SALES PURPOSE)	3300
FFL + 84.45 25th FLOOR(26TH FLOOR FOR SALES PURPOSE)	3300
FFL + 81.15 24th FLOOR(25TH FLOOR FOR SALES PURPOSE)	3300
FFL + 77.85 23rd FLOOR(24TH FLOOR FOR SALES PURPOSE)	3300
FFL + 74.55 22nd FLOOR(23RD FLOOR FOR SALES PURPOSE)	3300
FFL + 71.25 21st FLOOR(22ND FLOOR FOR SALES PURPOSE)	3300
FFL + 67.95 20th FLOOR(21ST FLOOR FOR SALES PURPOSE)	3300
FFL + 64.65 19th FLOOR(20TH FLOOR FOR SALES PURPOSE)	3300
FFL + 61.35 18th FLOOR(REFUGE FLOOR) (19TH FLOOR FOR SALES PURPOSE)	3300
FFL + 58.05 17th FLOOR(18TH FLOOR FOR SALES PURPOSE)	3300
FFL + 54.75 16th FLOOR(17TH FLOOR FOR SALES PURPOSE)	3300
FFL + 51.45 15th FLOOR(16TH FLOOR FOR SALES PURPOSE)	3300
FFL + 48.15 14th FLOOR(15TH FLOOR FOR SALES PURPOSE)	3300
FFL + 44.85 13th FLOOR(14TH FLOOR FOR SALES PURPOSE)	3300
FFL + 41.55 12th FLOOR	3300
FFL + 38.25 11th FLOOR	3300
FFL + 34.95 10th FLOOR	3300
FFL + 31.65 9th FLOOR	3300
FFL + 28.35 8th FLOOR	3300
FFL + 25.05 7th FLOOR	3300
FFL + 21.75 6th FLOOR	3300
FFL + 18.45 5th FLOOR	3300
FFL + 15.15 4th FLOOR	3300
FFL + 11.85 3rd FLOOR	3300
FFL + 8.55 2nd FLOOR	3300
FFL + 5.25 1st FLOOR	3300
FFL + 0.75 STL/GROUND FLOOR	6000
FFL + 0.00 NON TOWER LVL	7500

Note:-
1. BUILDING HAS AUTOMATIC SPRINKLER SYSTEM WHEREVER REQUIRED BY NBC.
2. BUILDING WILL BE DESIGNED (STRUCTURES) AS PER RELEVANT IS CODES FOR EARTH QUAKE RESISTANCE.

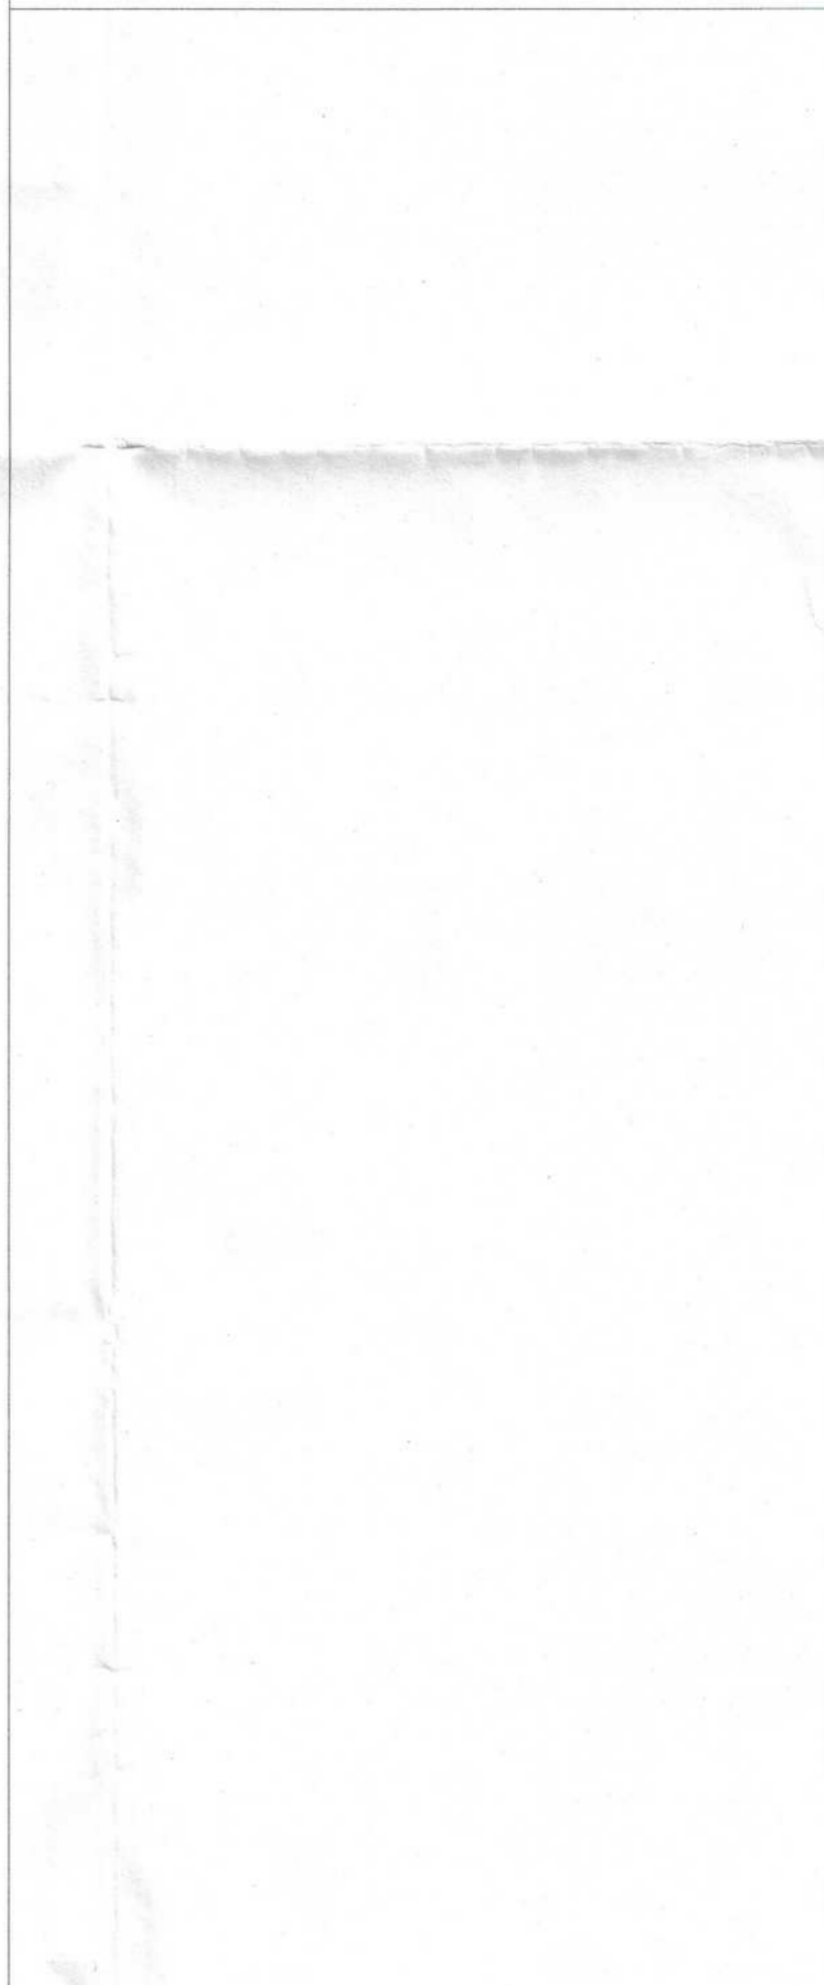

Sanctioned
MEMO NO. _____
DATED: _____

Member B.P.A.C. Member B.P.A.C. Member B.P.A.C. Member B.P.A.C.

DINESH KUMAR PA(HQ)

DOTA MEMBER B.P.A.C.

PROJECT:
PROPOSED BUILDING PLAN OF GROUP HOUSING COLONY MEASURING 24.10 ACRES (LICENCE NO 80 OF 2012 DATED 17/08/2012) IN SECTOR 106, GURUGRAM MANESAR URBAN COMPLEX BEING DEVELOPED BY AIRMID DEVELOPERS LTD. & OTHERS.


OWNER'S SEAL & SIGNATURE

Airmid Developers Limited

ARCHITECT'S SEAL & SIGNATURE

Avinash Chandra Vaidya
Architect No. CA7502008
H. No. 163, P-14
New Palam Vihar, Gurugram

AUG.-2022. Scale: 1:100
Drawing Title:- TOWER-3 & 4 ELEVATION-1
Drawing No. C-07a

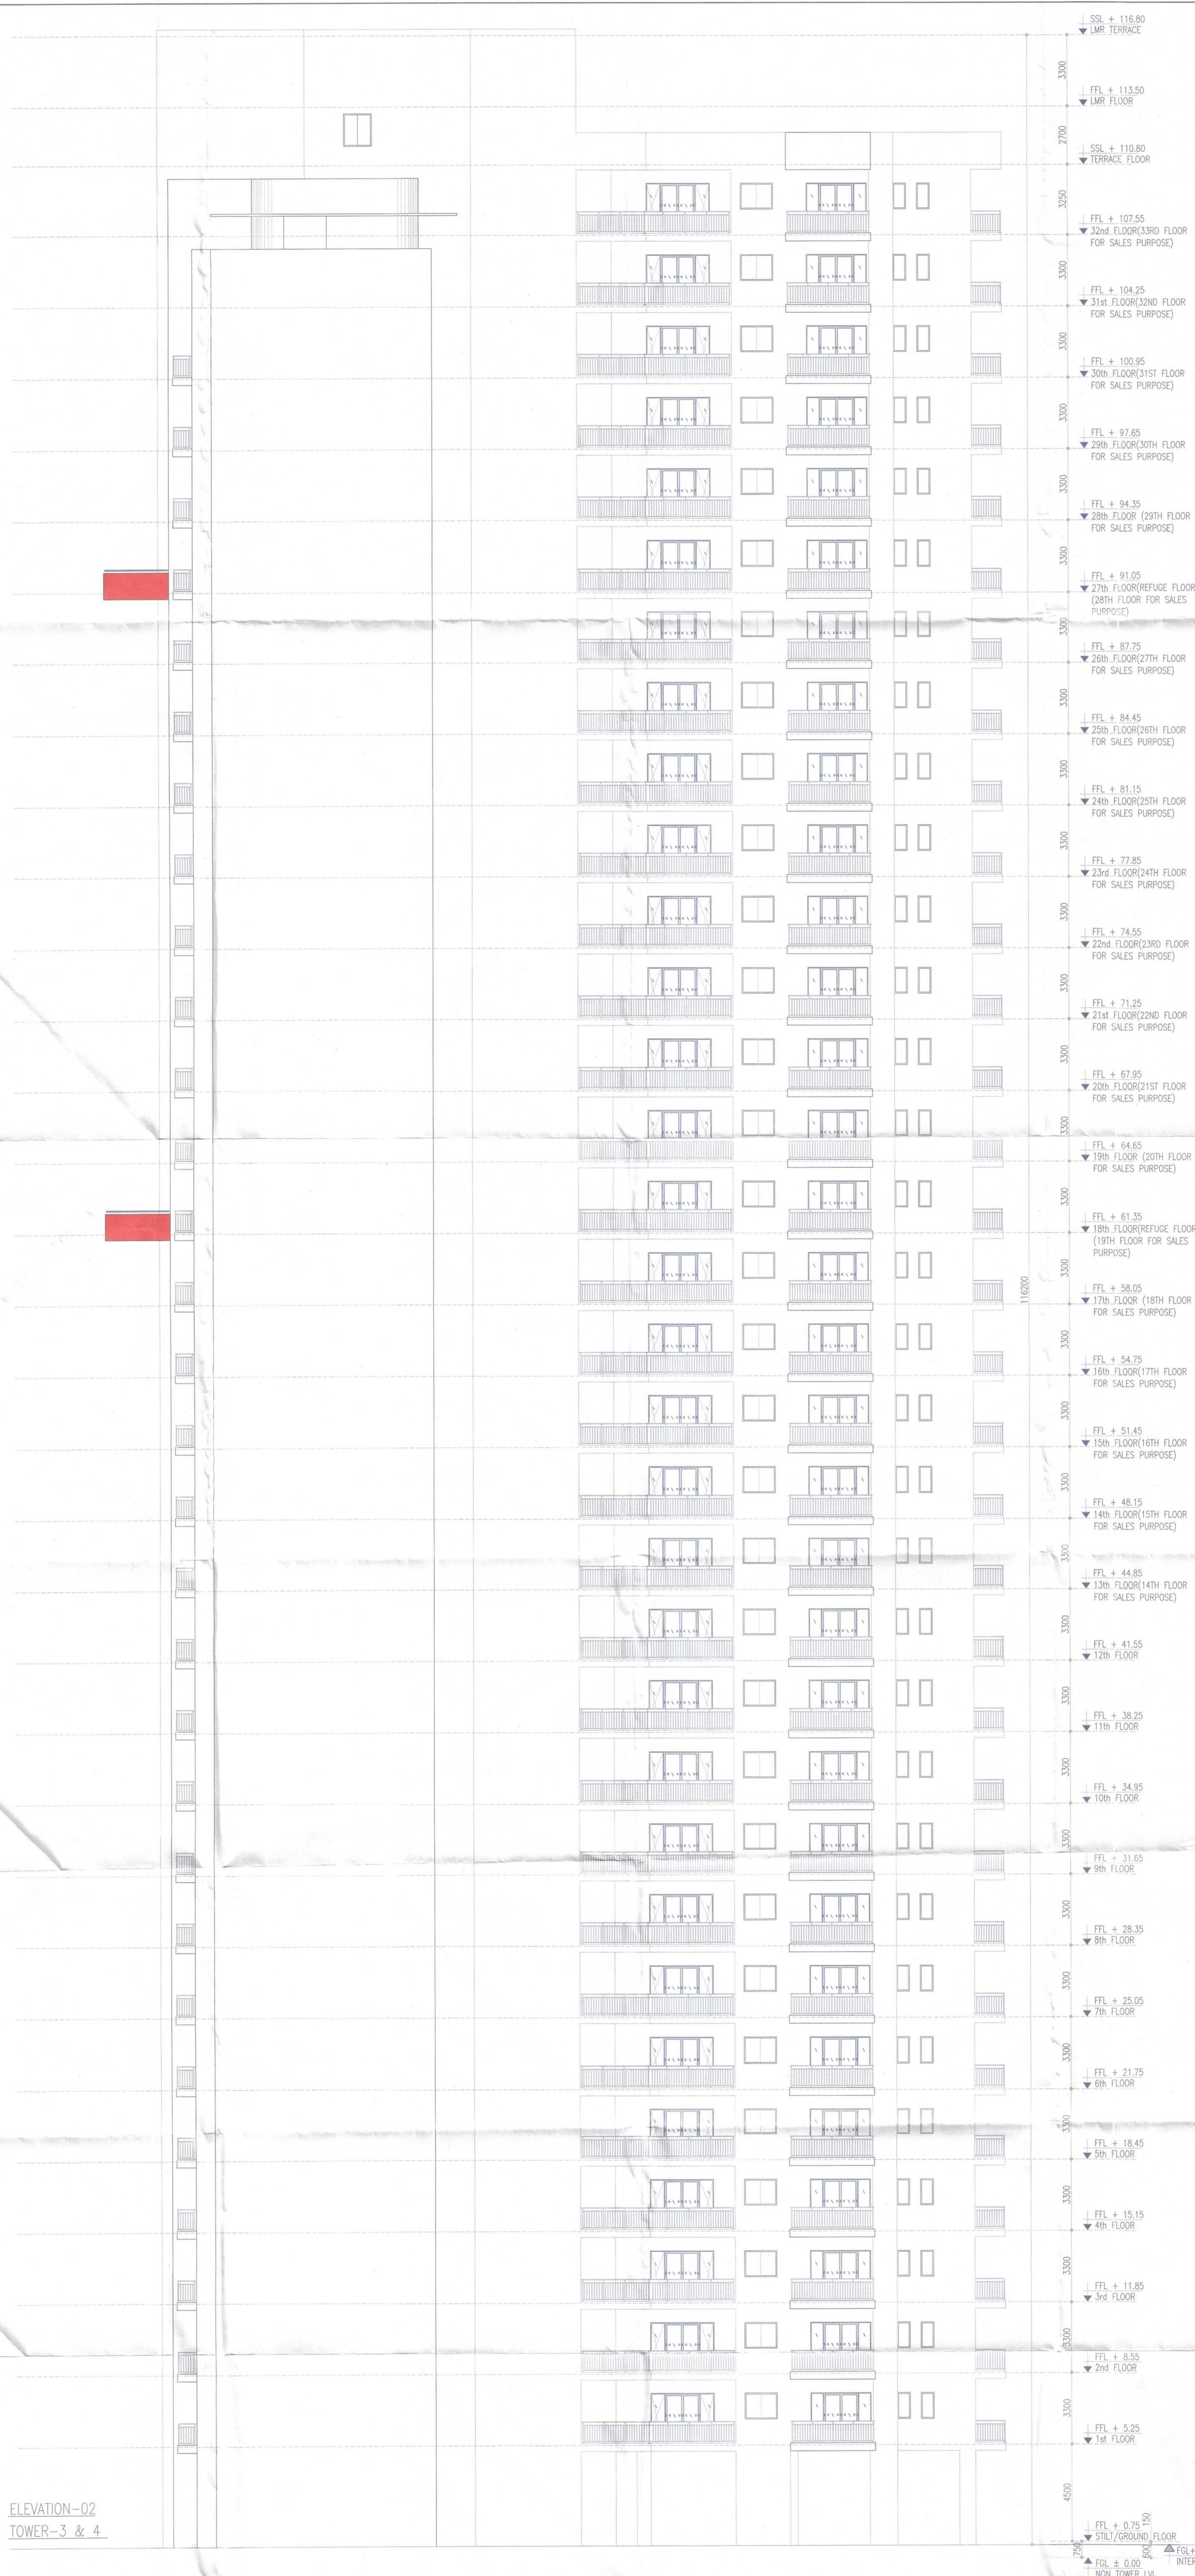

SSL + 116.80
 UMR TERRACE
 FFL + 113.50
 UMR FLOOR
 SSL + 110.80
 TERRACE FLOOR
 FFL + 107.55
 32nd FLOOR (33RD FLOOR FOR SALES PURPOSE)
 FFL + 104.25
 31st FLOOR (32ND FLOOR FOR SALES PURPOSE)
 FFL + 100.95
 30th FLOOR (31ST FLOOR FOR SALES PURPOSE)
 FFL + 97.65
 29th FLOOR (30TH FLOOR FOR SALES PURPOSE)
 FFL + 94.35
 28th FLOOR (29TH FLOOR FOR SALES PURPOSE)
 FFL + 91.05
 27th FLOOR (REFUSE FLOOR) (28TH FLOOR FOR SALES PURPOSE)
 FFL + 87.75
 26th FLOOR (27TH FLOOR FOR SALES PURPOSE)
 FFL + 84.45
 25th FLOOR (26TH FLOOR FOR SALES PURPOSE)
 FFL + 81.15
 24th FLOOR (25TH FLOOR FOR SALES PURPOSE)
 FFL + 77.85
 23rd FLOOR (24TH FLOOR FOR SALES PURPOSE)
 FFL + 74.55
 22nd FLOOR (23RD FLOOR FOR SALES PURPOSE)
 FFL + 71.25
 21st FLOOR (22ND FLOOR FOR SALES PURPOSE)
 FFL + 67.95
 20th FLOOR (21ST FLOOR FOR SALES PURPOSE)
 FFL + 64.65
 19th FLOOR (20TH FLOOR FOR SALES PURPOSE)
 FFL + 61.35
 18th FLOOR (REFUSE FLOOR) (19TH FLOOR FOR SALES PURPOSE)
 FFL + 58.05
 17th FLOOR (18TH FLOOR FOR SALES PURPOSE)
 FFL + 54.75
 16th FLOOR (17TH FLOOR FOR SALES PURPOSE)
 FFL + 51.45
 15th FLOOR (16TH FLOOR FOR SALES PURPOSE)
 FFL + 48.15
 14th FLOOR (15TH FLOOR FOR SALES PURPOSE)
 FFL + 44.85
 13th FLOOR (14TH FLOOR FOR SALES PURPOSE)
 FFL + 41.55
 12th FLOOR
 FFL + 38.25
 11th FLOOR
 FFL + 34.95
 10th FLOOR
 FFL + 31.65
 9th FLOOR
 FFL + 28.35
 8th FLOOR
 FFL + 25.05
 7th FLOOR
 FFL + 21.75
 6th FLOOR
 FFL + 18.45
 5th FLOOR
 FFL + 15.15
 4th FLOOR
 FFL + 11.85
 3rd FLOOR
 FFL + 8.55
 2nd FLOOR
 FFL + 5.25
 1st FLOOR
 FFL + 0.75
 STK/GROUND FLOOR
 FGL ± 0.00
 NON TOWER LVL
 FGL + 0.60
 INTERNAL ROAD LVL

Note :-
 1. BUILDING HAS AUTOMATIC SPRINKLER SYSTEM WHEREVER REQUIRED BY NBC.
 2. BUILDING WILL BE DESIGNED (STRUCTURES) AS PER RELEVANT IS CODES FOR EARTH QUAKE RESISTANCE.

KEY PLAN

SANCTIONED TO BE READ WITH THIS OFFICE MEMO NO. DATED :-

PROJECT:
 PROPOSED BUILDING PLAN OF GROUP HOUSING COLONY MEASURING 24.10 ACRES (LICENCE NO 80 OF 2012 DATED 17/08/2012) IN SECTOR 106, GURUGRAM MANESAR URBAN COMPLEX BEING DEVELOPED BY AIRMID DEVELOPERS LTD. & OTHERS.

OWNER'S SEAL & SIGNATURE
 ARCHITECT'S SEAL & SIGNATURE

AUG-2022 Scale : 1:100
 Drawing Title:- **TOWER- 3,4,5 & 6**
 ELEVATION-2
 Drawing No:- C-08

ELEVATION-02
 TOWER-3 & 4



ELEVATION-03
TOWER-3 & 4

Note:-

- BUILDING HAS AUTOMATIC SPRINKLER SYSTEM WHEREVER REQUIRED BY NBC.
- BUILDING WILL BE DESIGNED (STRUCTURES) AS PER RELEVANT IS CODES FOR EARTH QUAKE RESISTANCE.

KEY PLAN

(Signature)
A.P.A.C. S.T.P.(H) S.T.P.(C) S.T.P.(M)
Member B.P.A.C. Member B.P.A.C. Member B.P.A.C.

SANCTIONED
TO BE READ WITH THIS OFFICE
MEMO NO. 1113

DINESH KUMAR
P.A.(H) MEMBER B.P.A.C.

(Signature)
J.D. P.A. A.P.

PROJECT:
PROPOSED BUILDING PLAN OF GROUP HOUSING COLONY MEASURING 24.10 ACRES (LICENCE NO 80 OF 2012 DATED 17/08/2012) IN SECTOR 106, GURUGRAM MANESAR URBAN COMPLEX BEING DEVELOPED BY AIRMID DEVELOPERS LTD. & OTHERS.

OWNER'S SEAL & SIGNATURE

ARCHITECT'S SEAL & SIGNATURE

Airmid Developers Limited
Authorizing Signatory

(Signature)
AVINASH CHANDRA VADYA
Architect No. CA/75/2006
H. No. 163, PH-1
New Palm Vihar, Gurugram

AUG-2022. Scale : 1:100
Drawing Title:-
TOWER- 3,4,5 & 6
ELEVATION-3
Drawing No. C-09


ELEVATION-04
TOWER-3 & 4



Note:-

- BUILDING HAS AUTOMATIC SPRINKLER SYSTEM WHEREVER REQUIRED BY NBC.
- BUILDING WILL BE DESIGNED (STRUCTURES) AS PER RELEVANT IS CODES FOR EARTH QUAKE RESISTANCE.

KEY PLAN

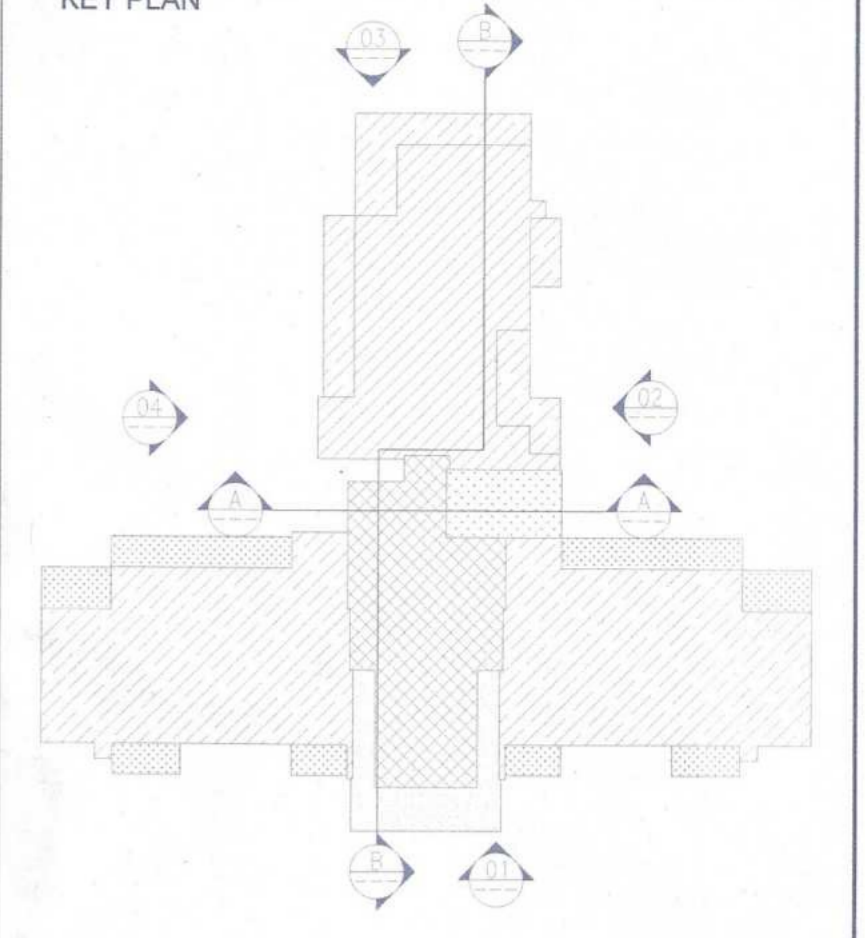

Handwritten signature
A.T.P. (P) S.T.P. (P) S.T.P. (P)
Member B.P.A.C. Member B.P.A.C. Member B.P.A.C.

SANCTIONED
TO BE READ WITH THIS OFFICE
MEMO NO: _____
DATED: _____

Handwritten signature
DINESH KUMAR
P.A.(H)
DDT MEMBER
B.P.A.C.

Handwritten signature J.D.
Handwritten signature P.A.
Handwritten signature A.T.P.

PROJECT:

PROPOSED BUILDING PLAN OF GROUP HOUSING COLONY MEASURING 24.10 ACRES (LICENCE NO 80 OF 2012 DATED 17/08/2012) IN SECTOR 106, GURUGRAM MANESAR URBAN COMPLEX BEING DEVELOPED BY AIRMID DEVELOPERS LTD. & OTHERS.

OWNER'S SEAL & SIGNATURE

Handwritten signature
Airmid Developers Limited
Authorized Signatory

ARCHITECT'S SEAL & SIGNATURE

Handwritten signature
AVINASH CHANDRA RAIDYA
Architect No. CA7602005
H. No. 163, PH-II
New Palam Vihar, Gurugram

AUG-2022

Scale : 1:100



Drawing Title:-

TOWER- 3,4,5 & 6
ELEVATION-4

Drawing No:-

C-10

Note:-
 1. BUILDING HAS AUTOMATIC SPRINKLER SYSTEM WHEREVER REQUIRED BY NBC.
 2. BUILDING WILL BE DESIGNED (STRUCTURES) AS PER RELEVANT IS CODES FOR EARTH QUAKE RESISTANCE.

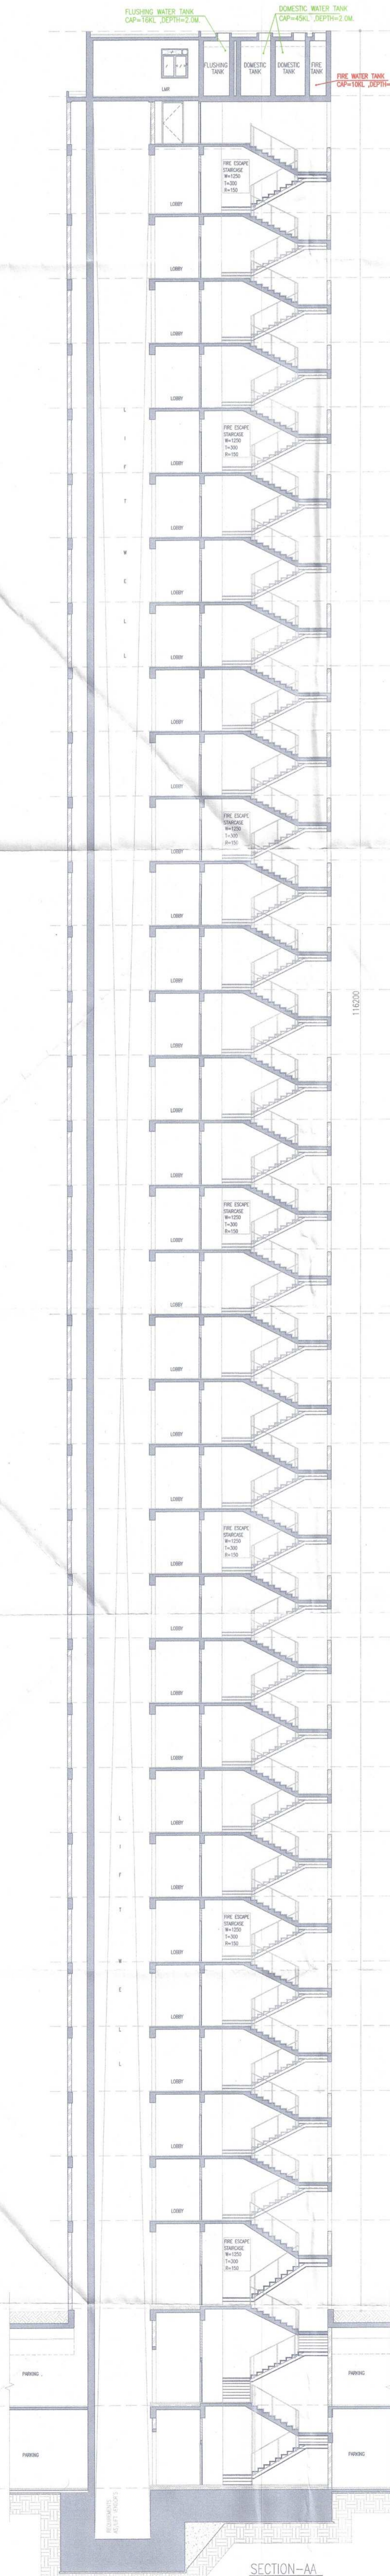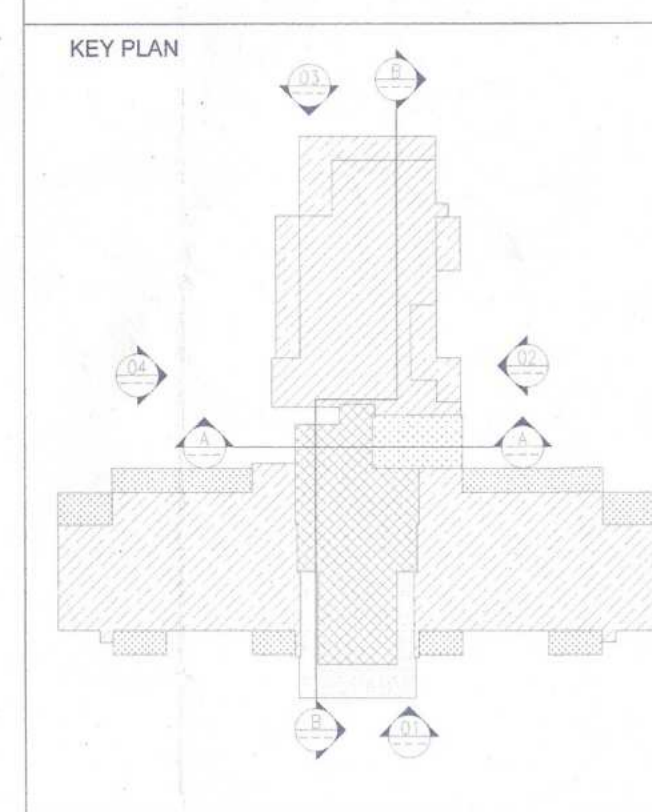

SECTION-AA



SECTION-BB



Sanctioned
 MEMO NO. _____
 DATED: _____

ATP (HQ) Member B.P.A.C.
 S.P. (HQ) Member B.P.A.C.
 S.P. (G) Member B.P.A.C.
 S.P. (G) Member B.P.A.C.

DINESH KUMAR PA(HQ) MEMBER B.P.A.C.

J.D. P.A. A.P.

DD(M) MEMBER B.P.A.C.

PROJECT:
 PROPOSED BUILDING PLAN OF GROUP HOUSING COLONY MEASURING 24.10 ACRES (LICENCE NO 80 OF 2012 DATED 17/08/2012) IN SECTOR 106, GURUGRAM MANESAR URBAN COMPLEX BEING DEVELOPED BY ARMD DEVELOPERS LTD. & OTHERS.

Architect's Seal & Signature:
 A/ANASHT/ANANDRA/ANIDYA
 Architect No. CA/75/02/006
 H. No. 103, PH-II
 New Palm Vihar, Gurugram

Building Plans have been checked and found in order as per Public Health Services point of view.

Executive Engineer-I
Sew. Division, GMDA,
Gurugram

Executive Engineer-II
Drainage Division, GMDA,
Gurugram

Chief Engineer,
(Civil), GMDA,
Gurugram


Note :-

- BUILDING HAS AUTOMATIC SPRINKLER SYSTEM WHEREVER REQUIRED BY NBC.
- BUILDING WILL BE DESIGNED (STRUCTURES) AS PER RELEVANT IS CODES FOR EARTH QUAKE RESISTANCE.


Sanctioned
MEMO NO. :-
DATED :-

Member B.P.A.C. Member B.P.A.C. Member B.P.A.C. Member B.P.A.C.


DINESH KUMAR PAHQ

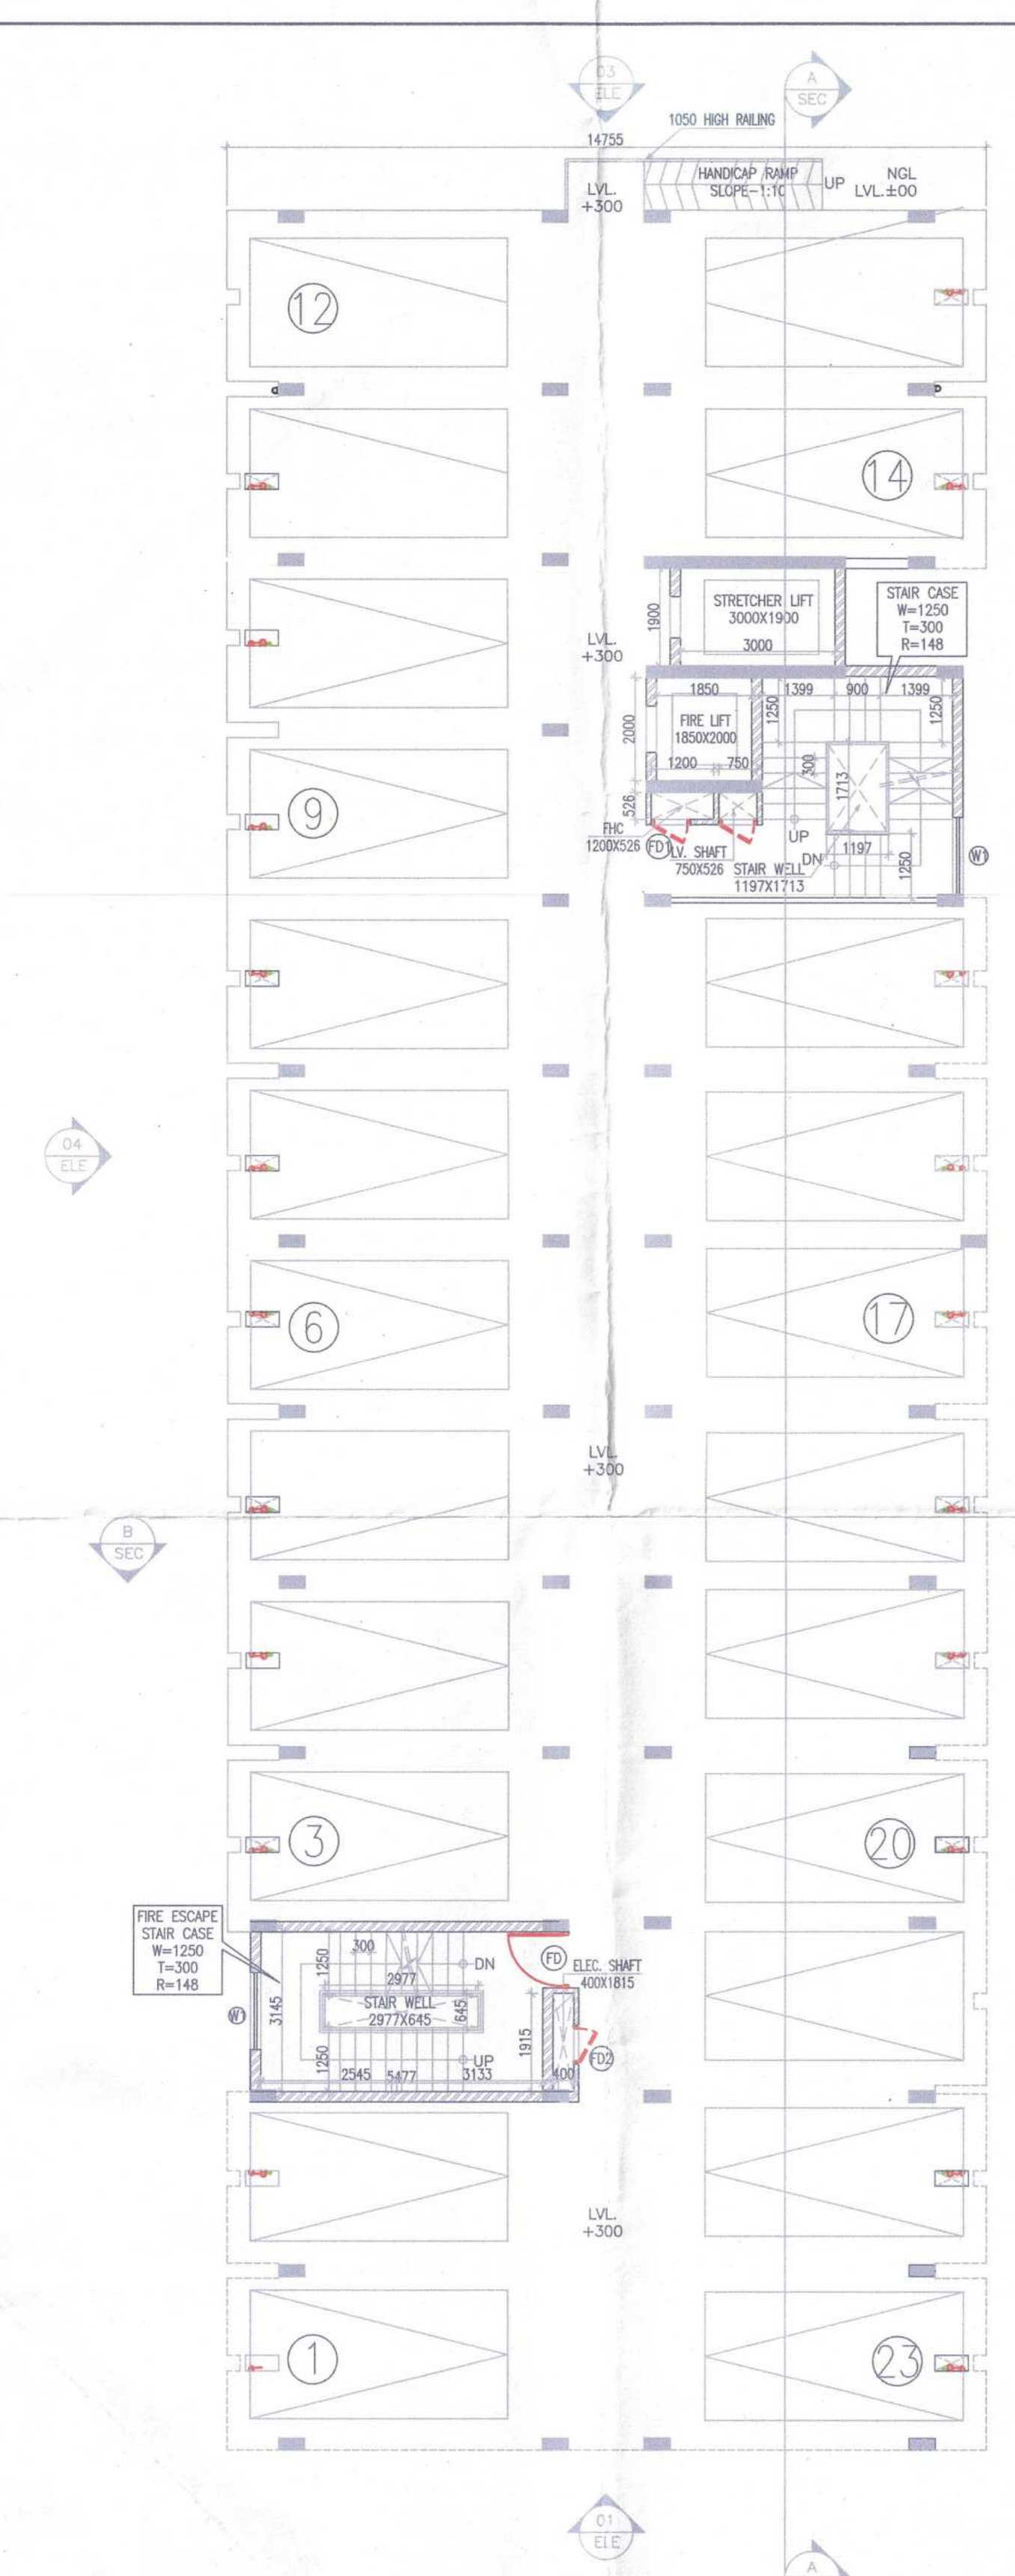


GROUND FLOOR PLAN
LVL+300
EWS
TOTAL CARS PARKING=23 EWS

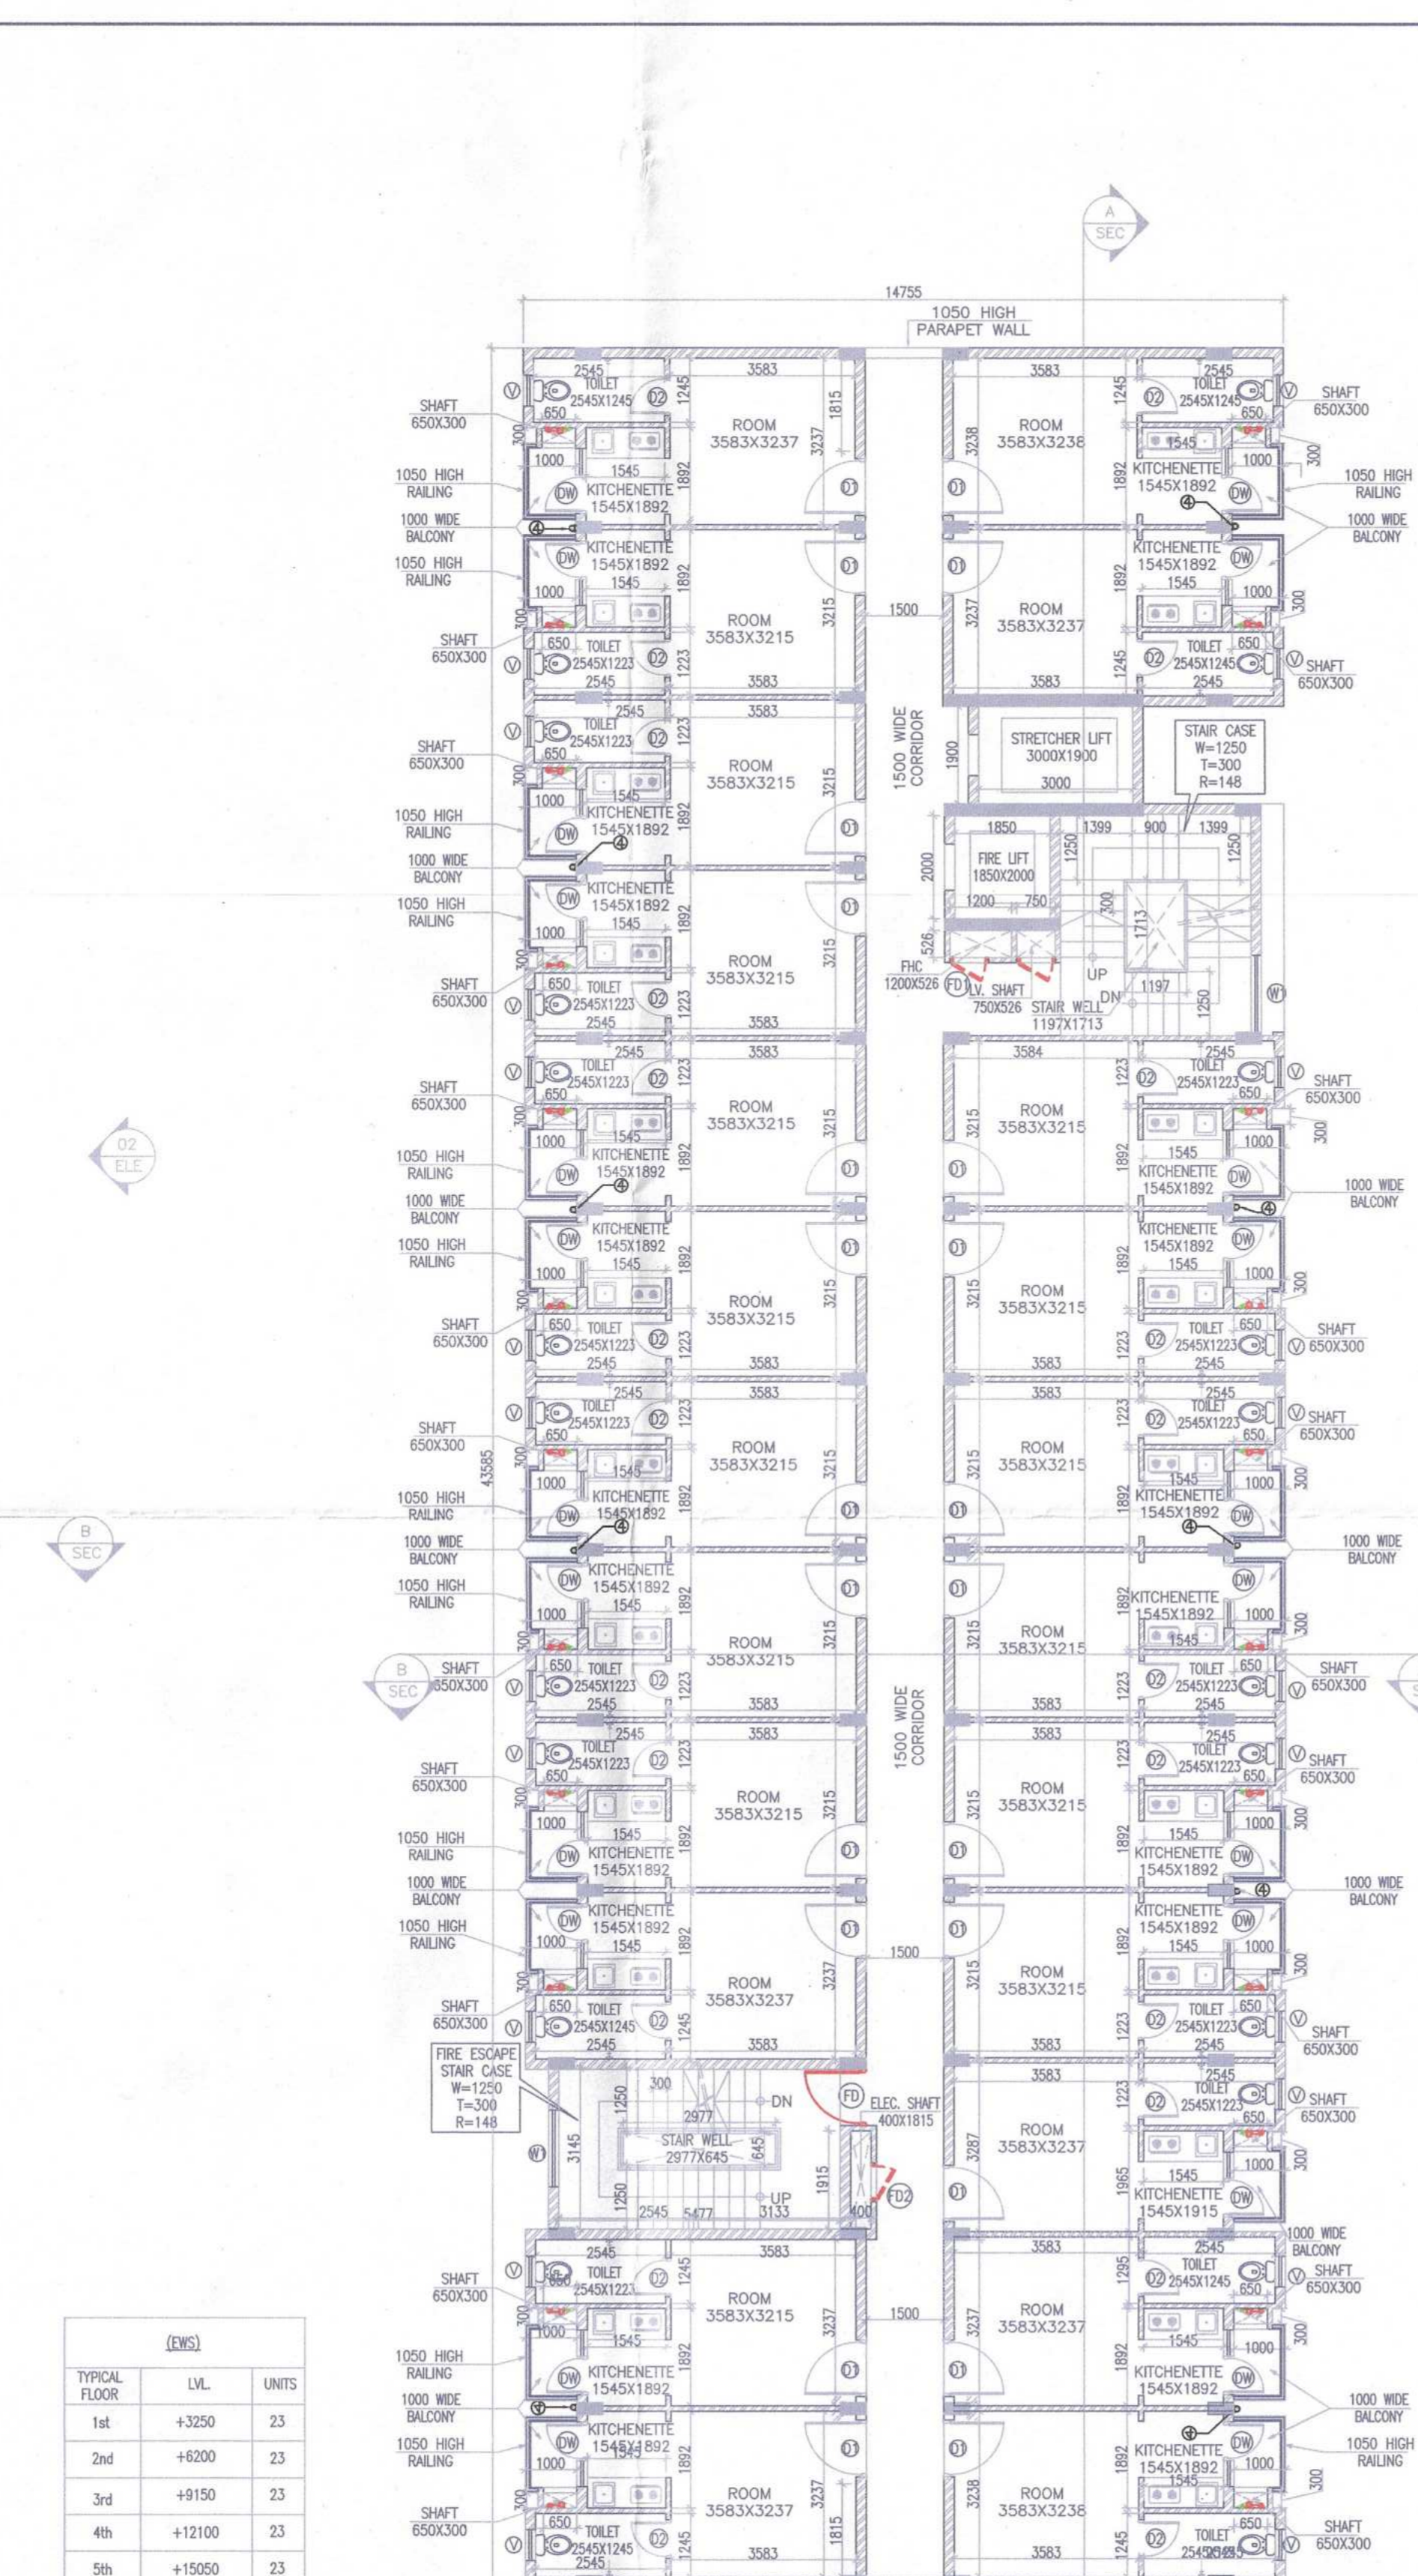

TYPICAL FLOOR PLAN
1ST TO 6TH
EWS

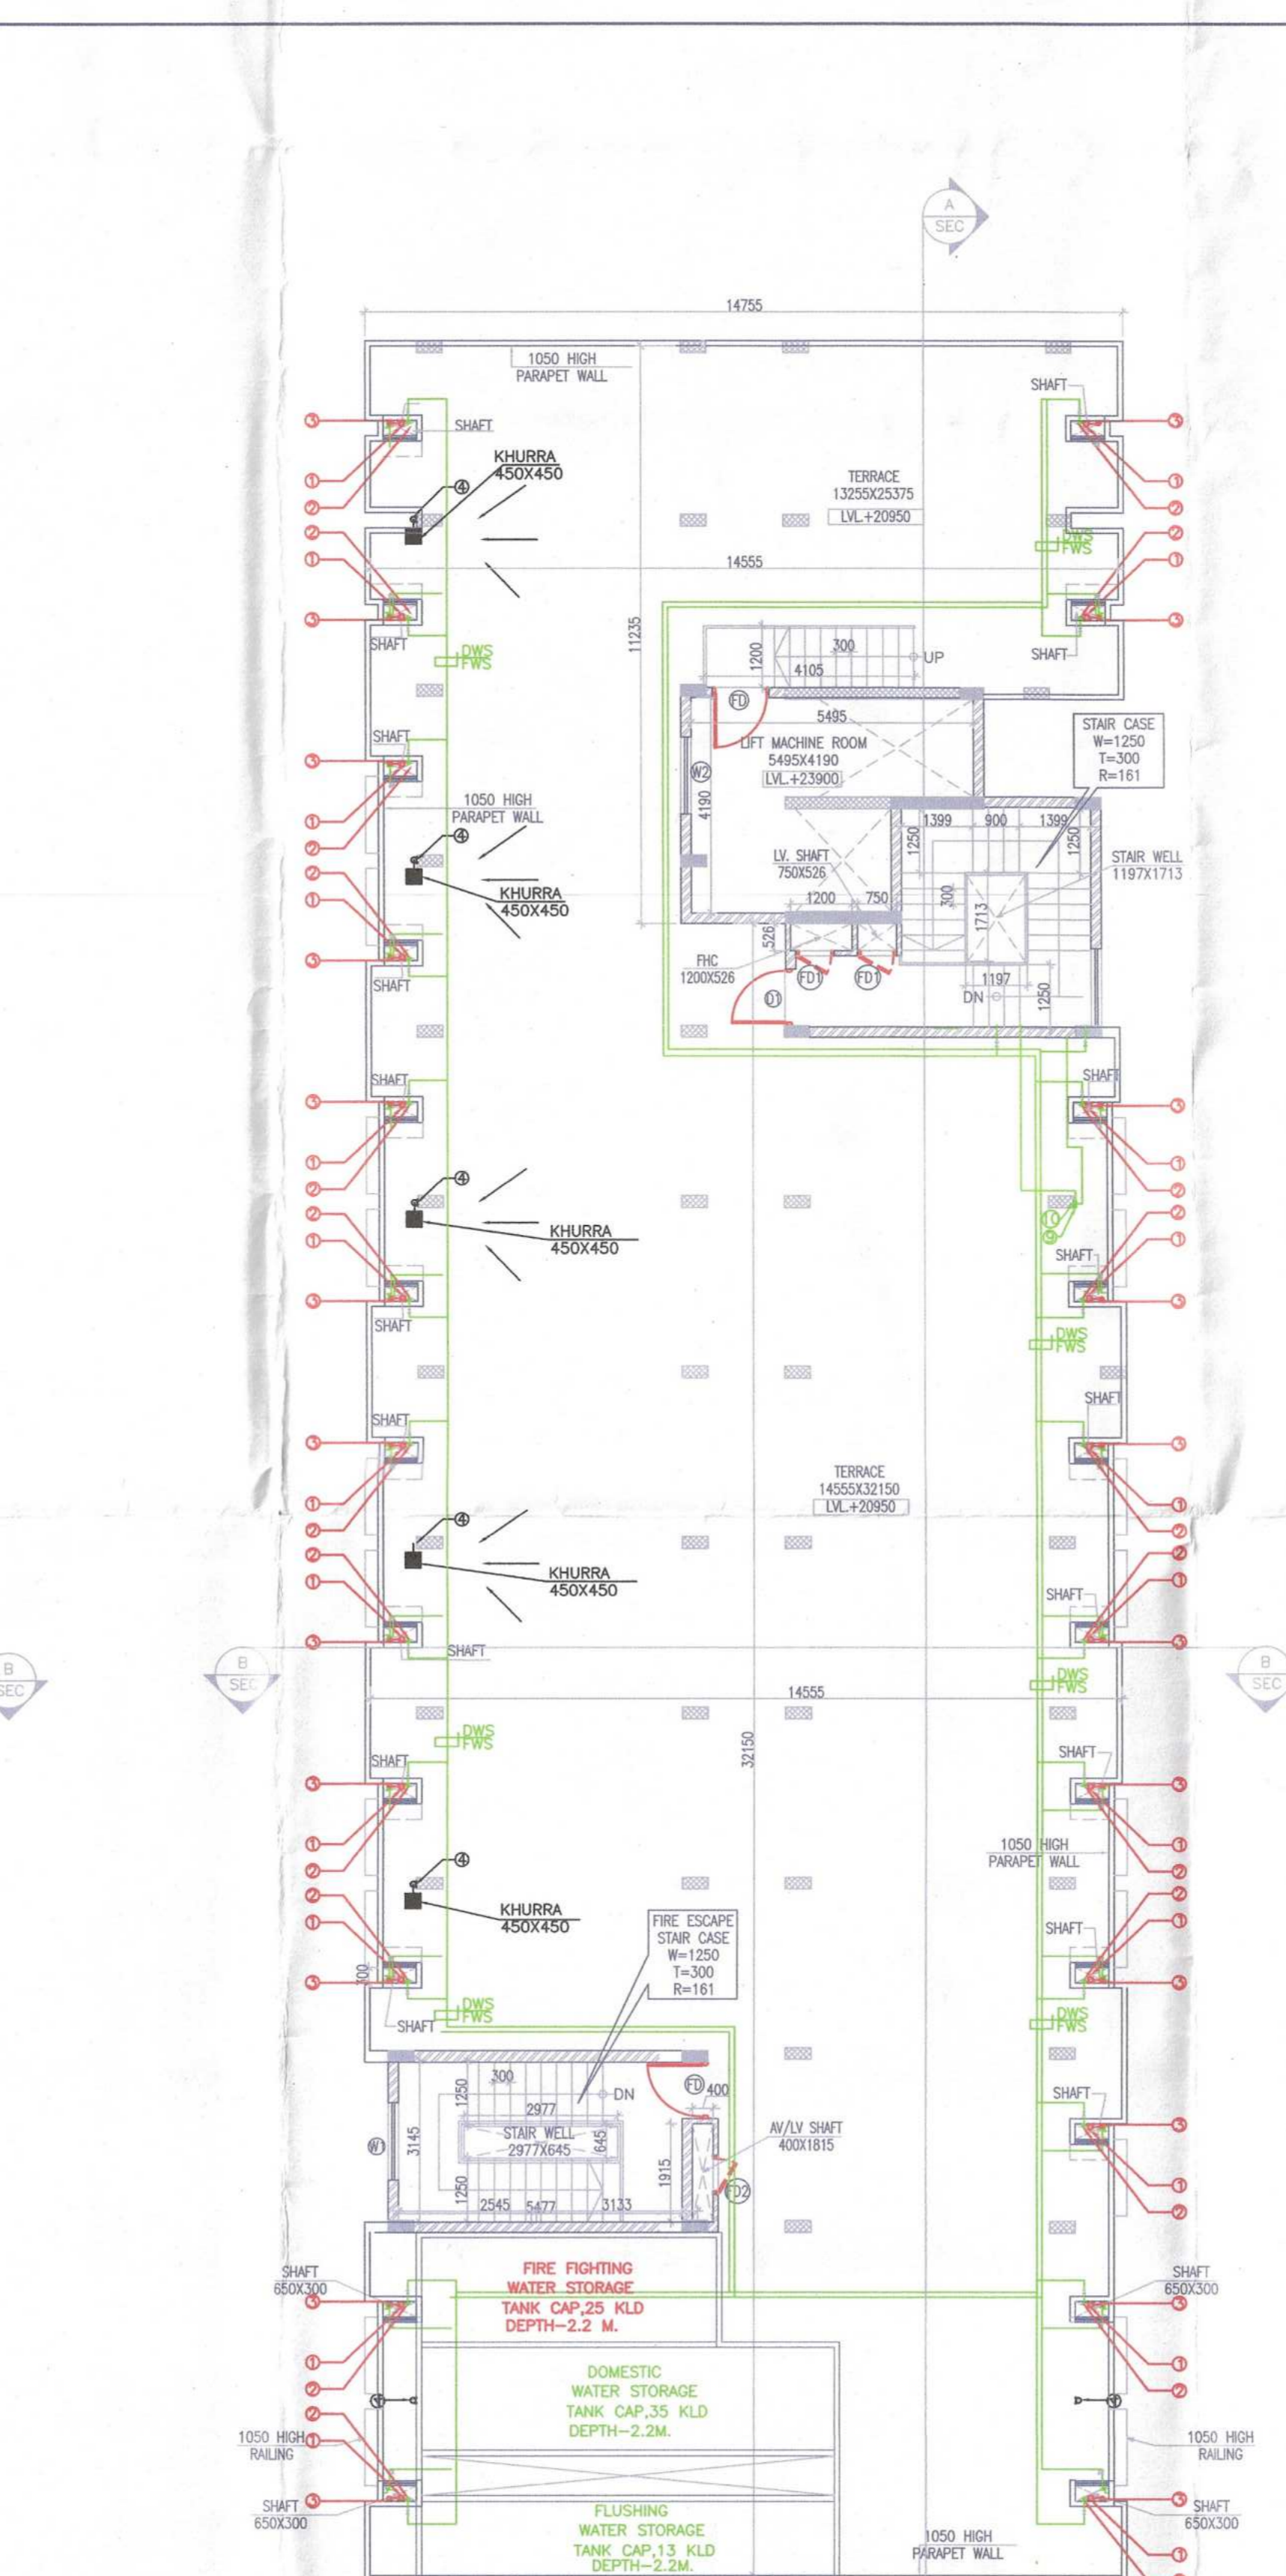

TERRACE PLAN
LVL+20900
EWS

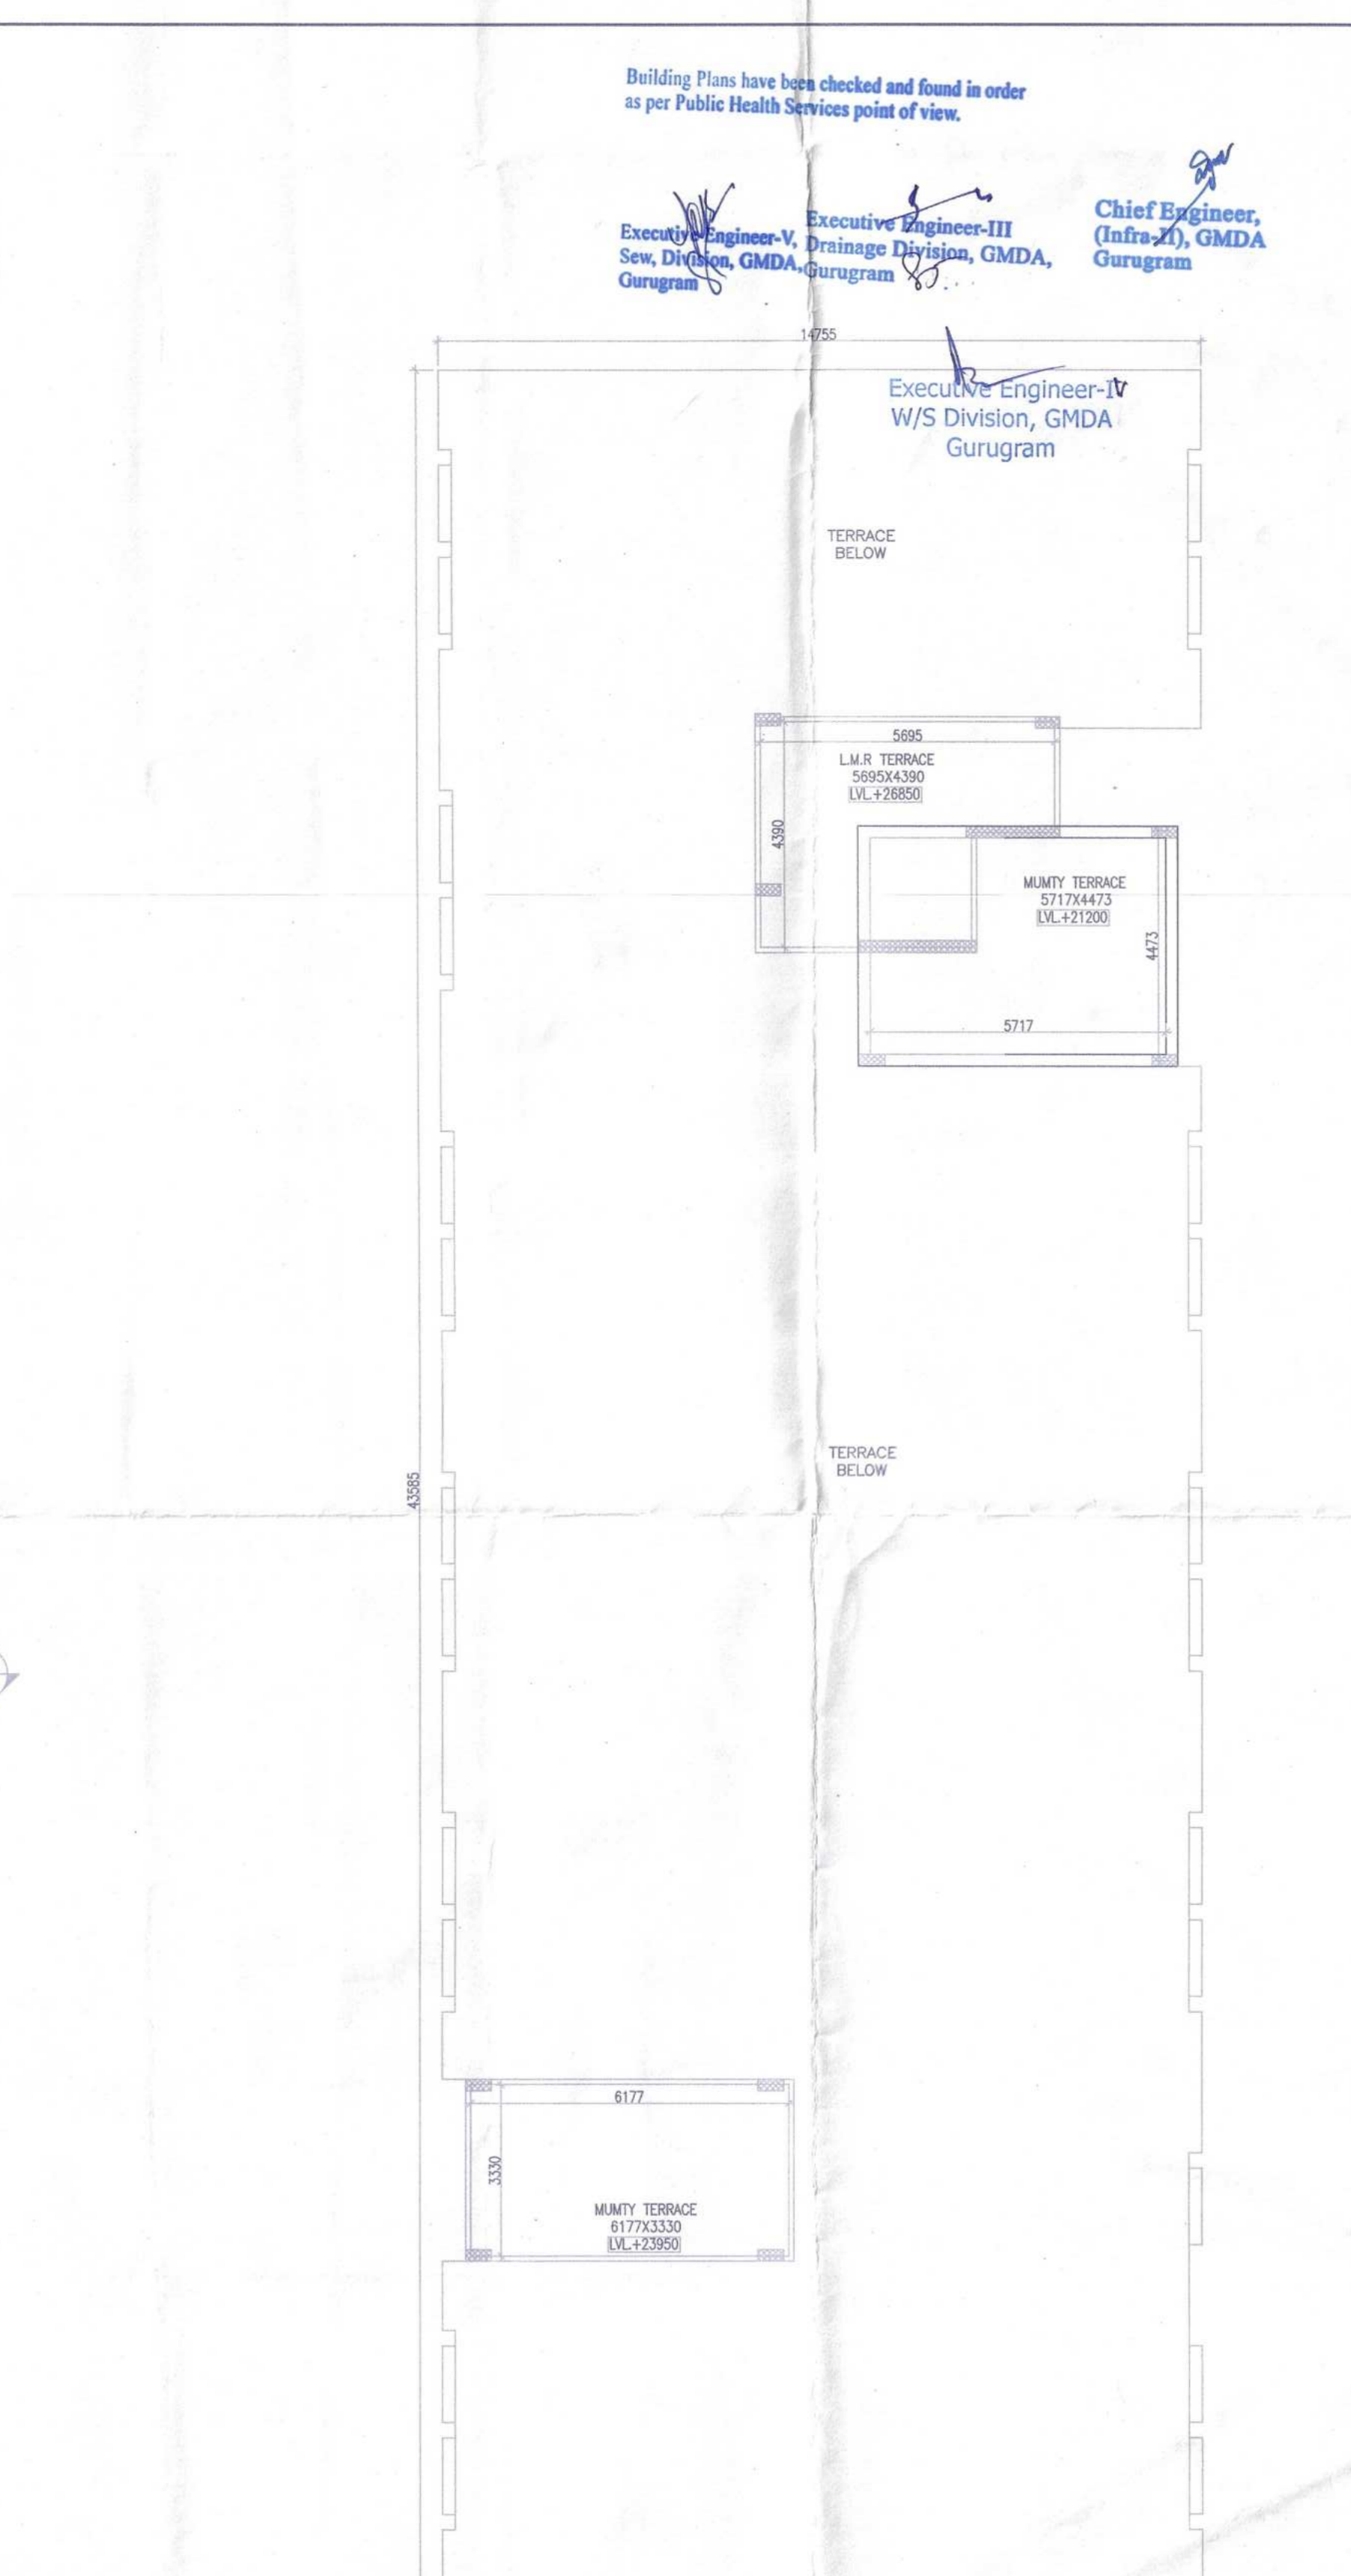

L.M.R. TERRACE
LVL+25750
EWS

SCHEDULE OF DOORS + WINDOWS



TYPE	SIZE	LOCATION	DESCRIPTION	QTY	UNIT	AMOUNT
D1	110x2100	COMMON AREA	FIRE DOOR	+100	+2100	
D2	75x2000	ROOM ENTRY	FIRE DOOR	+100	+2100	
D3	140x2000	ENT LOBBY	AL GLAZED DOOR	+100	+2100	
D4	110x2100	ROOM ENTRY	FLUSH DOOR	-	-	
D5	75x2000	TOILET	FLUSH DOOR	-	-	
D6	75x2000	DOOR	FLUSH DOOR	-	-	
D7	75x2100	KITCHENETTE	DOOR ON WINDOW	+1200	+2100	
D8	150x1200	STORAGE	AL GLAZED WINDOW	+1200	+2100	
D9	150x1200	LIFT MACHINE ROOM	AL GLAZED WINDOW	+400	+2100	
D10	102x1200	ENT LOBBY	AL GLAZED WINDOW	+400	+2100	
D11	80x600	WATERLATER	AL GLAZED WINDOW	+1000	+2100	

GROUND FLOOR AREA CALCULATION

NO.	TYPE	AREA (SQM)
1	1 X 6.377 X 3.515	= 22.415 SQM
2	1 X 6.144 X 4.008	= 24.625 SQM
3	1 X 3.400 X 1.900	= 6.460 SQM
TOTAL		= 53.500 SQM
TOTAL GROUND FLOOR FAR		= 53.500 SQM

GROUND COVERAGE (EWS)

NO.	TYPE	AREA (SQM)
11	1 X 0.250 X 6.200	= 1.550 SQM
12	1 X 0.750 X 7.000	= 5.250 SQM
13	1 X 12.750 X 34.710	= 442.726 SQM
14	7 X 0.750 X 3.545	= 18.811 SQM
15	7 X 0.250 X 2.745	= 4.804 SQM
16	1 X 0.750 X 6.300	= 4.725 SQM
17	1 X 0.250 X 5.000	= 1.250 SQM
18	1 X 11.023 X 1.900	= 20.944 SQM
19	1 X 12.750 X 6.875	= 88.366 SQM
20	5 X 0.750 X 1.945	= 7.294 SQM
21	5 X 0.250 X 1.545	= 1.931 SQM
22	1 X 0.250 X 1.495	= 0.374 SQM
23	1 X 0.750 X 1.885	= 1.421 SQM
TOTAL		= 606.106 SQM
TOTAL GROUND COVERAGE (EWS)		= 606.106 SQM

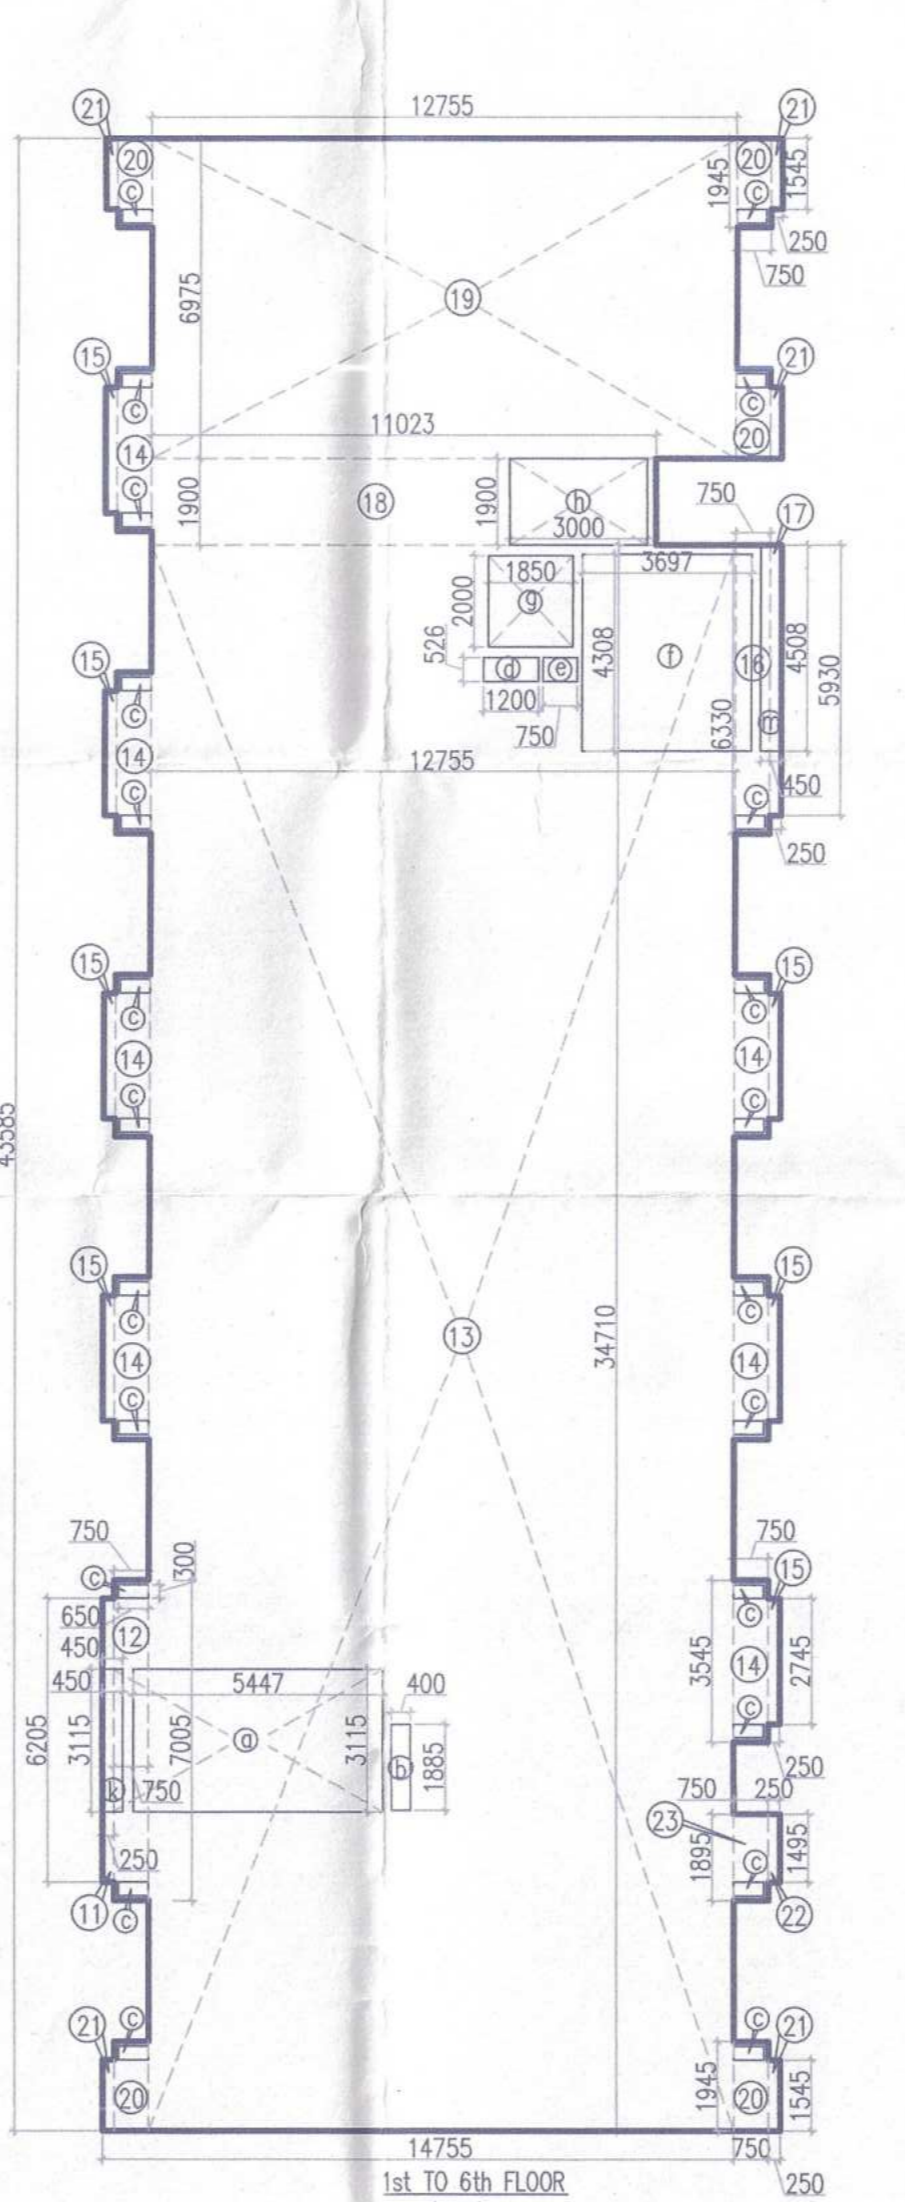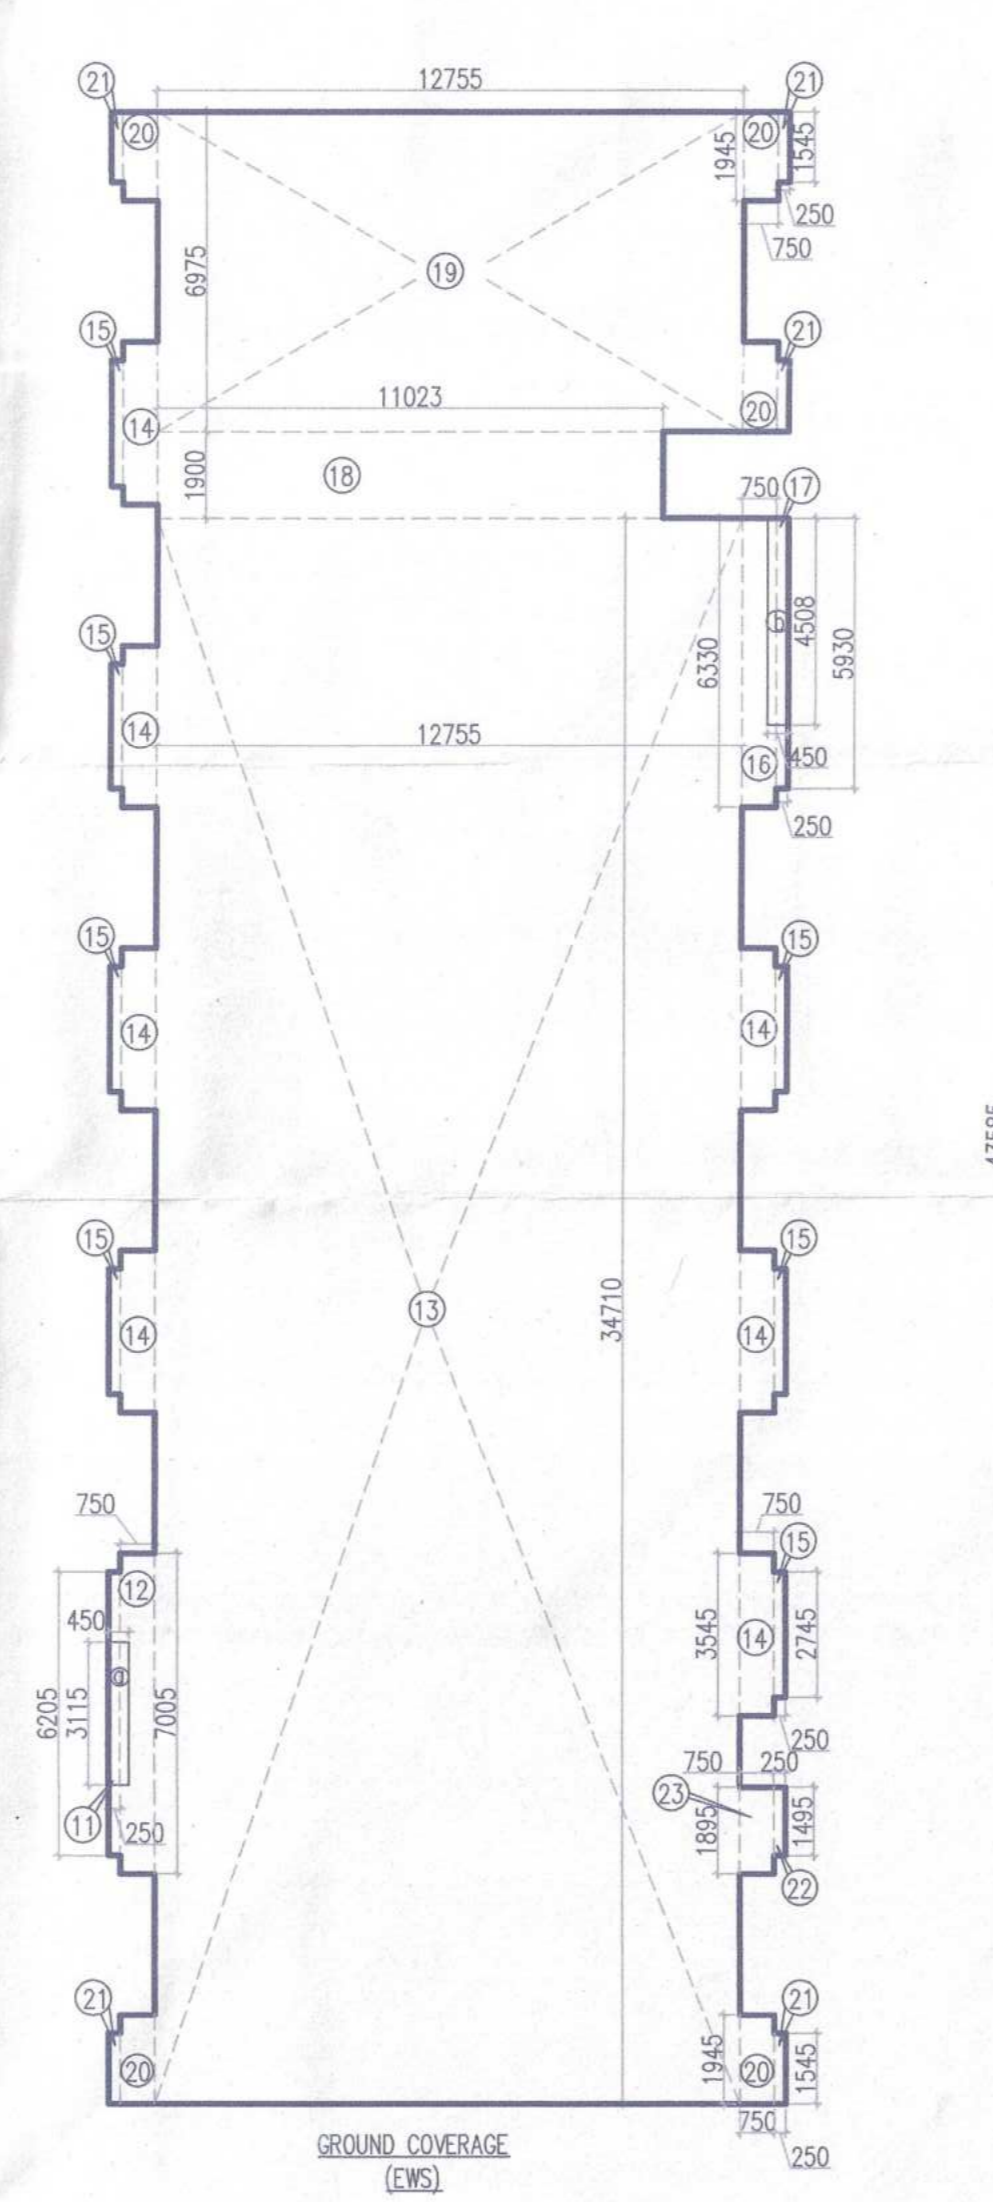


- LEGENDA:-
- UPVC SOIL & VENT PIPE
 - UPVC WASTE & UTILITY BALCONY PIPE
 - VENT PIPE
 - UPVC R.W.P. FROM TERRACE
 - DOMESTIC WATER DOWN TAKE SUPPLY PIPE FOR (14th TO 15th FLOOR)
 - DOMESTIC WATER DOWN TAKE SUPPLY PIPE (10th TO GROUND FLOOR)
 - FLOODING WATER DOWN TAKE PIPE
 - DOMESTIC WATER DOWN TAKE SUPPLY PIPE FOR (14th TO 15th FLOOR)
 - DOMESTIC WATER DOWN TAKE SUPPLY PIPE (10th TO GROUND FLOOR)
 - SOLAR WATER DOWN TAKE PIPE
 - FLOODING WATER DOWN TAKE PIPE
 - DOMESTIC WATER SOIL PIPE
 - FLOOR TRAP (100x100/100mm)
 - FLOOR DRAIN (100x75mm)
 - DRAIN POINT (100x75mm)
 - CLEAN OUT FLOOR
 - MANHOLE TRAP
 - WASTE PIPE LINE
 - SOIL PIPE LINE

TYPICAL FLOOR AREA (1st TO 6th FLOOR)

NO.	TYPE	AREA (SQM)
11	1 X 10.250 X 6.200	= 63.562 SQM
12	1 X 10.750 X 7.000	= 75.250 SQM
13	1 X 12.750 X 34.710	= 442.726 SQM
14	7 X 0.750 X 3.545	= 18.811 SQM
15	7 X 0.250 X 2.745	= 4.804 SQM
16	1 X 0.750 X 6.300	= 4.725 SQM
17	1 X 0.250 X 5.000	= 1.250 SQM
18	1 X 11.023 X 1.900	= 20.944 SQM
19	1 X 12.750 X 6.875	= 88.366 SQM
20	5 X 0.750 X 1.945	= 7.294 SQM
21	5 X 0.250 X 1.545	= 1.931 SQM
22	1 X 0.250 X 1.495	= 0.374 SQM
23	1 X 0.750 X 1.885	= 1.421 SQM
TOTAL		= 606.106 SQM

MURTY MACHINE ROOM AREA CALCULATION

NO.	TYPE	AREA (SQM)
1	1 X 5.896 X 4.480	= 26.406 SQM
2	1 X 2.210 X 10.860	= 23.980 SQM
3	1 X 3.395 X 3.845	= 13.050 SQM
4	1 X 6.377 X 3.545	= 22.600 SQM
TOTAL		= 66.036 SQM

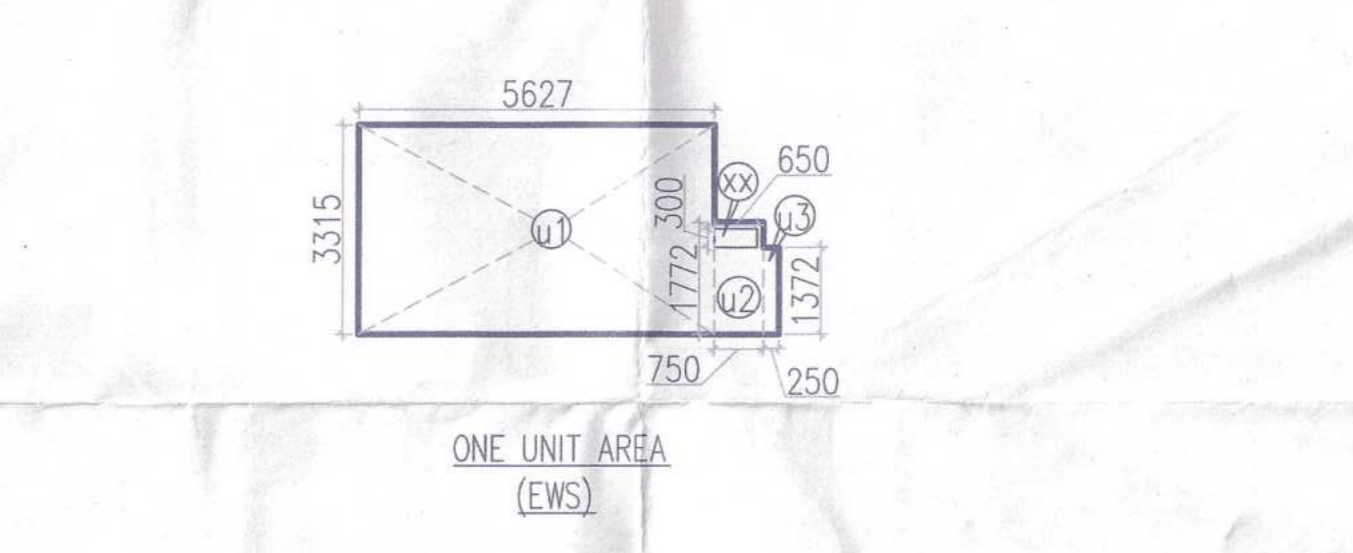

ONE UNIT AREA (EWS)

NO.	TYPE	AREA (SQM)
u1	1 X 5.627 X 3.315	= 18.654 SQM
u2	1 X 0.750 X 1.772	= 1.329 SQM
u3	1 X 0.250 X 1.372	= 0.343 SQM
TOTAL		= 20.326 SQM
GROSS - A		= 20.326 SQM
GROSS - B		= 0.195 SQM
TOTAL AREA OF ONE UNIT (EWS)		= 20.521 SQM

PROJECT:

PROPOSED BUILDING PLAN OF GROUP HOUSING COLONY MEASURING 24.10 ACRES (LICENCE NO 80 OF 2012 DATED 17/08/2012) IN SECTOR 106, CURUGRAM MANESAR URBAN COMPLEX BEING DEVELOPED BY ARMD DEVELOPERS LTD. & OTHERS.

OWNER'S SEAL & SIGNATURE

ARCHITECT'S SEAL & SIGNATURE

ANMASHI CHANDRA VAIDYA
Architect No. CA/7502005
H. No. 163, Pti-II
New Palam Vihar, Gurugram

AUG.-2022. Scale : 1:100


Drawing Title:- GROUND FLOOR TO TERRACE & AREA CALCULATION. Drawing No:- D-01




ELEVATION-03




ELEVATION-04

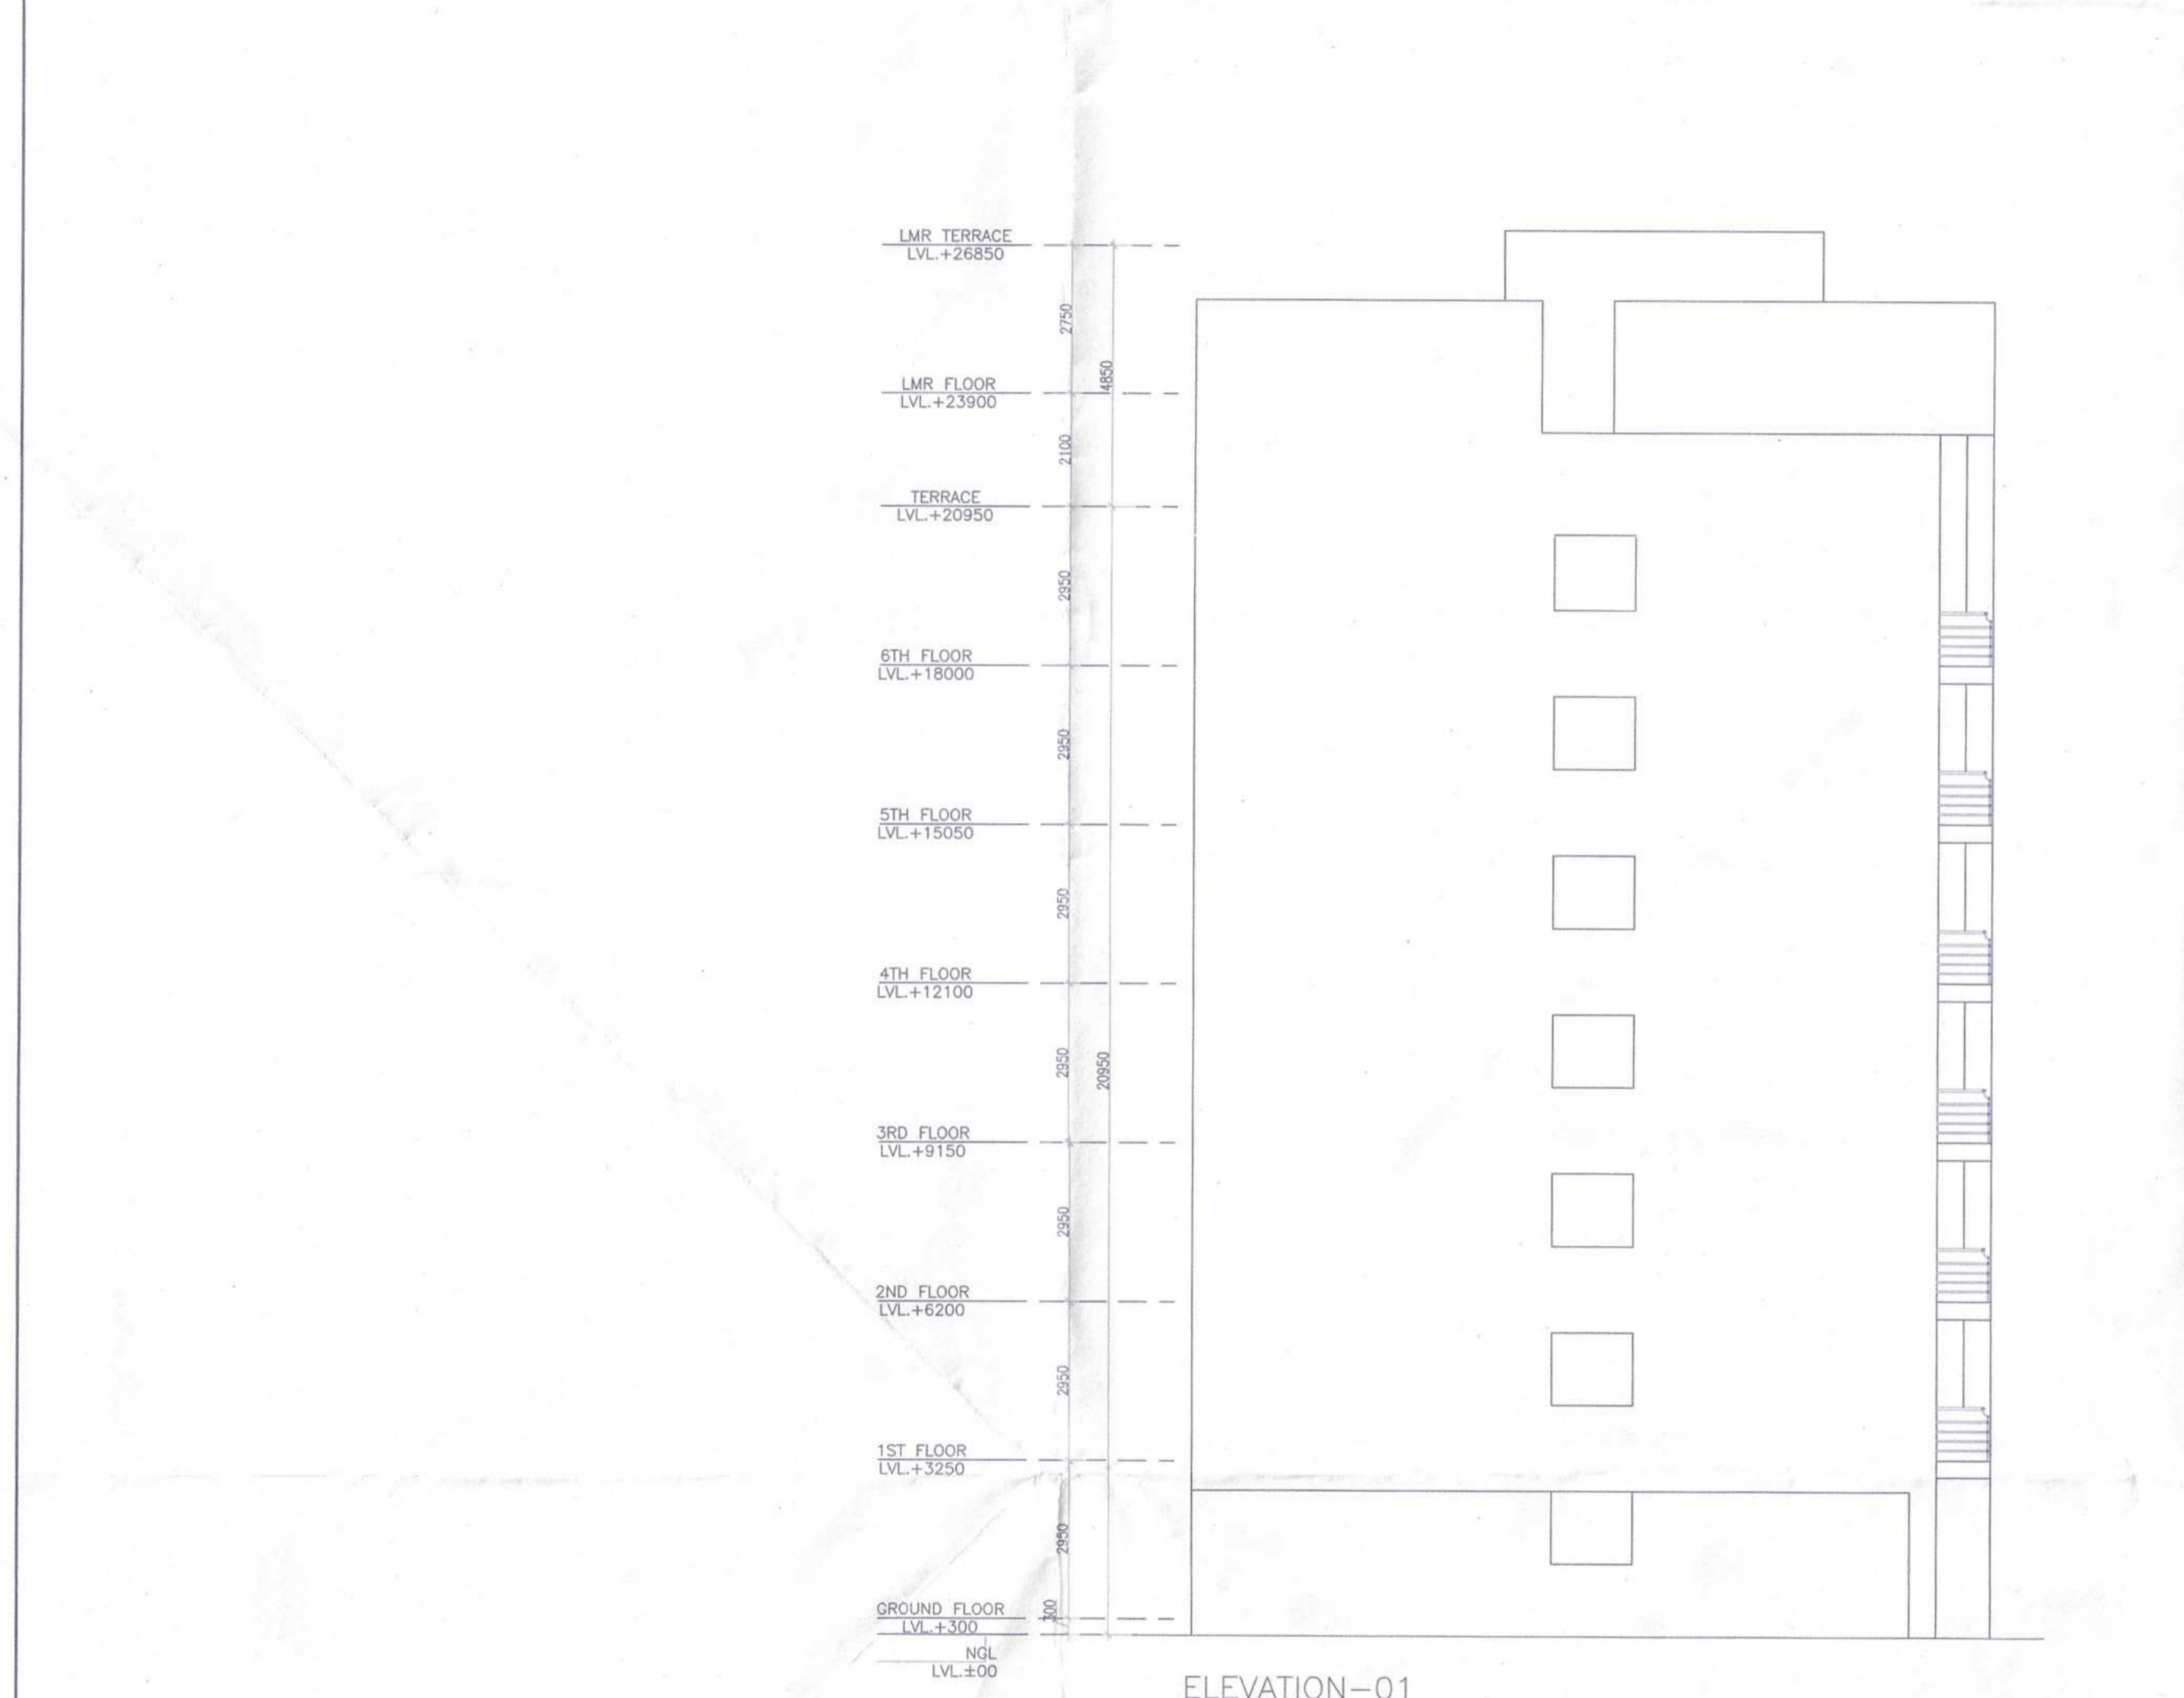

ELEVATION-01

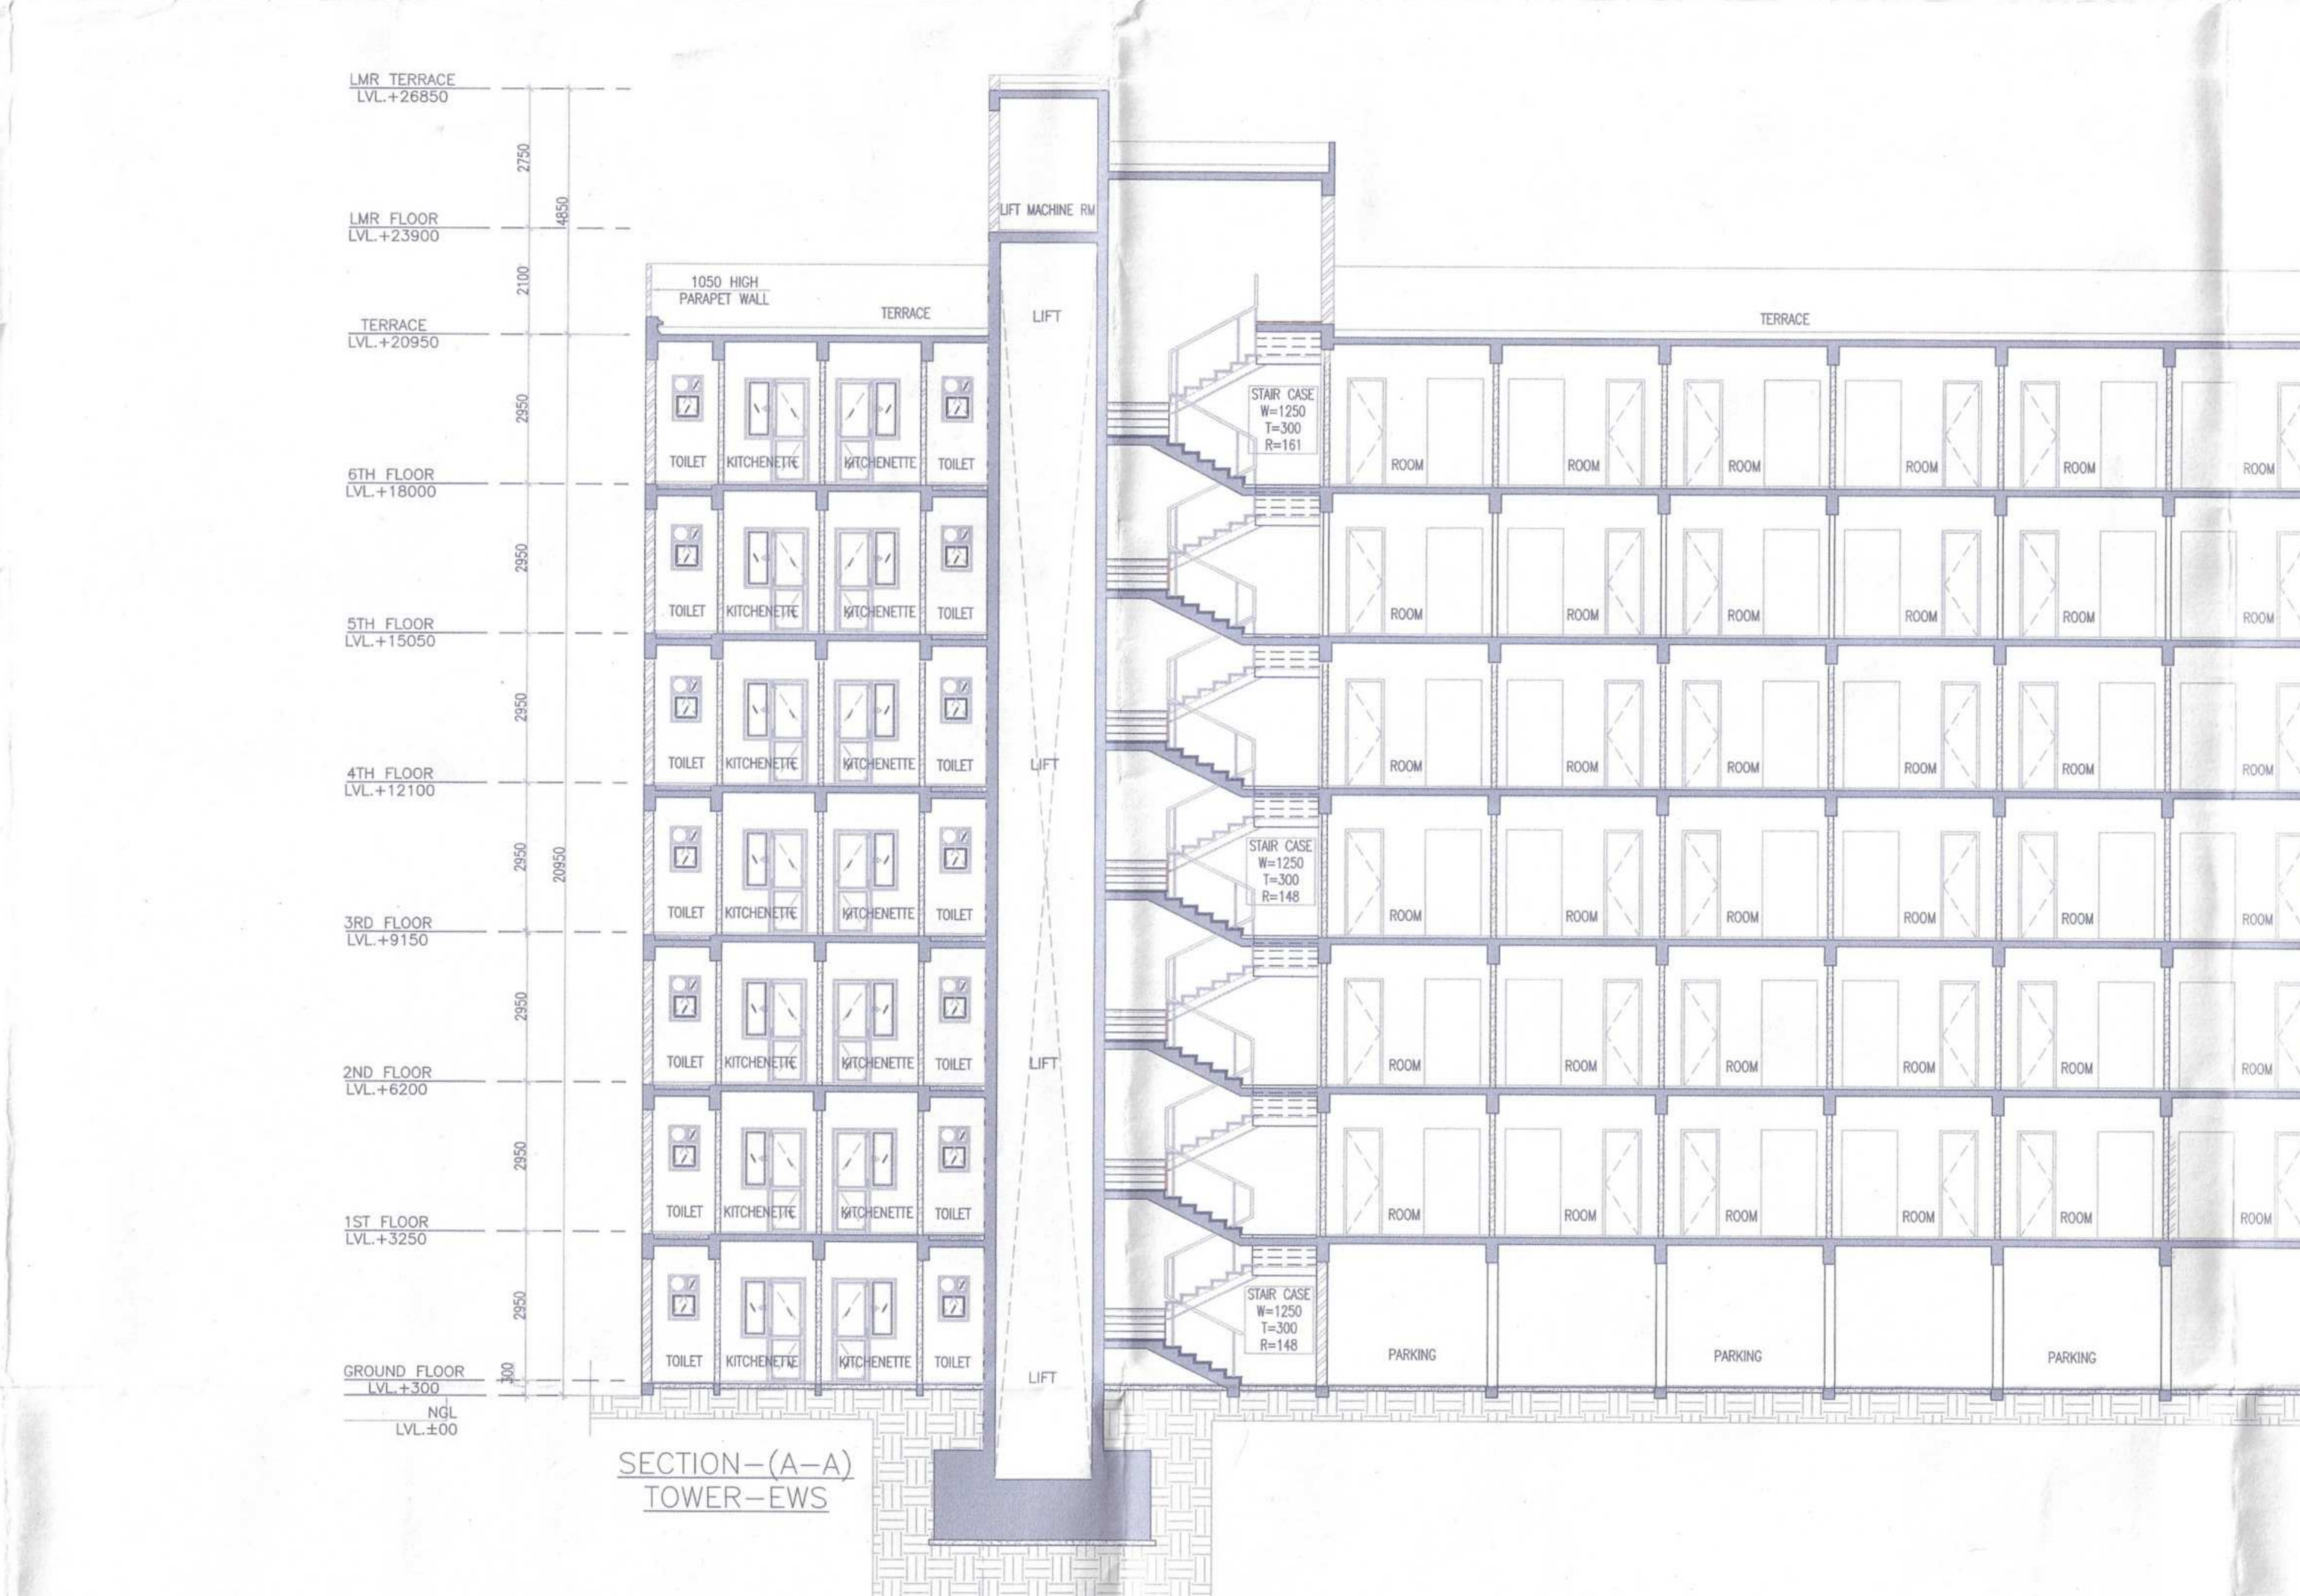

SECTION (A-A)
TOWER-EWS

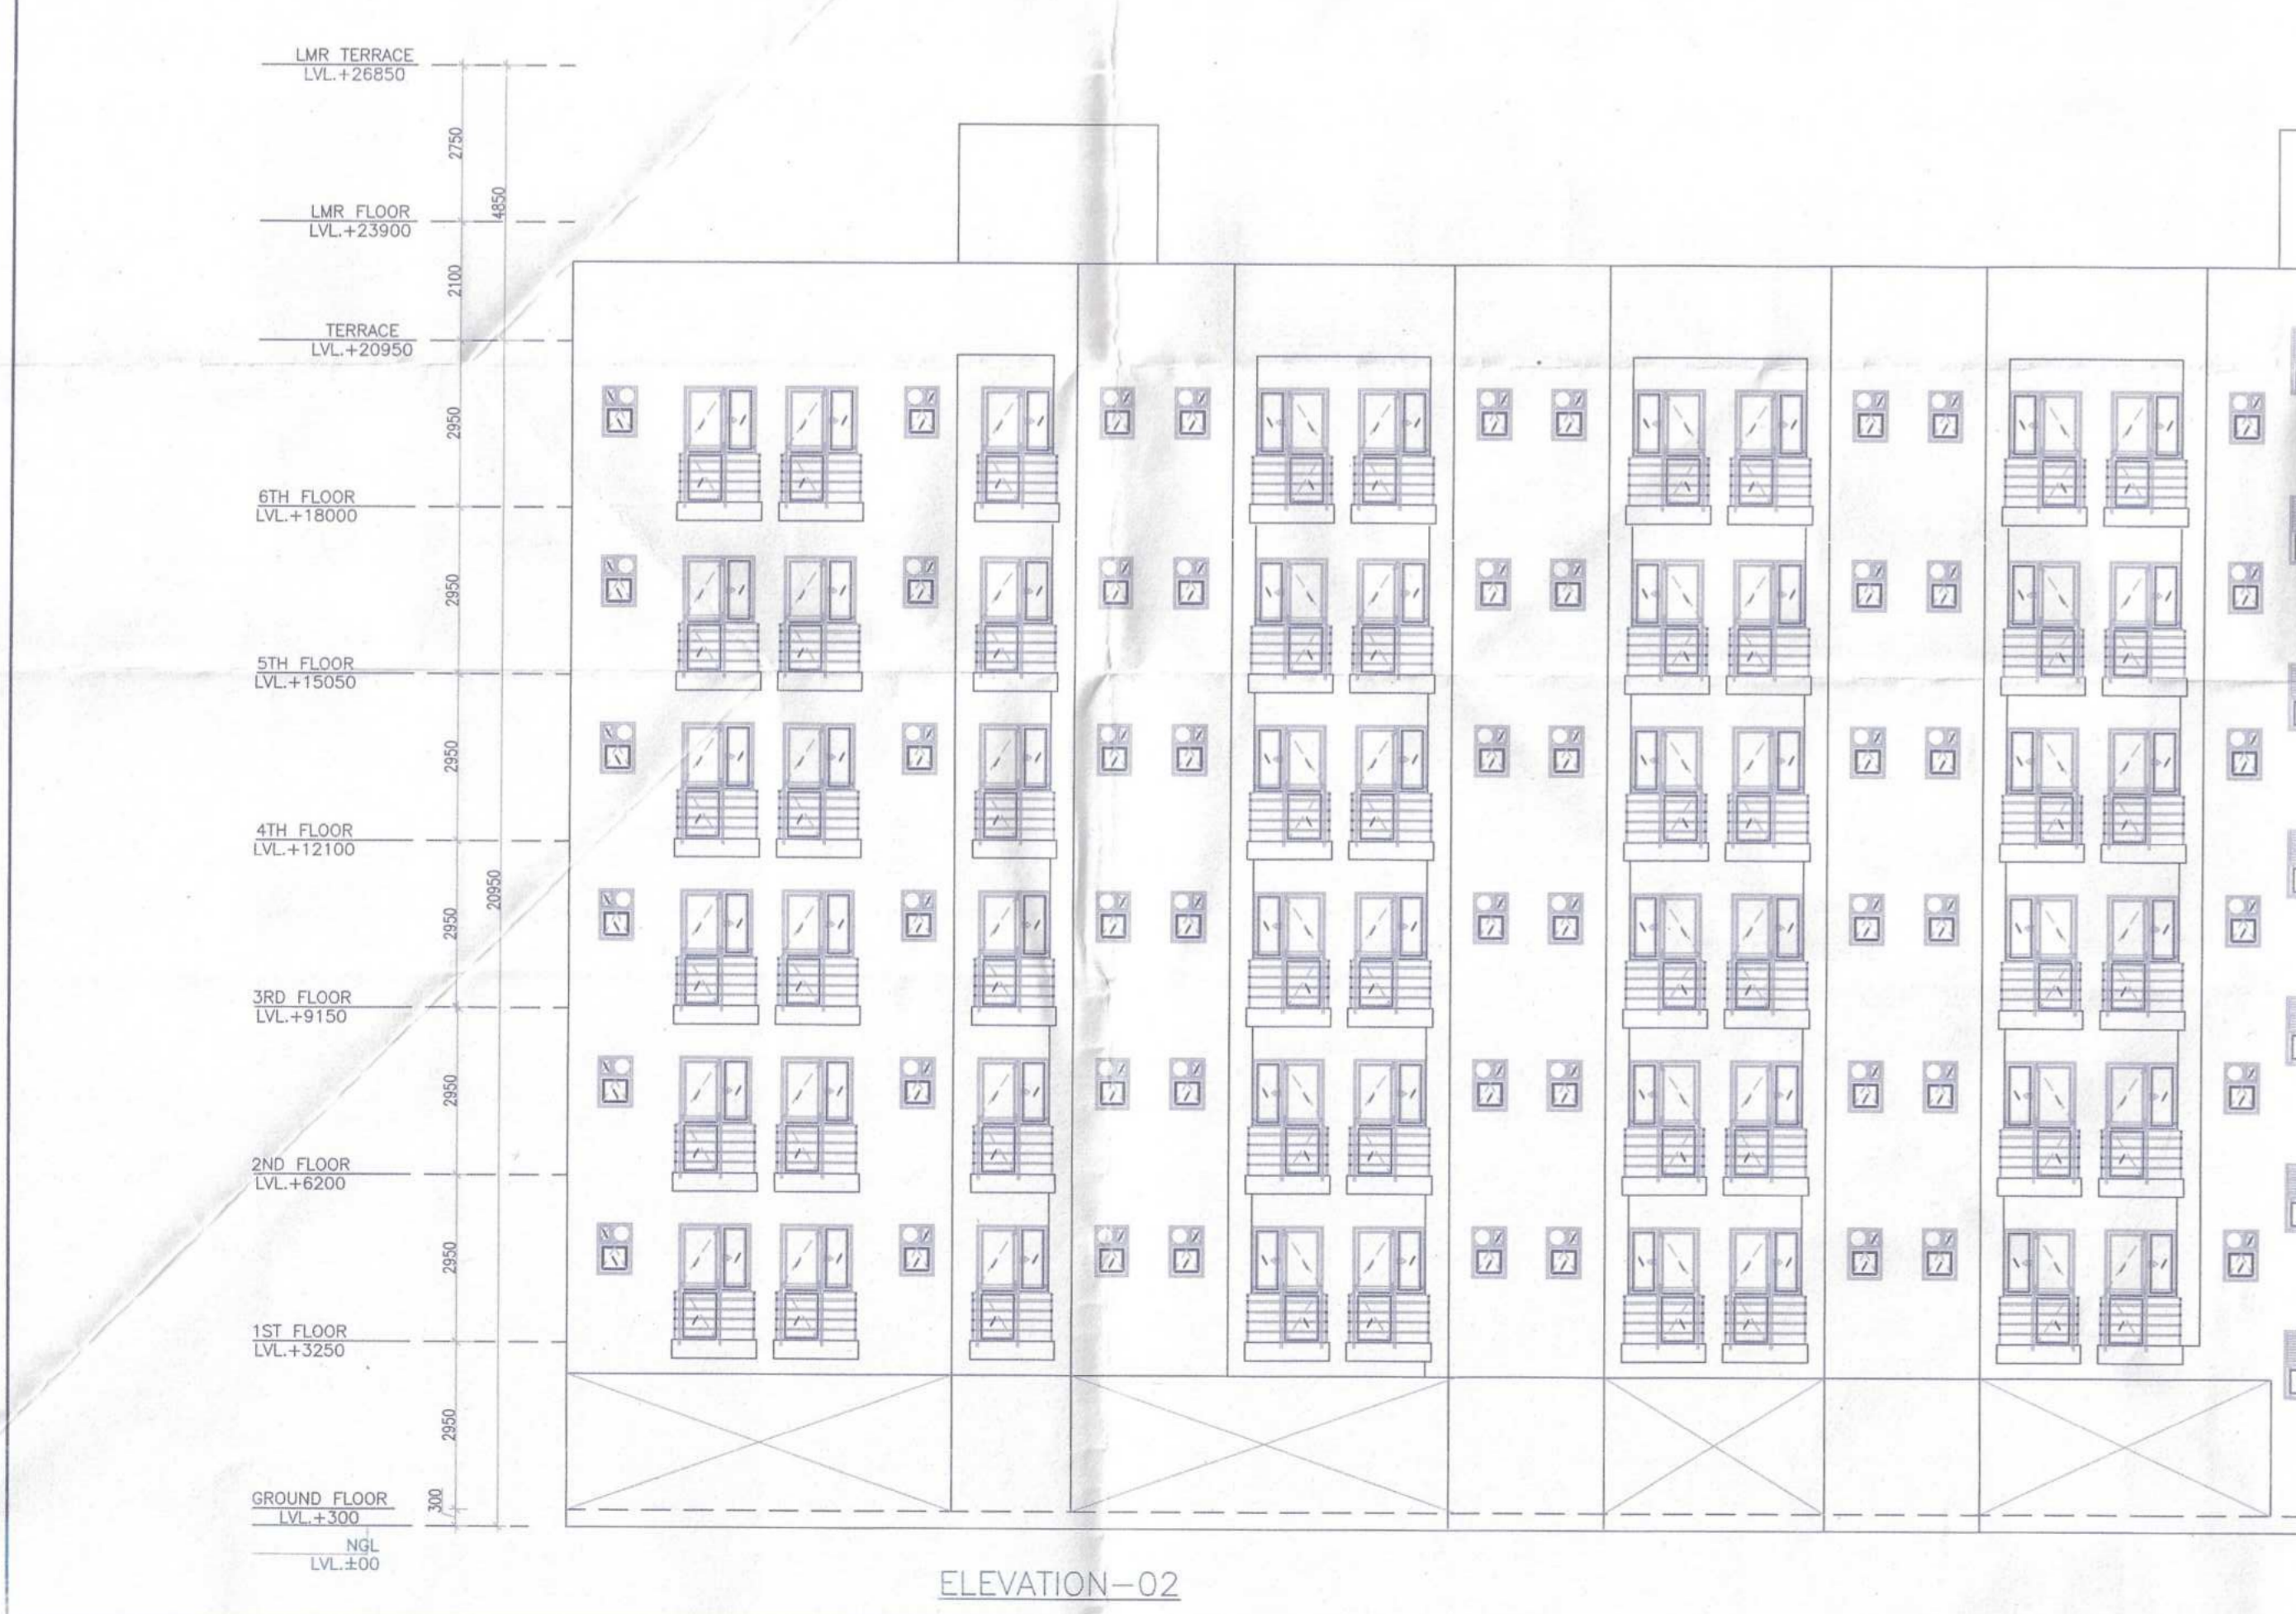

ELEVATION-02



SECTION (B-B)
TOWER-EWS

Note :-
1. BUILDING HAS AUTOMATIC SPRINKLER SYSTEM WHEREVER REQUIRED BY NBC.
2. BUILDING WILL BE DESIGNED (STRUCTURES) AS PER RELEVANT IS CODES FOR EARTH QUAKE RESISTANCE.

ATP (H) STP (H) STP (H)
Member BPAC Member BPAC Member BPAC
SANCTIONED TO BE READ WITH THIS OFFICE MEMO NO. : DATED :
DINESH KUMAR PAI(H)

PROJECT:
PROPOSED BUILDING PLAN OF GROUP HOUSING COLONY MEASURING 24.10 ACRES (LICENCE NO 80 OF 2012 DATED 17/08/2012) IN SECTOR 106, CURUGRAM MANESAR URBAN COMPLEX BEING DEVELOPED BY AIRMID DEVELOPERS LTD. & OTHERS.

OWNER'S SEAL & SIGNATURE



Airmid Developers Limited
Authorised Signatory

ARCHITECT'S SEAL & SIGNATURE

AVIMASH CHANDRA VAIDYA
Architect No. CA/75/20206
Rt. No. 163, P/14
New Palam Vihar, Gurugram

AUG-2022. Scale : 1:100
Drawing Title: EWS SECTION-A-A, B-B

D-02

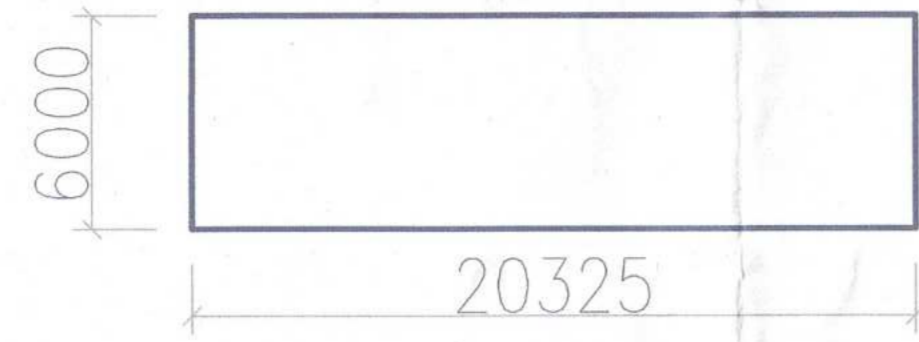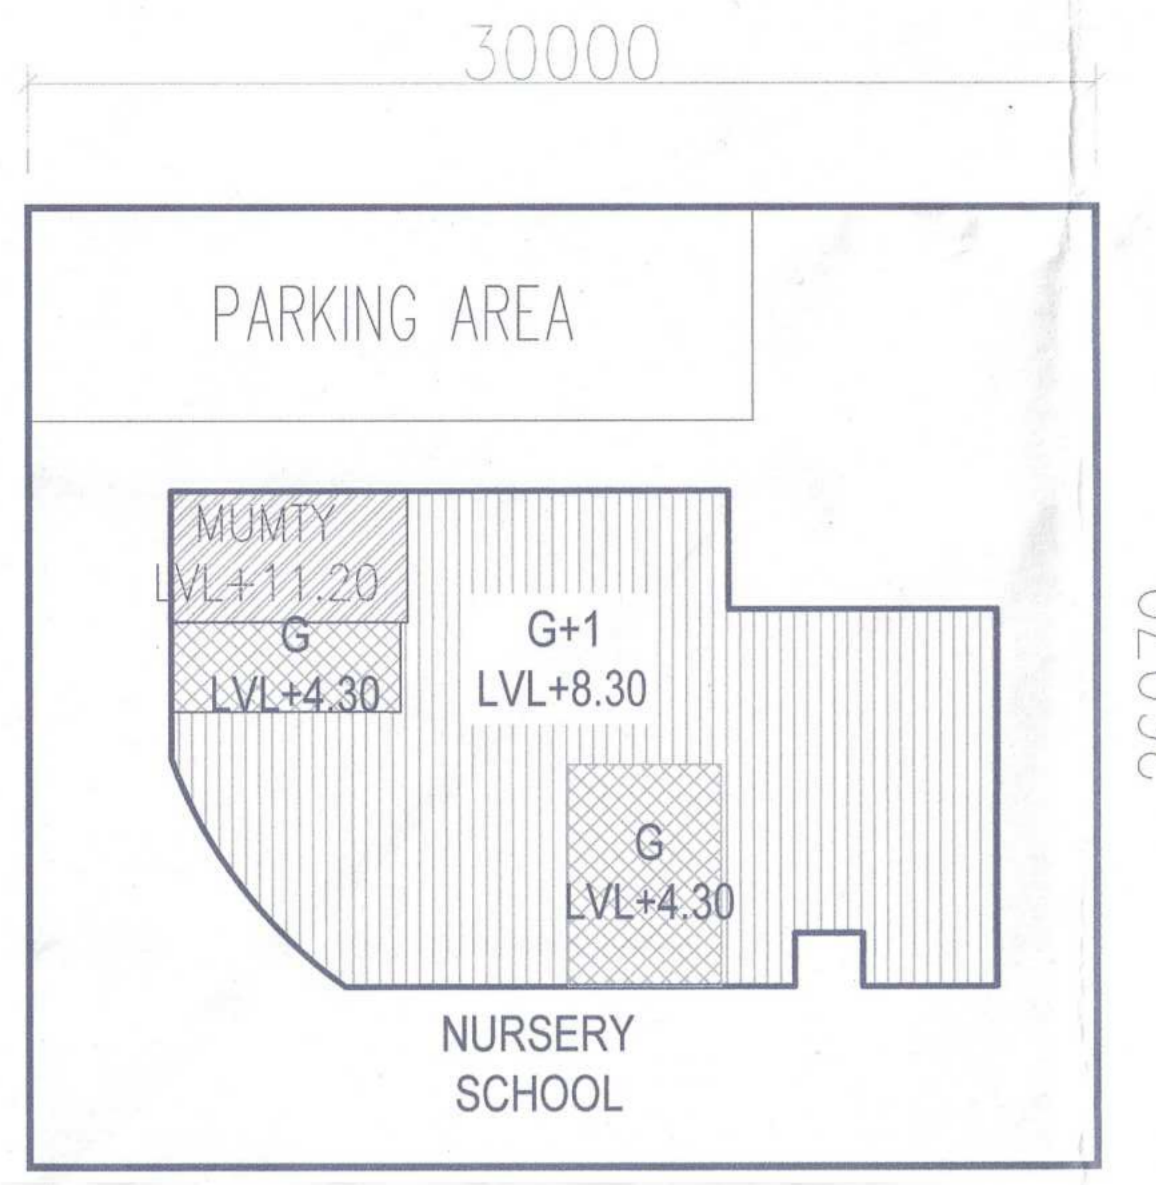

PARKING AREA
1.- 20.325 X 6.000 = 121.95 SQM.

SCALE-1:300

SITE AREA
1.- 30.000 X 26.979 = 809.37 SQM.

SCALE-1:300


NS-1

NURSERY SCHOOL PLOTS AREA (0.2 ACRES) = 809.37 SQM.
PERMISSIBLE F.A.R. @ 150% = 1214.055 SQM.
PROPOSED F.A.R. = 494.945 SQM. OR 494.945 X 100 = 61.15%
809.37

PERMISSIBLE GROUND COVERAGE @ 35% = 283.279 SQM.
PROPOSED GROUND COVERAGE = 282.781 SQM. OR 246.971 X 100 = 34.938%
809.37

PERMISSIBLE PARKING AREA @ 15% OF SITE AREA = 121.41 SQM.
PROPOSED PARKING AREA = 121.95 SQM.

FLOORS	NO. OF TYPICAL FLOORS	TOTAL FAR AREA OF ONE TOWER/BLOCK	GROUND COVERAGE OF TOWER
GROUND FLOOR	1	282.781	282.781
1st. FLOOR	1	212.164	
		494.945	282.781

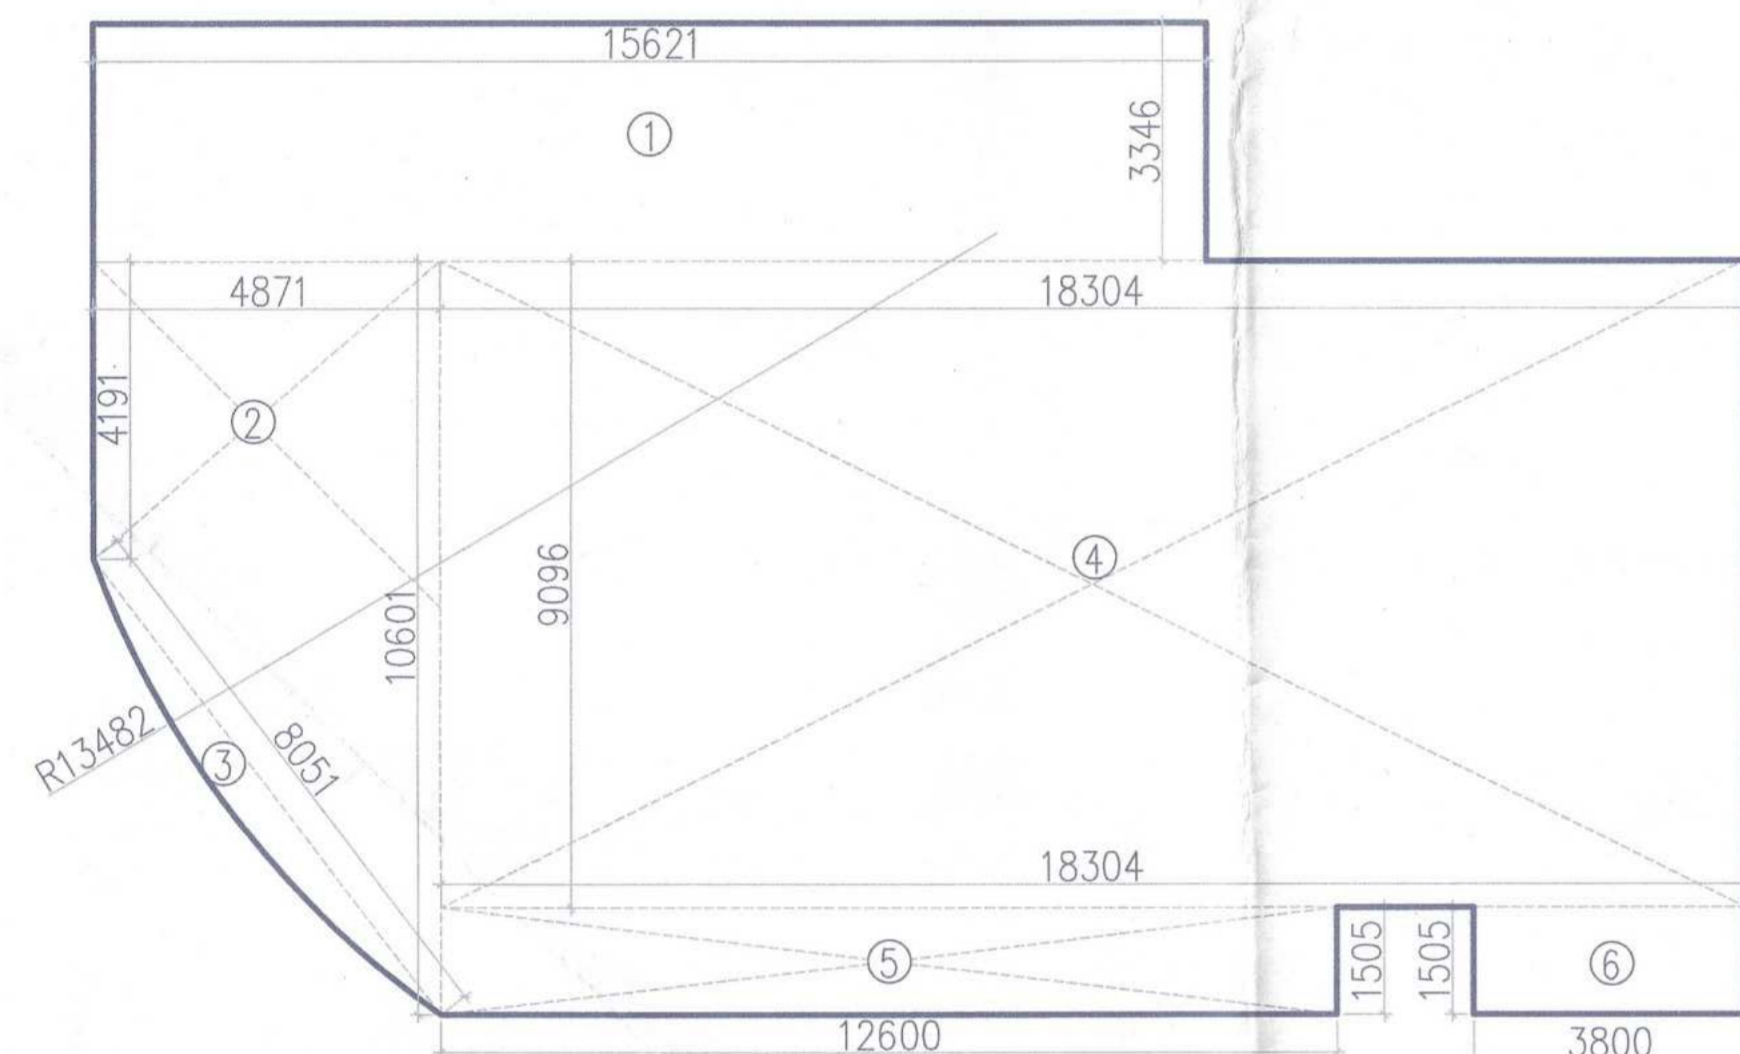

GROUND FLOOR/GROUND COVERAGE

NURSERY SCHOOL						
GROSS - A						
1	=	1	X	15.621	X	3.346
2	=	0.5	X	(4.191+10.601)	X	4.871
4	=	1	X	18.304	X	9.096
5	=	1	X	12.800	X	1.505
4	=	1	X	3.800	X	1.505
						TOTAL = 279.469 SQM
TOTAL FAR & GROUND COVERAGE OF NURSERY SCHOOL						GROSS - A + GROSS - B = 279.469 + 3.312 = 282.781 SQM


LEGENDS:

- UPVC R/W.P. FROM TERRACE
- DOMESTIC WATER DOWN SILE SUPPLY PIPE
- FLUSHING WATER DOWN TAKE PIPE
- FLUSHING WATER RISER PIPE
- DOMESTIC WATER RISER PIPE
- FLOOR TRAP (1000/100mm)
- FLOOR DRAIN (100/75mm)
- WASTE PIPE LINE
- SOIL PIPE LINE
- DOMESTIC WATER SUPPLY
- FLUSHING WATER SUPPLY

SCHEDULE OF DOORS + WINDOWS
SCHEDULE OF OPENINGS (NURSERY SCHOOL)

TYPE	SIZE	LOCATION	DESCRIPTION	SILL	LINTEL
D2	1500x2100	LOBBY	FLUSH DOOR	-	+2150
D2a	1500x2100	CLASSROOM ENTRY	FLUSH DOOR	-	+2150
D3	1000x2100	BOYS/GIRLS/DIS TOI	FLUSH DOOR	-	+2150
D4	950x2100	CLASSROOM ENTRY	FLUSH DOOR	-	+2150
D5	750x2100	TOILET ENTRY	FLUSH DOOR	-	+2150
D6	750x2100	W.C. CUBICLES	FLUSH DOOR	-	+2150
ED	3800x2100	LOBBY	PS FRAME WITH GLASS	+900	+2150
W1	1200x2150	CLASSROOM	PS FRAME WITH GLASS	+900	+3050
W2	750x2150	PRINCIPAL'S/STAFF RM	PS FRAME WITH GLASS	+900	+3050
W3	4000x2150	CLASSROOM	PS FRAME WITH GLASS	+900	+3050
W4	4250x900	MULTI-PURPOSE HALL	PS FRAME WITH GLASS	+2150	+3050
V	1200x600	GIRLS/BOYS TOILET	LOUVRES OF APPROVED	+2450	+3050
V1	600x600	GIRLS/BOYS TOILET	FROSTED GLASS	+2450	+3050

LEVELS WRT FFL

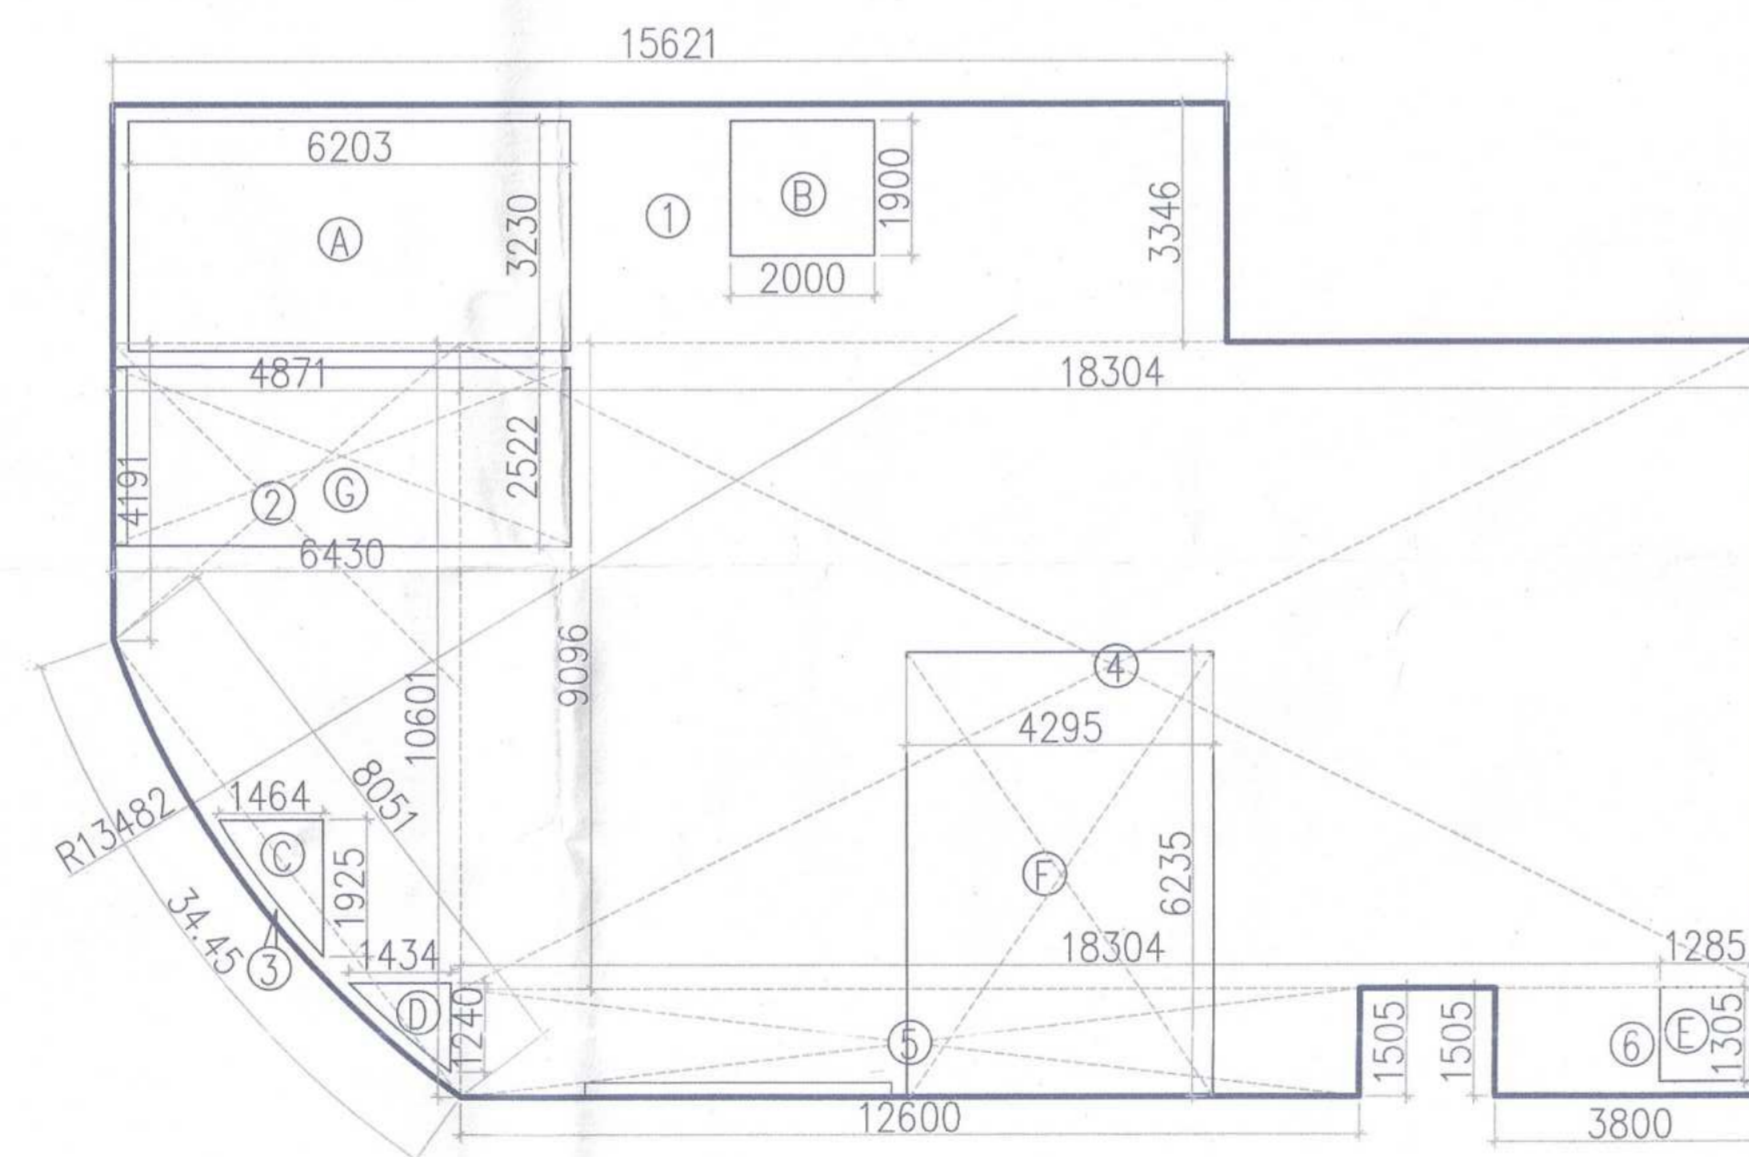


1ST FLOOR AREA


NURSERY SCHOOL						
GROSS - A						
1	=	1	X	15.621	X	3.346
2	=	0.5	X	(4.191+10.601)	X	4.871
4	=	1	X	18.304	X	9.096
5	=	1	X	12.800	X	1.505
4	=	1	X	3.800	X	1.505
						TOTAL = 279.469 SQM
TOTAL FAR 1ST FLOOR NURSERY SCHOOL						GROSS - A + GROSS - B = 279.469 + 3.312 = 282.781 SQM

DEDUCTION						
GROSS - C						
A	=	1	X	6.203	X	3.230
B	=	1	X	1.900	X	2.000
C	=	0.5	X	1.464	X	1.025
D	=	0.5	X	1.434	X	1.240
E	=	1	X	1.285	X	1.305
F	=	1	X	4.295	X	6.235
G	=	1	X	2.522	X	6.430
						TOTAL = 70.807 SQM


ARC AREA		ADDITIONAL										
GROSS - B												
3	=	1	X	3.14	x	13.482	x	13.482	x	35	\	360
- 1 x 13.482 - 0.615 x 8.051 = 3.312 sqm.												
TOTAL = 3.312 SQM												

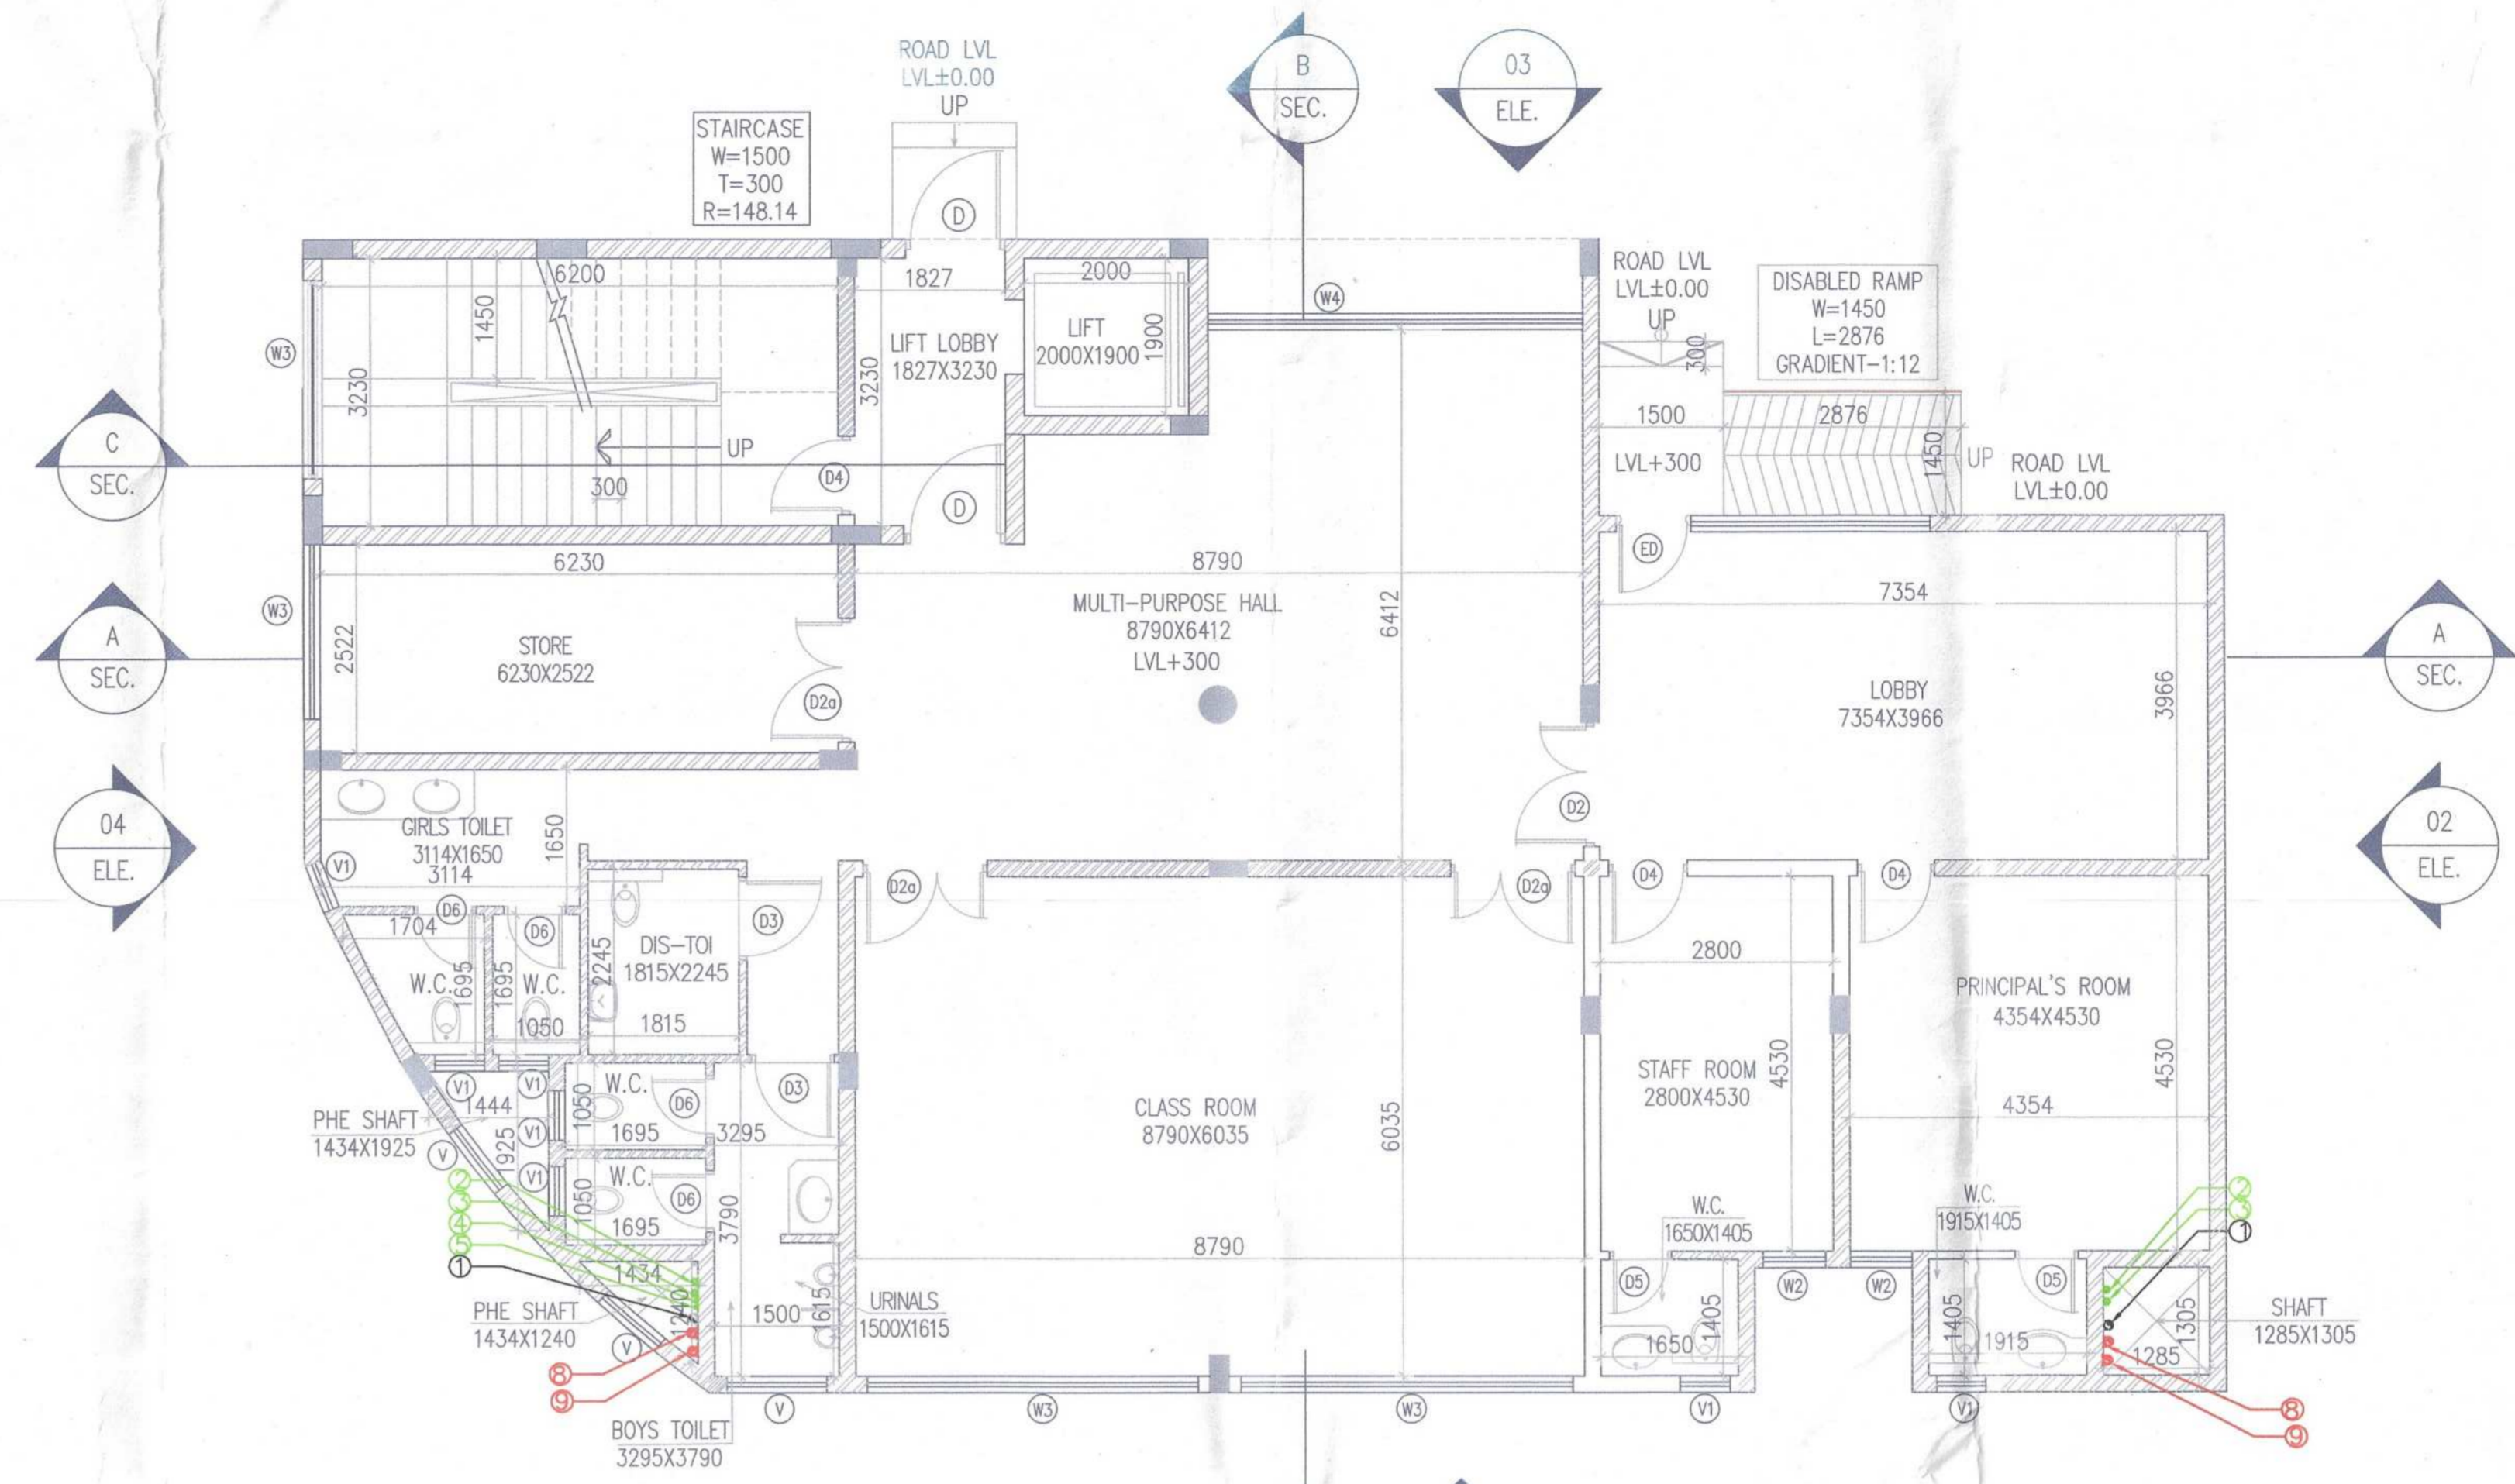

GROUND FLOOR PLAN

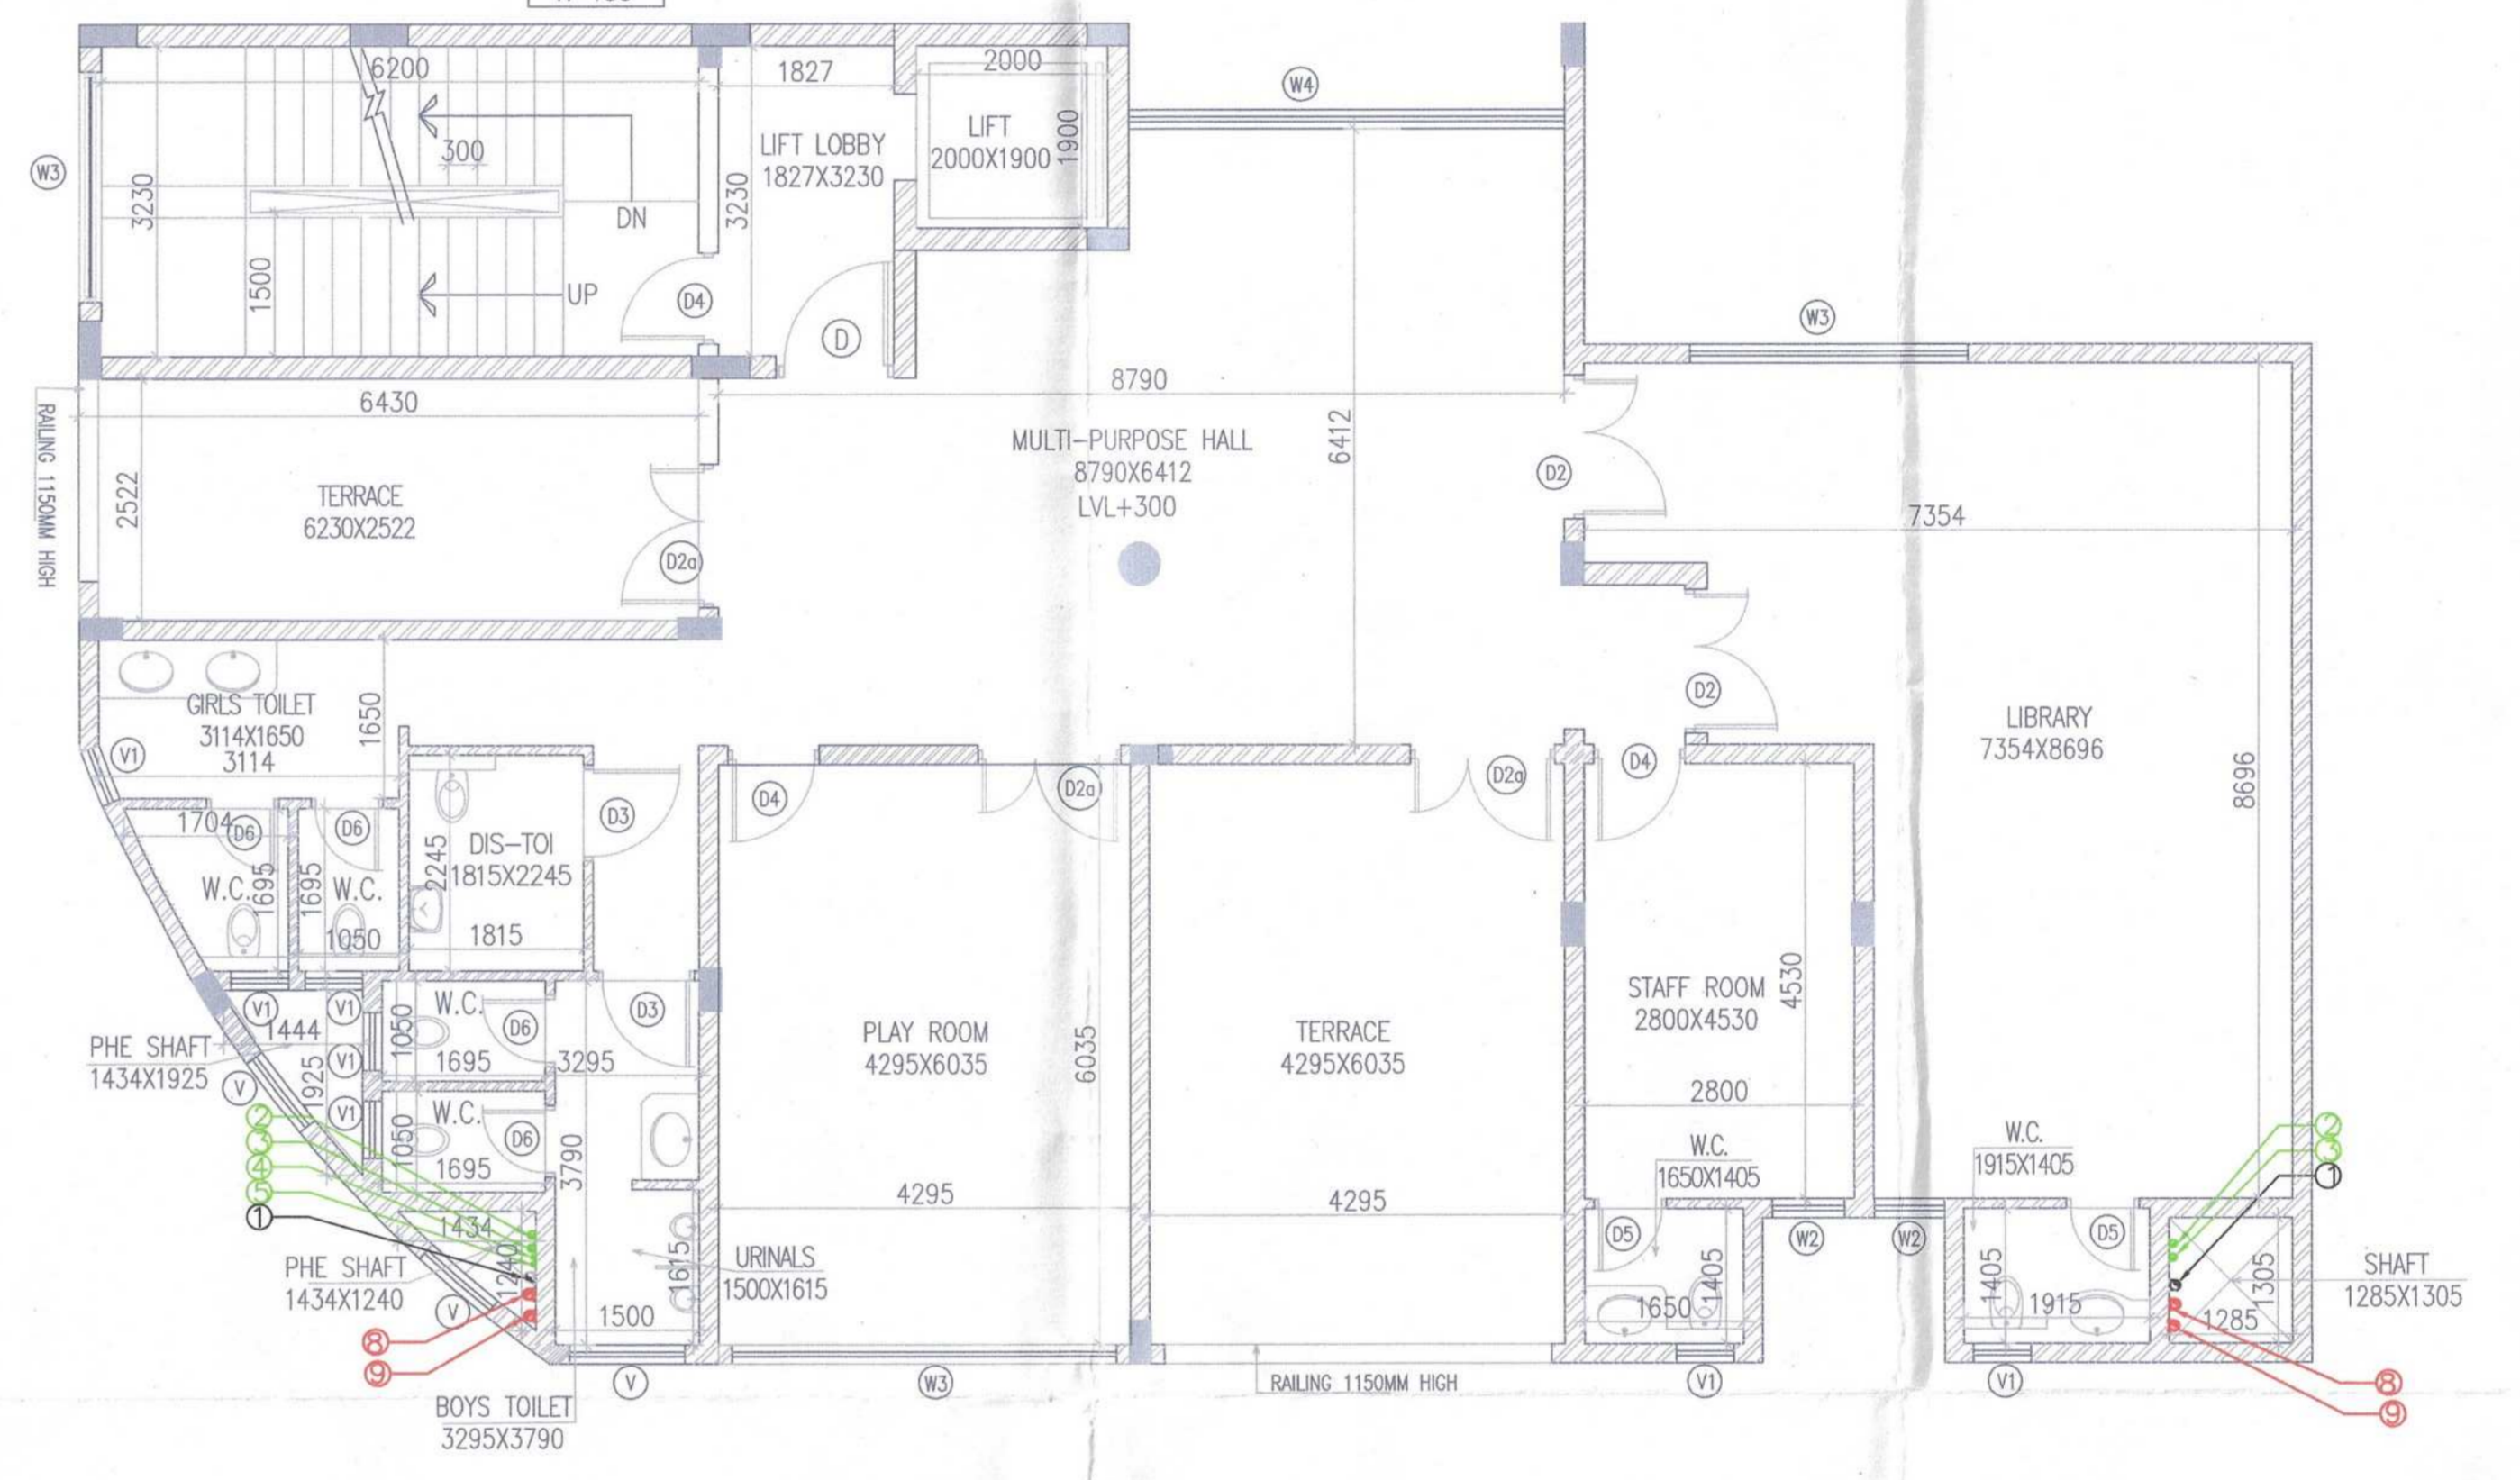

1st FLOOR PLAN

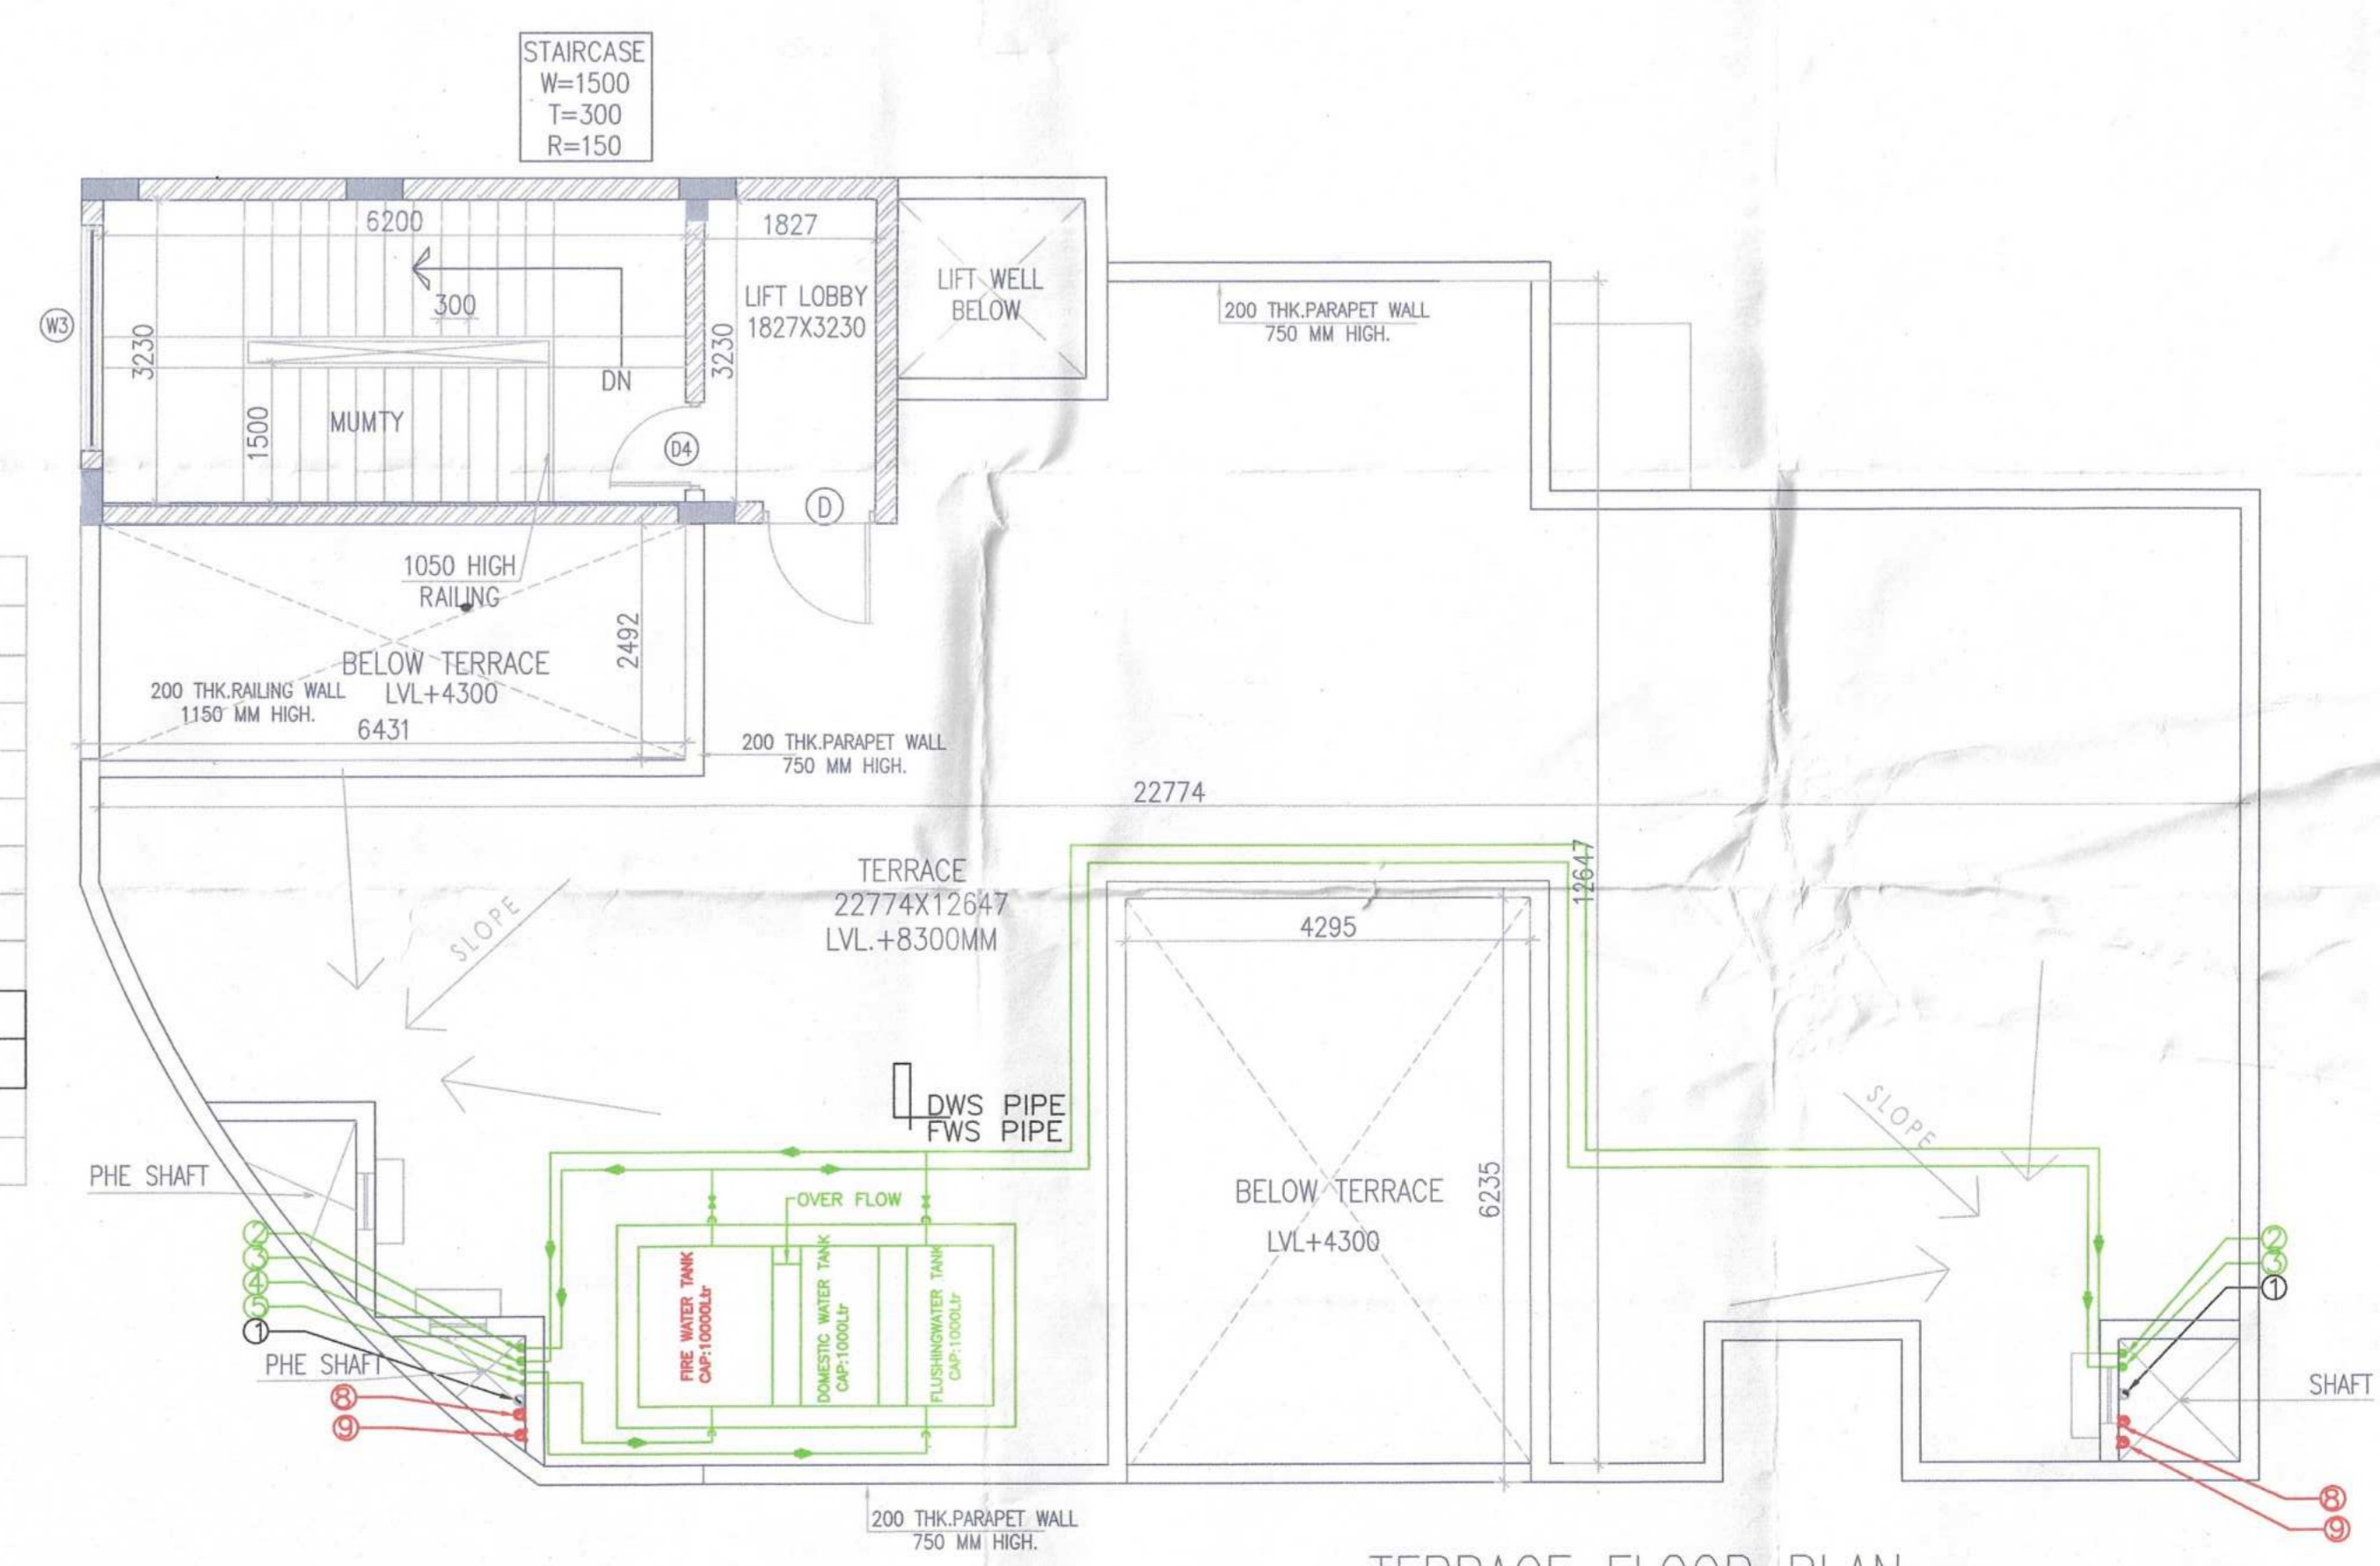

TERRACE FLOOR PLAN








Note :-
1. BUILDING HAS AUTOMATIC SPRINKLER SYSTEM WHEREVER REQUIRED BY NBC.
2. BUILDING WILL BE DESIGNED (STRUCTURES) AS PER RELEVANT IS CODES FOR EARTH QUAKE RESISTANCE.

SANCTIONED TO BE READ WITH THIS OFFICE MEMO NO. DATED: PROJECT: PROPOSED GROUP HOUSING COLONY MEASURING 24.10 ACRES (LICENCE NO 80 OF 2012 DATED 17/08/2012) IN SECTOR 106, GURUGRAM MANESAR URBAN COMPLEX BEING DEVELOPED BY ARMD DEVELOPERS LTD. & OTHERS.


OWNER'S SEAL & SIGNATURE: Airmid Developers Limited. Architect's SEAL & SIGNATURE: AVINASH CHANDRA VAIDYA, Architect No. CA75/02008, H. No. 163, P/14, New Palam Vihar, Gurugram.

Scale: 1:100. Drawing No: NS-01. SHEET NO. (GROUND FLOOR, TERRACE PLAN) (NURSERY SCHOOL).

Executive Engineer-IV W/S Division, GMDA Gurugram. Executive Engineer-III Drainage Division, GMDA, Gurugram. Chief Engineer, (Infra-II), GMDA Gurugram.

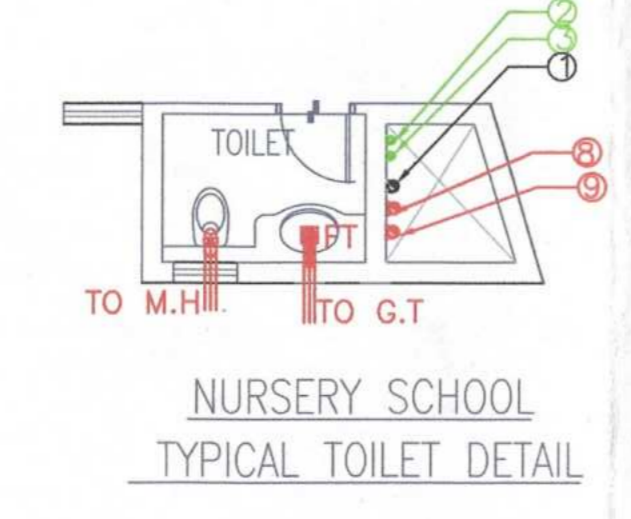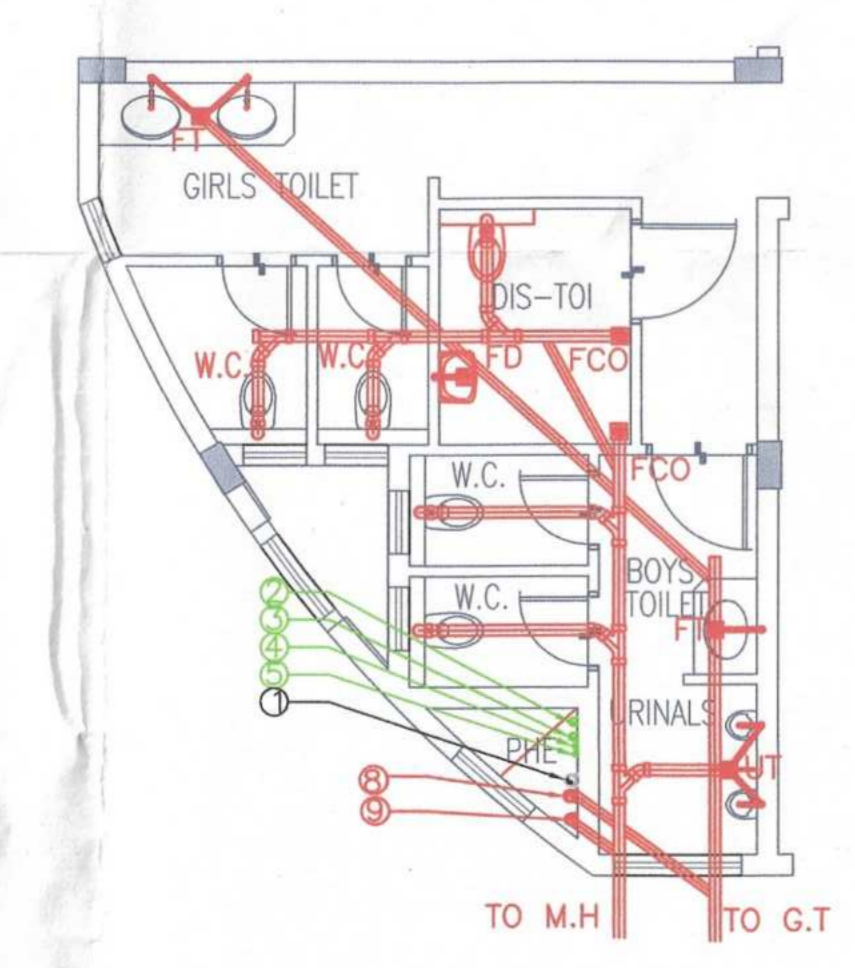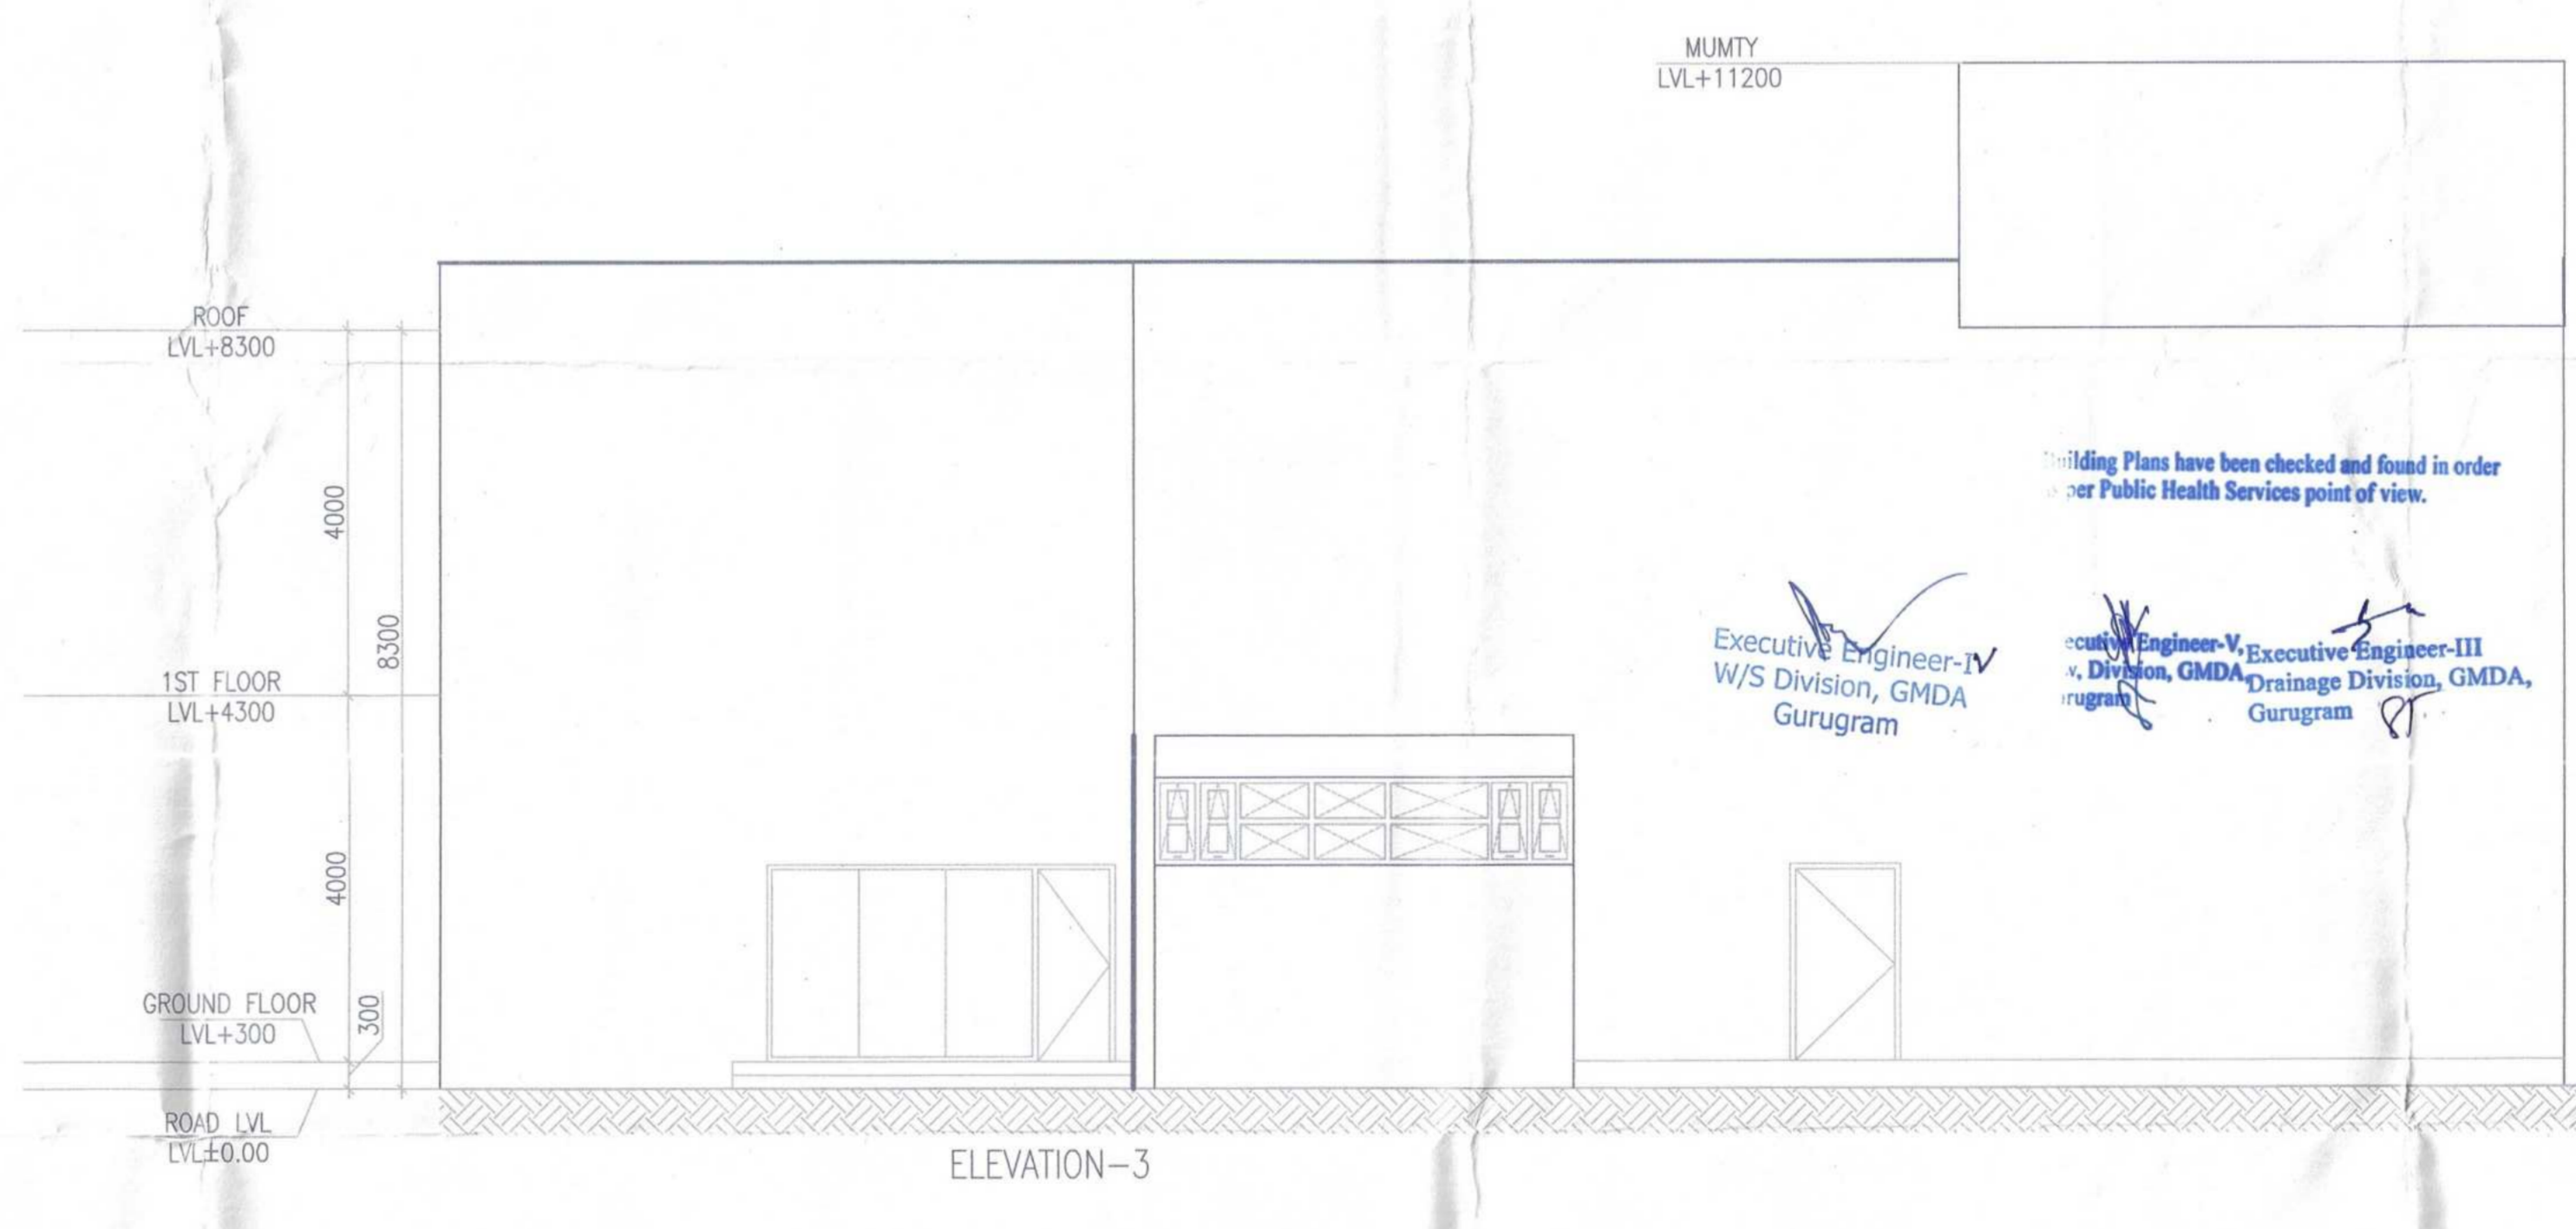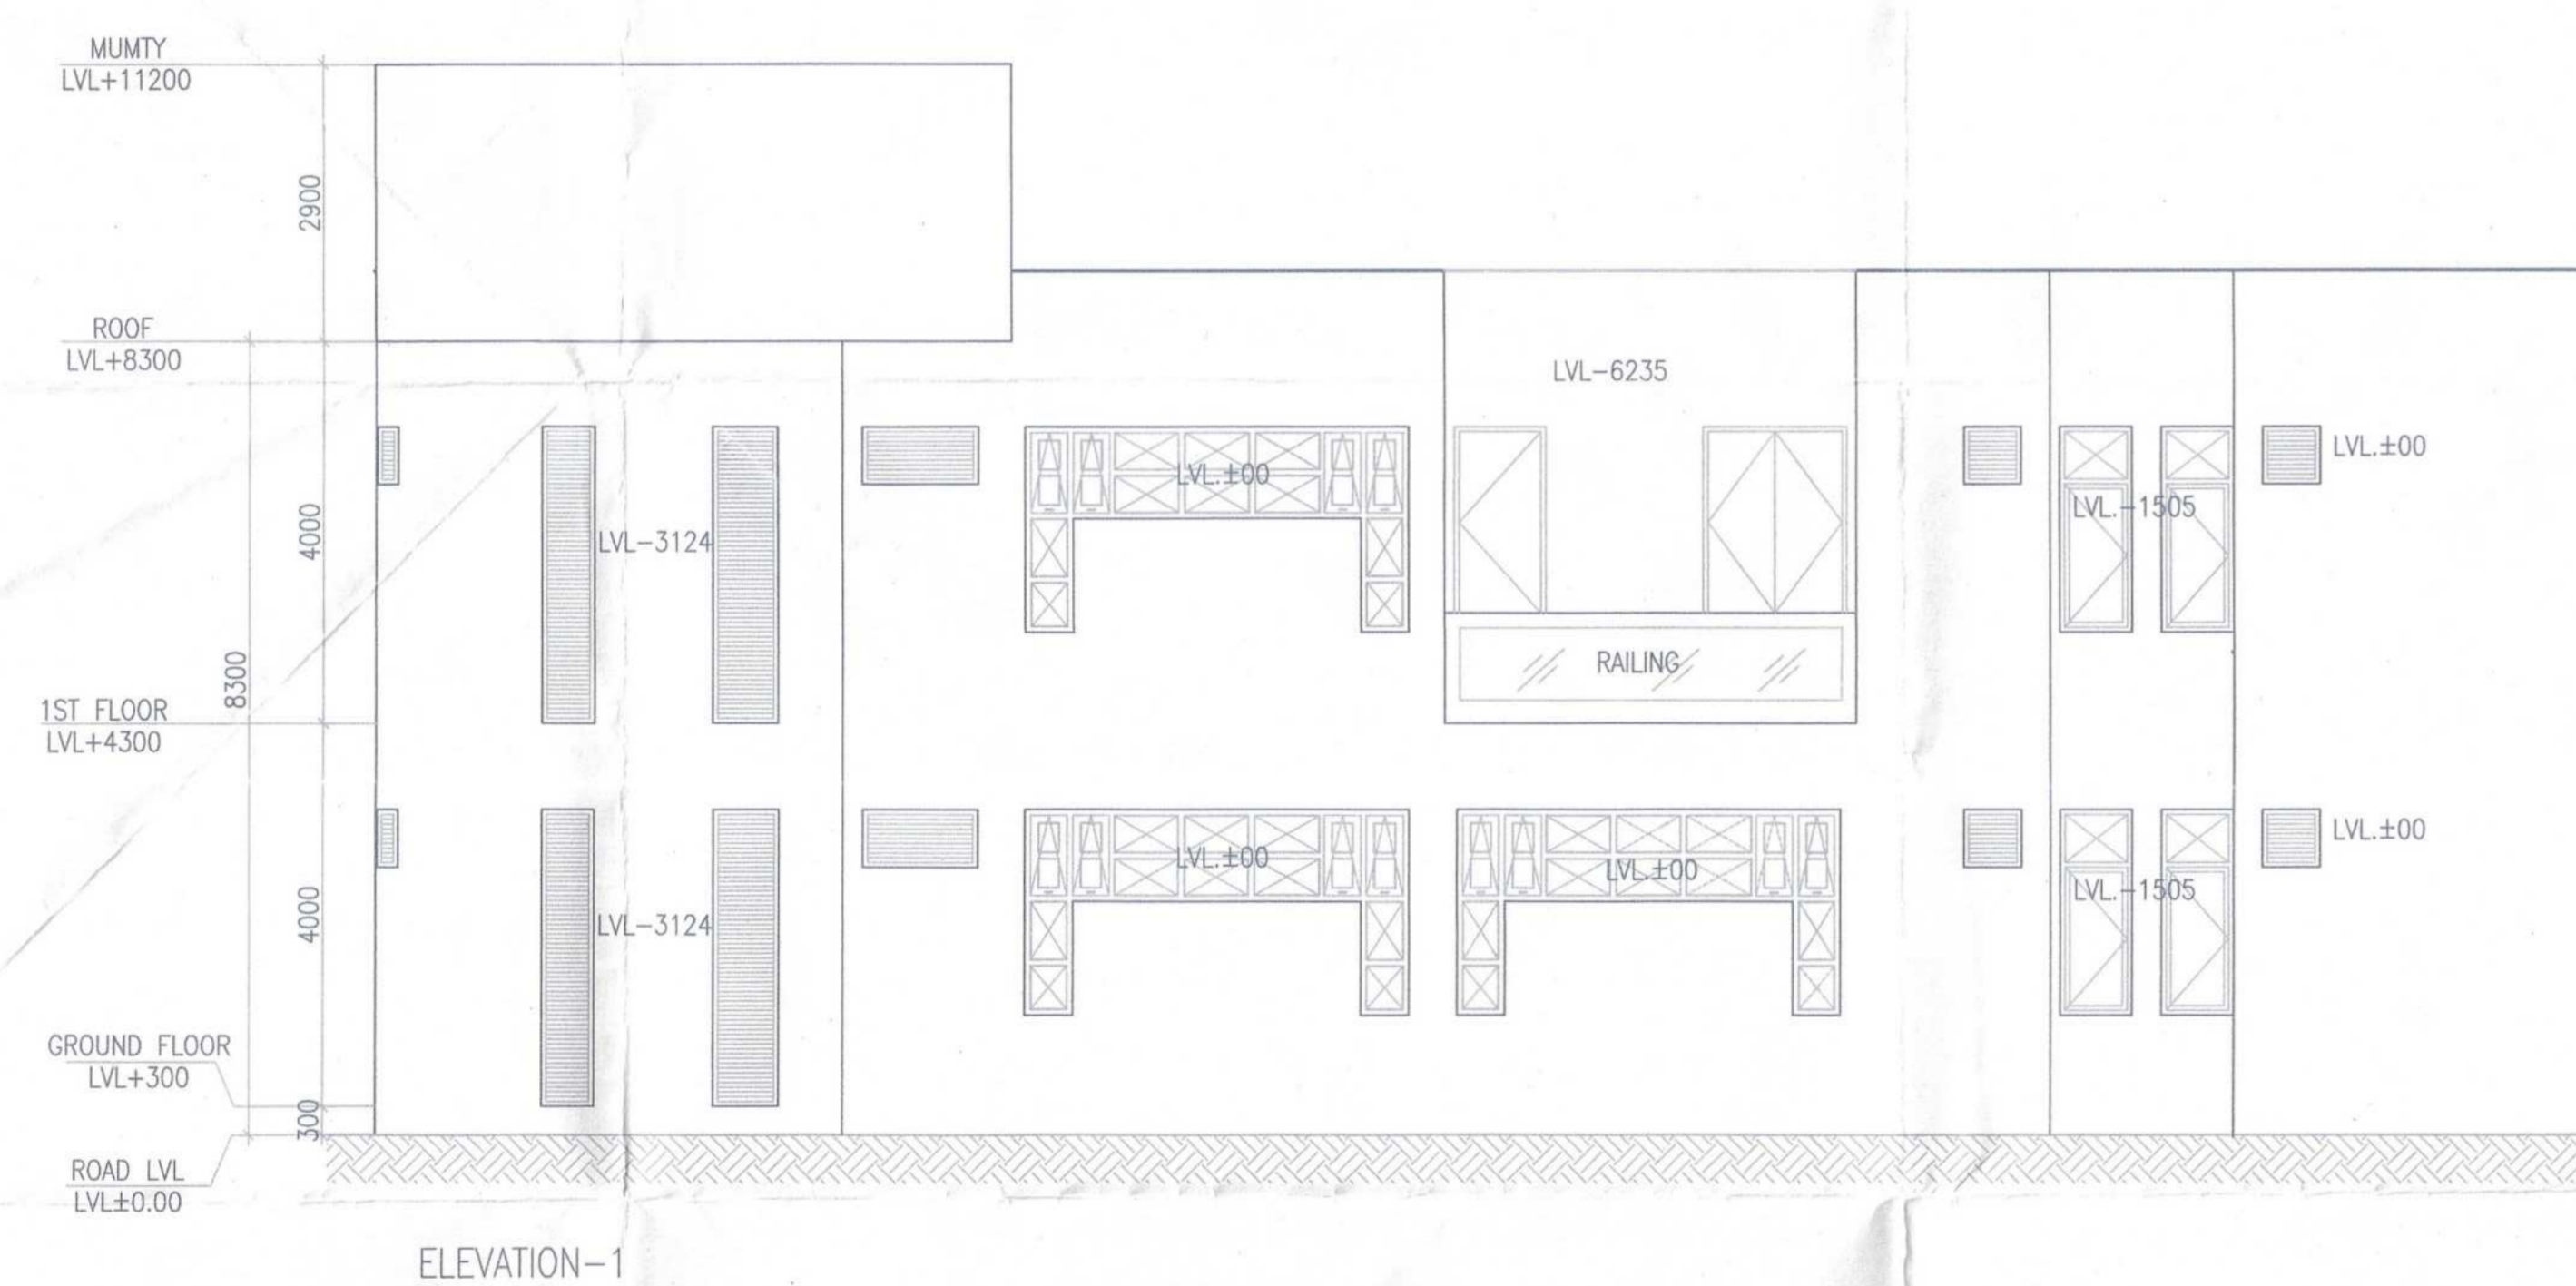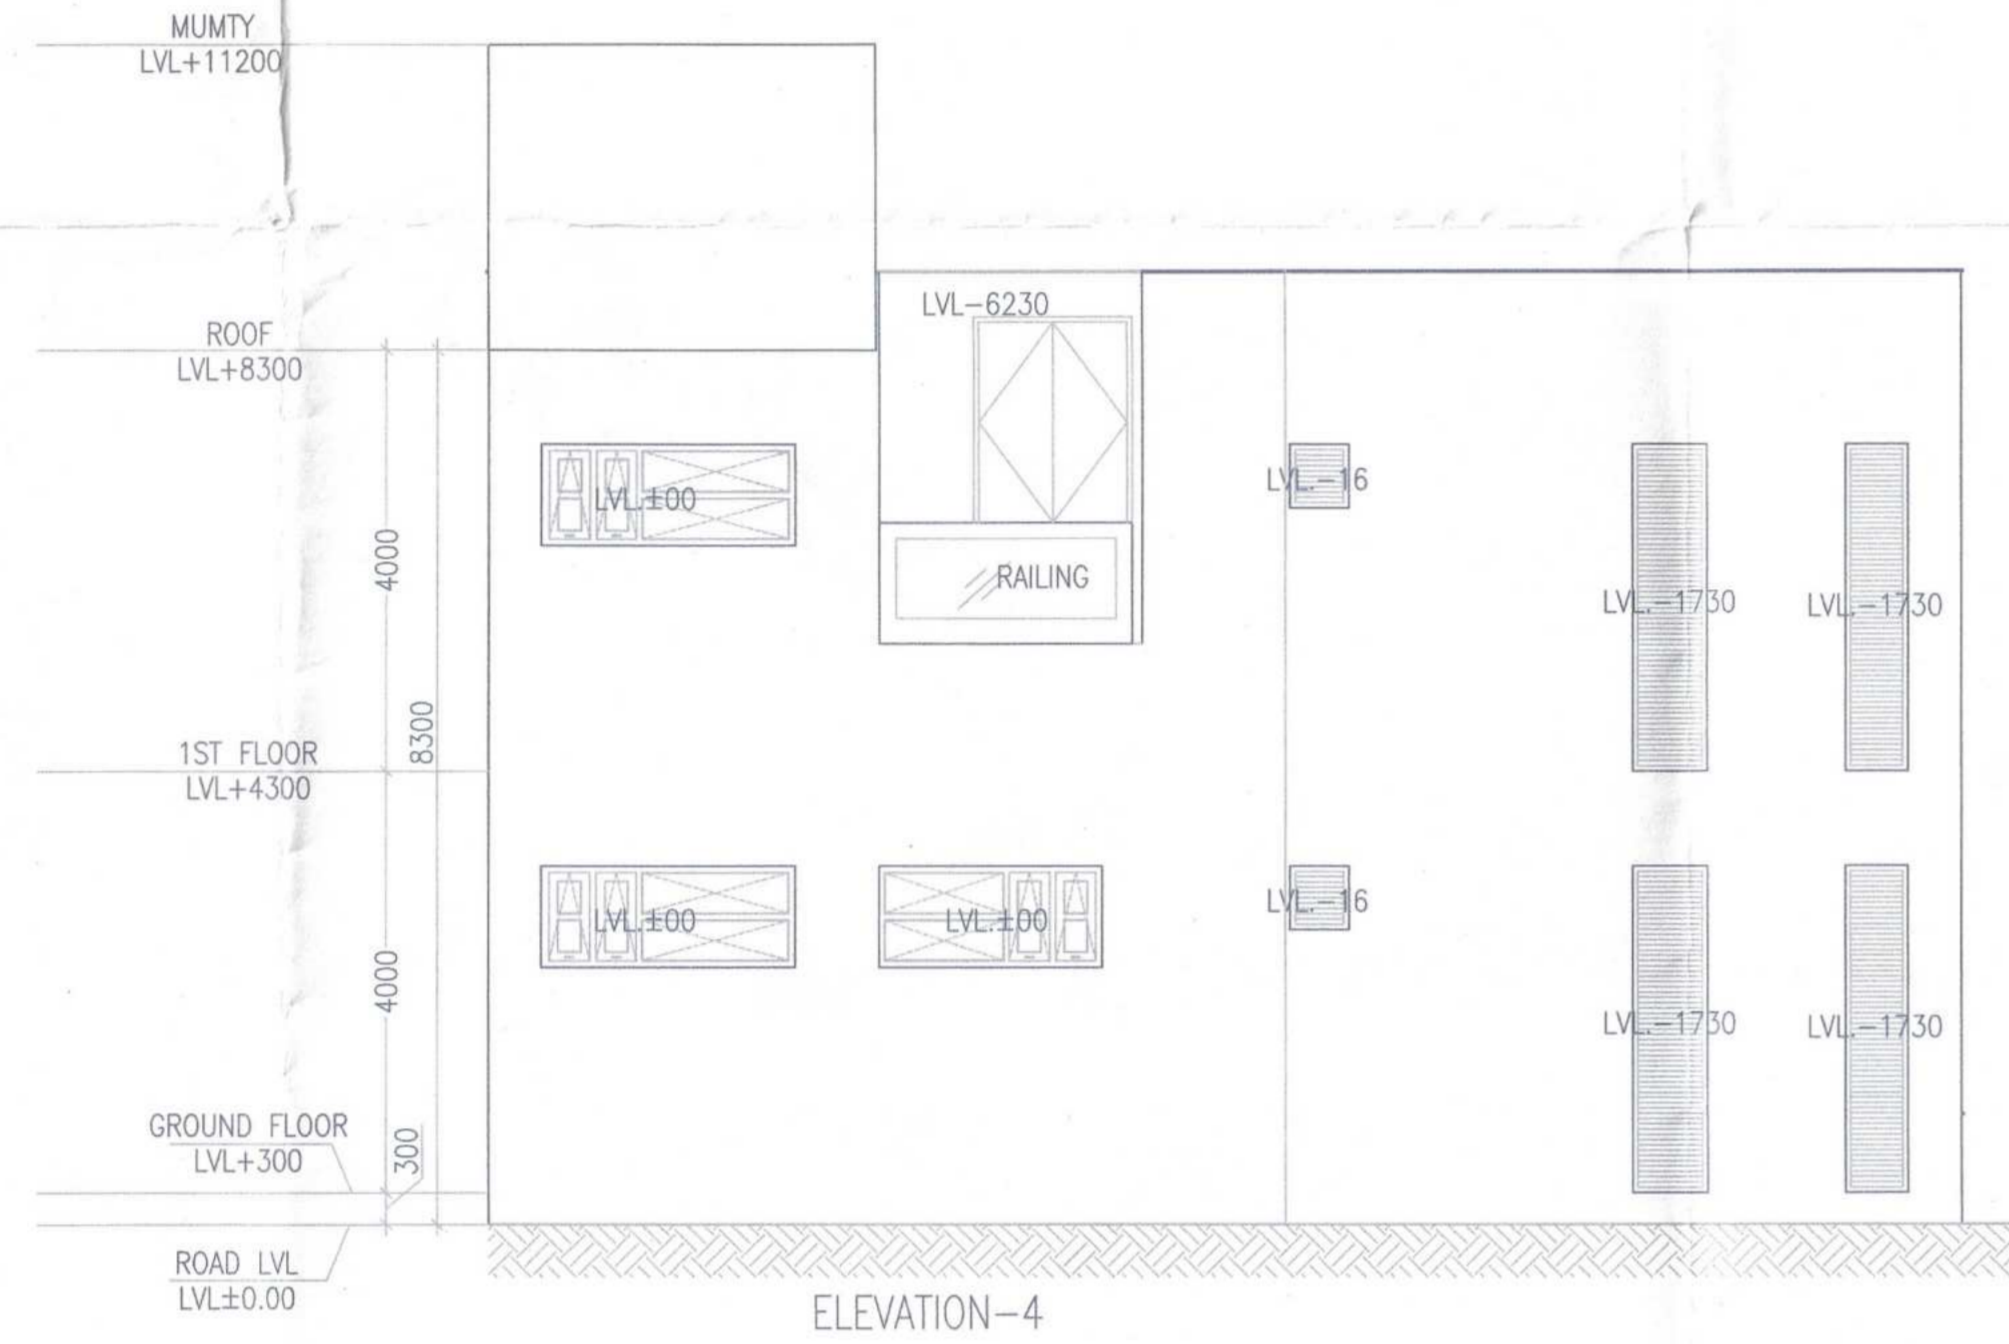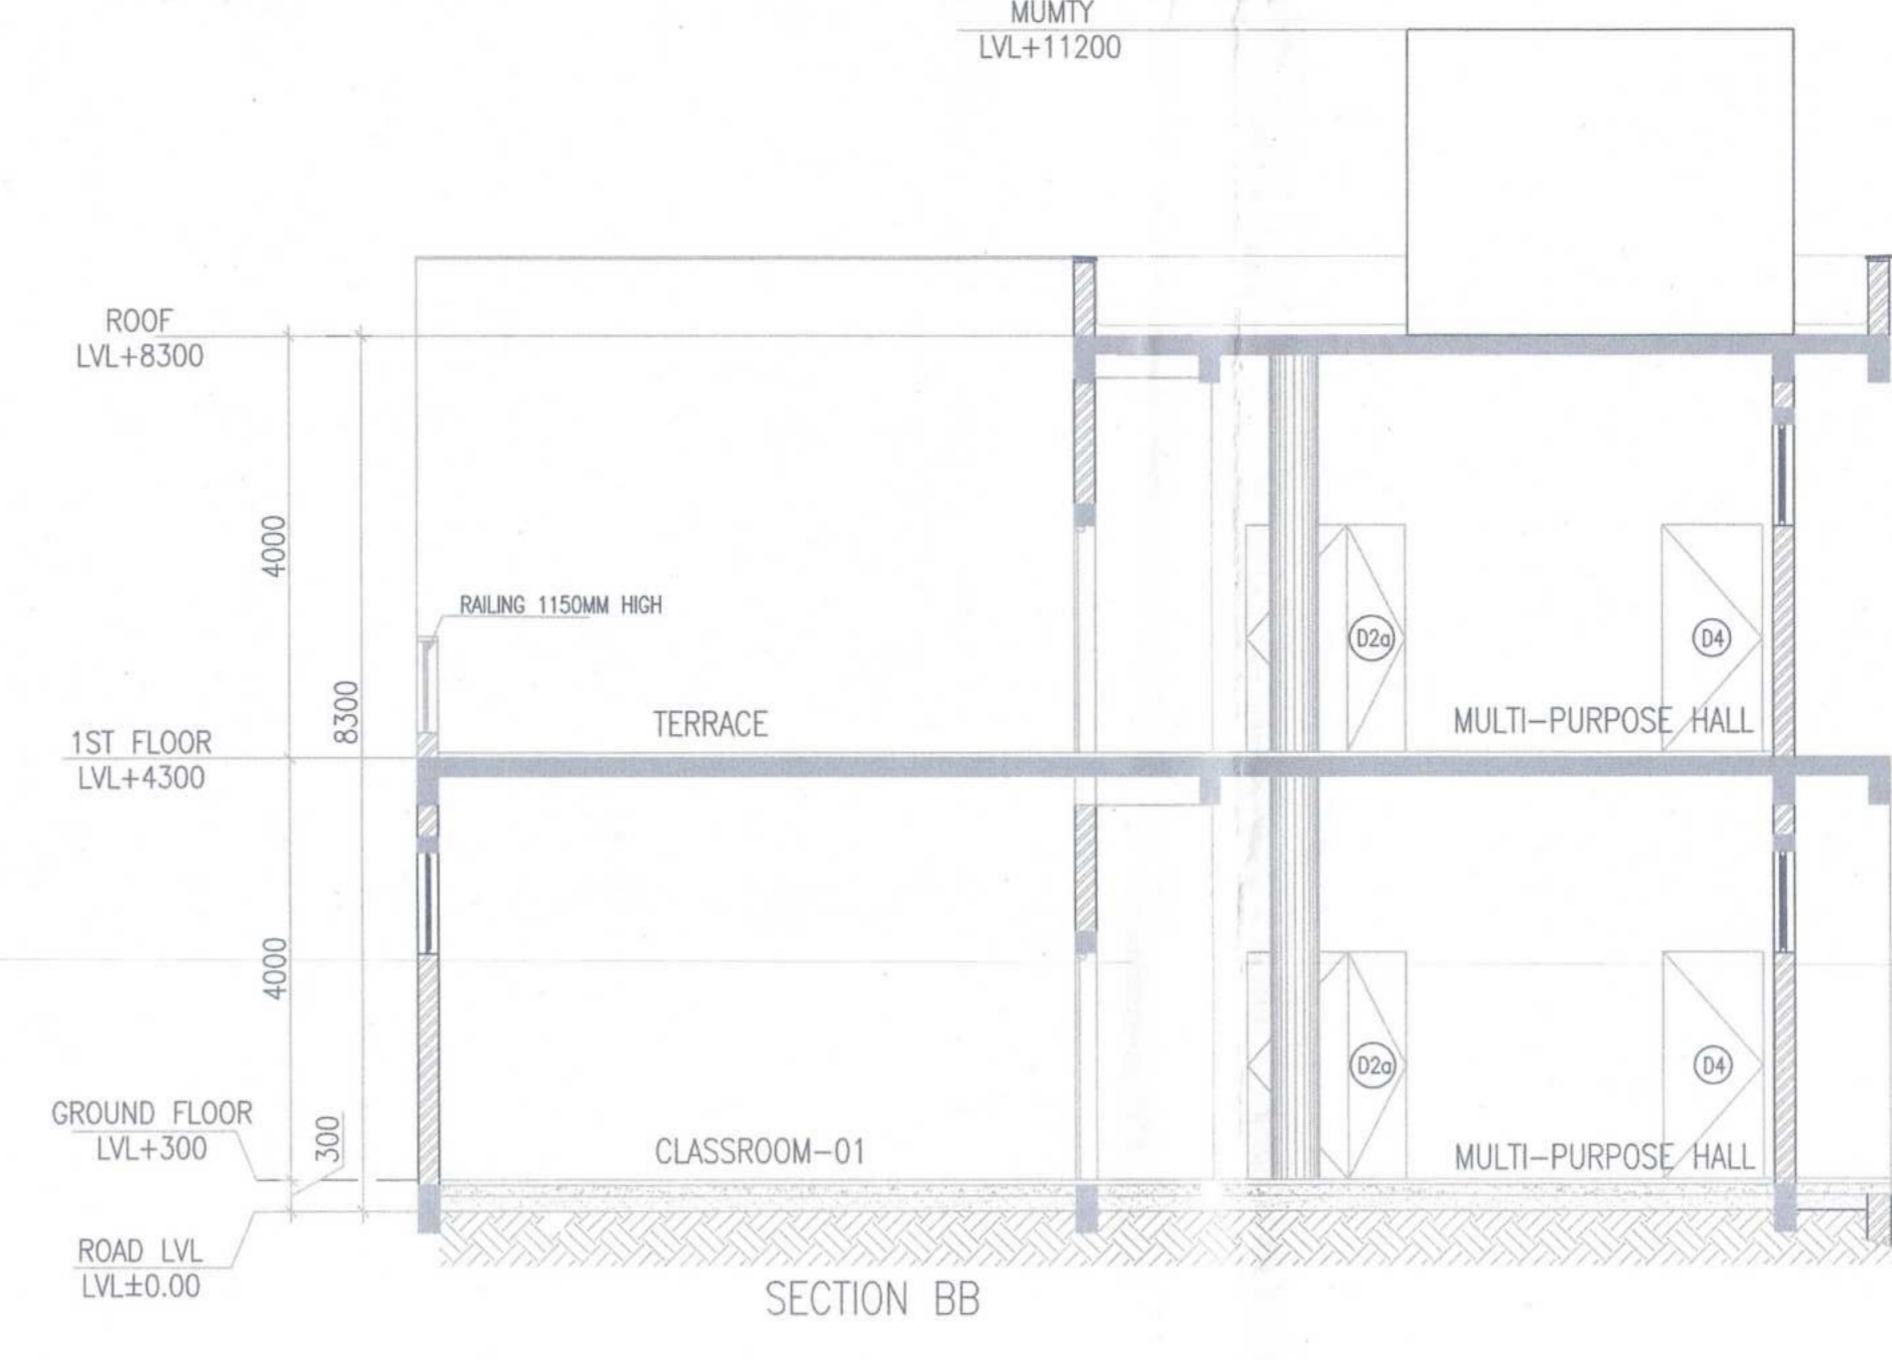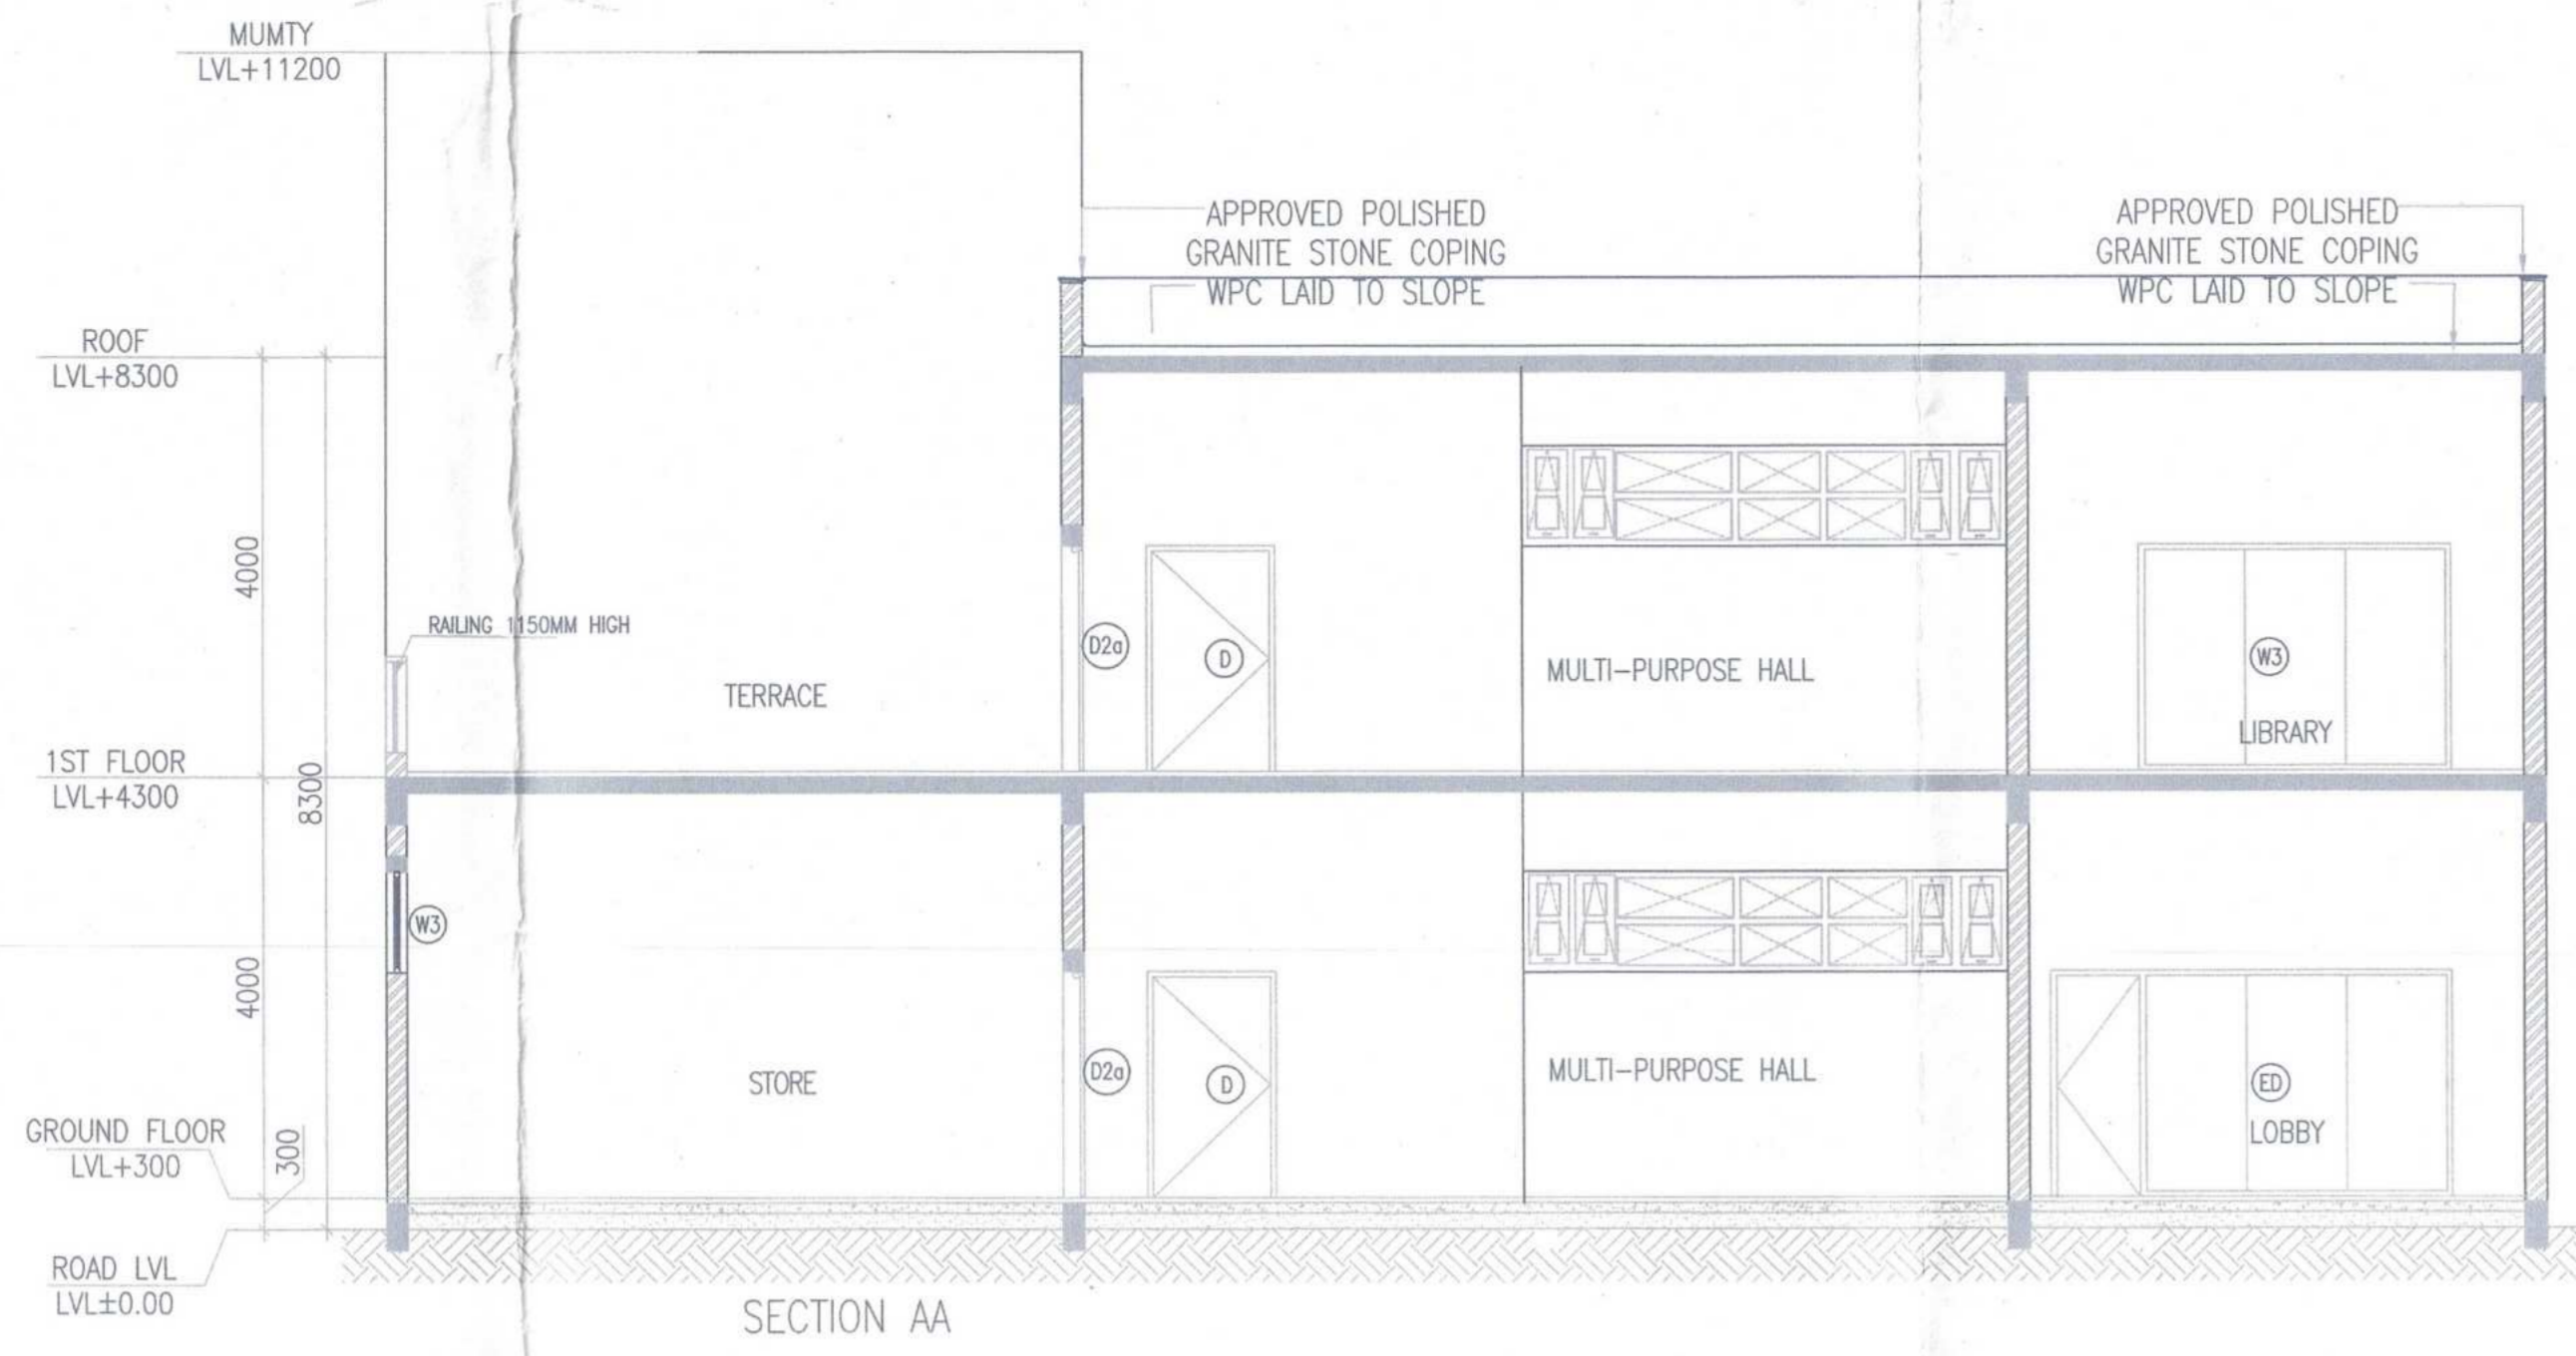

LEGEND:-	
1. UPVC R.W.P. FROM TERRACE	□
2. DOMESTIC WATER DOWN TAKE SUPPLY PIPE	□
3. FLUSHING WATER DOWN TAKE PIPE	□
4. FLUSHING WATER RISER PIPE	□
5. DOMESTIC WATER RISER PIPE	□
6. FLOOR TRAP (100x100/150mm)	■
7. FLOOR DRAIN (100x75mm)	■
8. WASTE PIPE LINE	—
9. SOIL PIPE LINE	—
10. DOMESTIC WATER SUPPLY	—
11. FLUSHING WATER SUPPLY	—

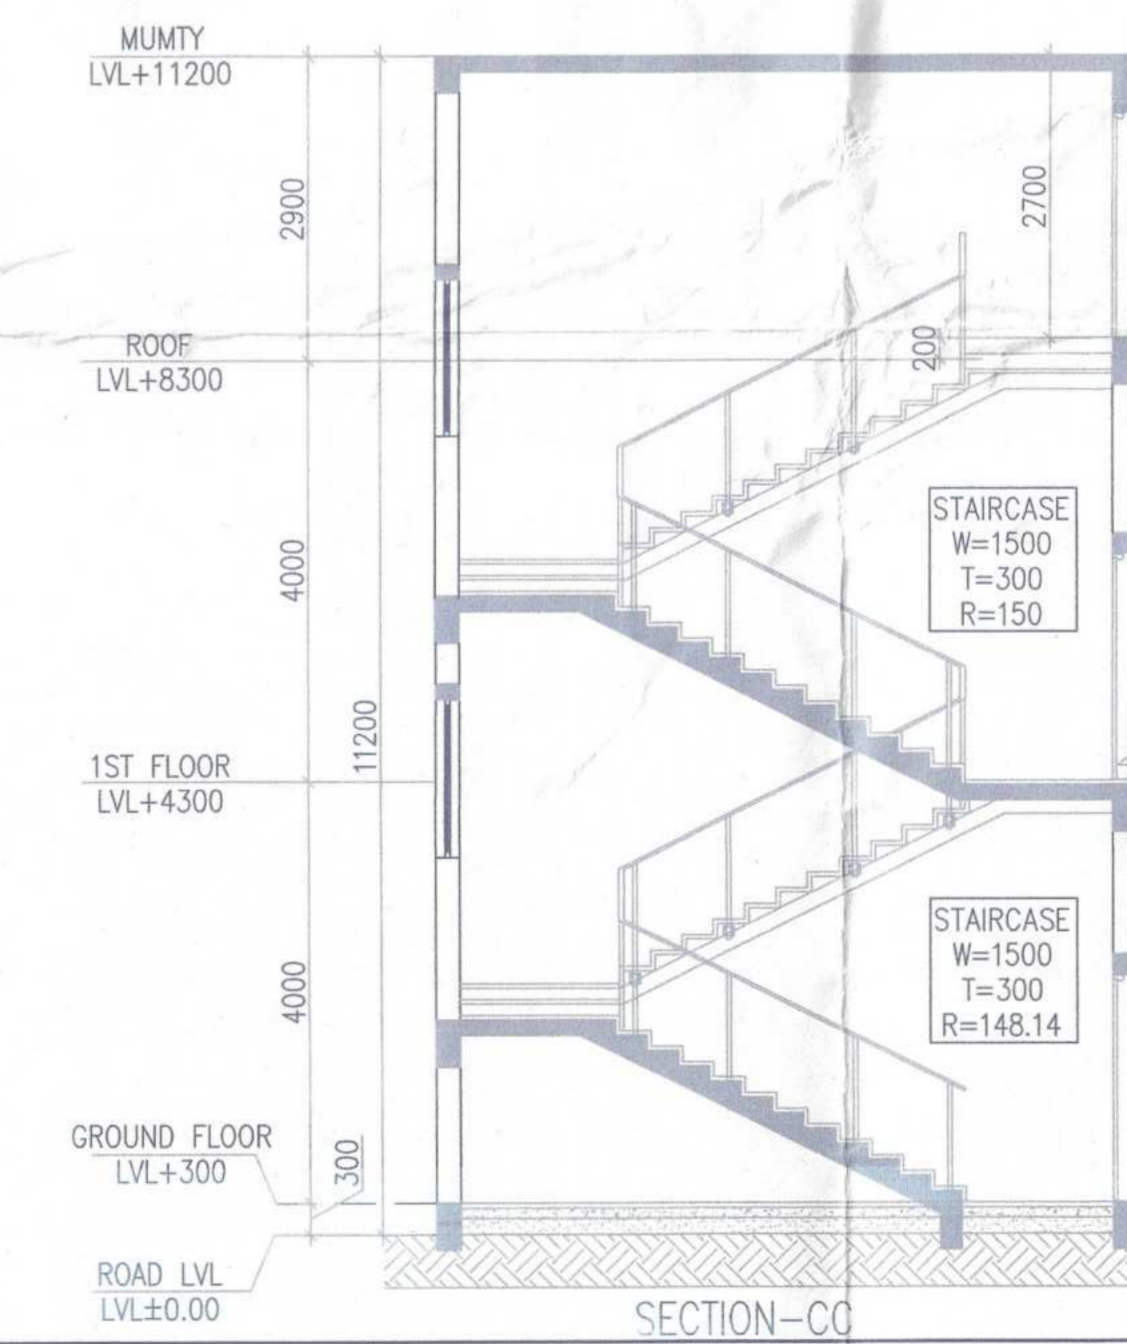

Note -
 1. BUILDING HAS AUTOMATIC SPRINKLER SYSTEM WHEREVER REQUIRED BY NBC.
 2. BUILDING WILL BE DESIGNED (STRUCTURES) AS PER RELEVANT IS CODES FOR EARTH QUAKE RESISTANCE.

SAISONED MEMO NO. DATED: PROJECT: PROPOSED GROUP HOUSING COLONY MEASURING 24.10 ACRES (LICENCE NO 80 OF 2012 DATED 17/08/2012) IN SECTOR 106, GURUGRAM MANESAR URBAN COMPLEX BEING DEVELOPED BY AIRMID DEVELOPERS LTD. & OTHERS.

OWNER'S SEAL & SIGNATURE: AIRMID DEVELOPERS LIMITED

ARCHITECT'S SEAL & SIGNATURE: AVINASH CHANDRA VAIDYA Architect No. CA/75/02005 H. No. 188, PH-4 New Palam Vihar, Gurugram

AUG-2022 Scale: 1:100 Drawing Title: ELEVATION-1-1, 2-2, 3-3, 4-4 SECTION-A-A, B-B & C-C TOILET DETAIL (NURSERY SCHOOL) Drawing No: NS-02

Building Plans have been checked and found in order for Public Health Services point of view.

Executive Engineer-IV W/S Division, GMDA Gurugram

Executive Engineer-V, Executive Engineer-III & Division, GMDA W/S Division, Gurugram

Chief Engineer, (Infra-I), GMDA Gurugram



DINESH KUMAR PAI(HQ) MEMBER B.P.A.C.

Note :-
 1. BUILDING HAS AUTOMATIC SPRINKLER SYSTEM WHEREVER REQUIRED BY NBC.
 2. BUILDING WILL BE DESIGNED STRIKETUBES AS PER RELEVANT CODES FOR EARTH QUAKE RESISTANCE.



SCHEDULE OF DOORS + WINDOWS

SCHEDULE OF OPENINGS		TYPE SIZE	LOCATION	DESCRIPTION	SILL FROM FFL FROM FFL	UNTEL FROM FFL
FD	1200x2400	FAN RM	DC RM / PUMP RM	FIRE DOOR	+2400	+2400
FD1	2930x2400	ELC. RM / OMC RM	DC RM / PUMP RM	DC-FIRE/ACOUSTICS DOOR	+2400	+2400
FD2	1500x2300	STAIRCASE	ELC. RM / OMC RM	FIRE DOOR	+100	+2400
FD3	1100x2400	REFUGE AREA	STAIRCASE	FIRE DOOR	+2400	+2400
FD4	1000x2400	STAIRCASE/LIFT LOBBY	STAIRCASE/LIFT LOBBY	FIRE DOOR	+2400	+2400
FD5	750x2300	ELECTRICAL/LV/CWP	STAIRCASE	FIRE DOOR	+100	+2400
FD6	600x2300	CWP	CWP	FIRE DOOR	+100	+2400

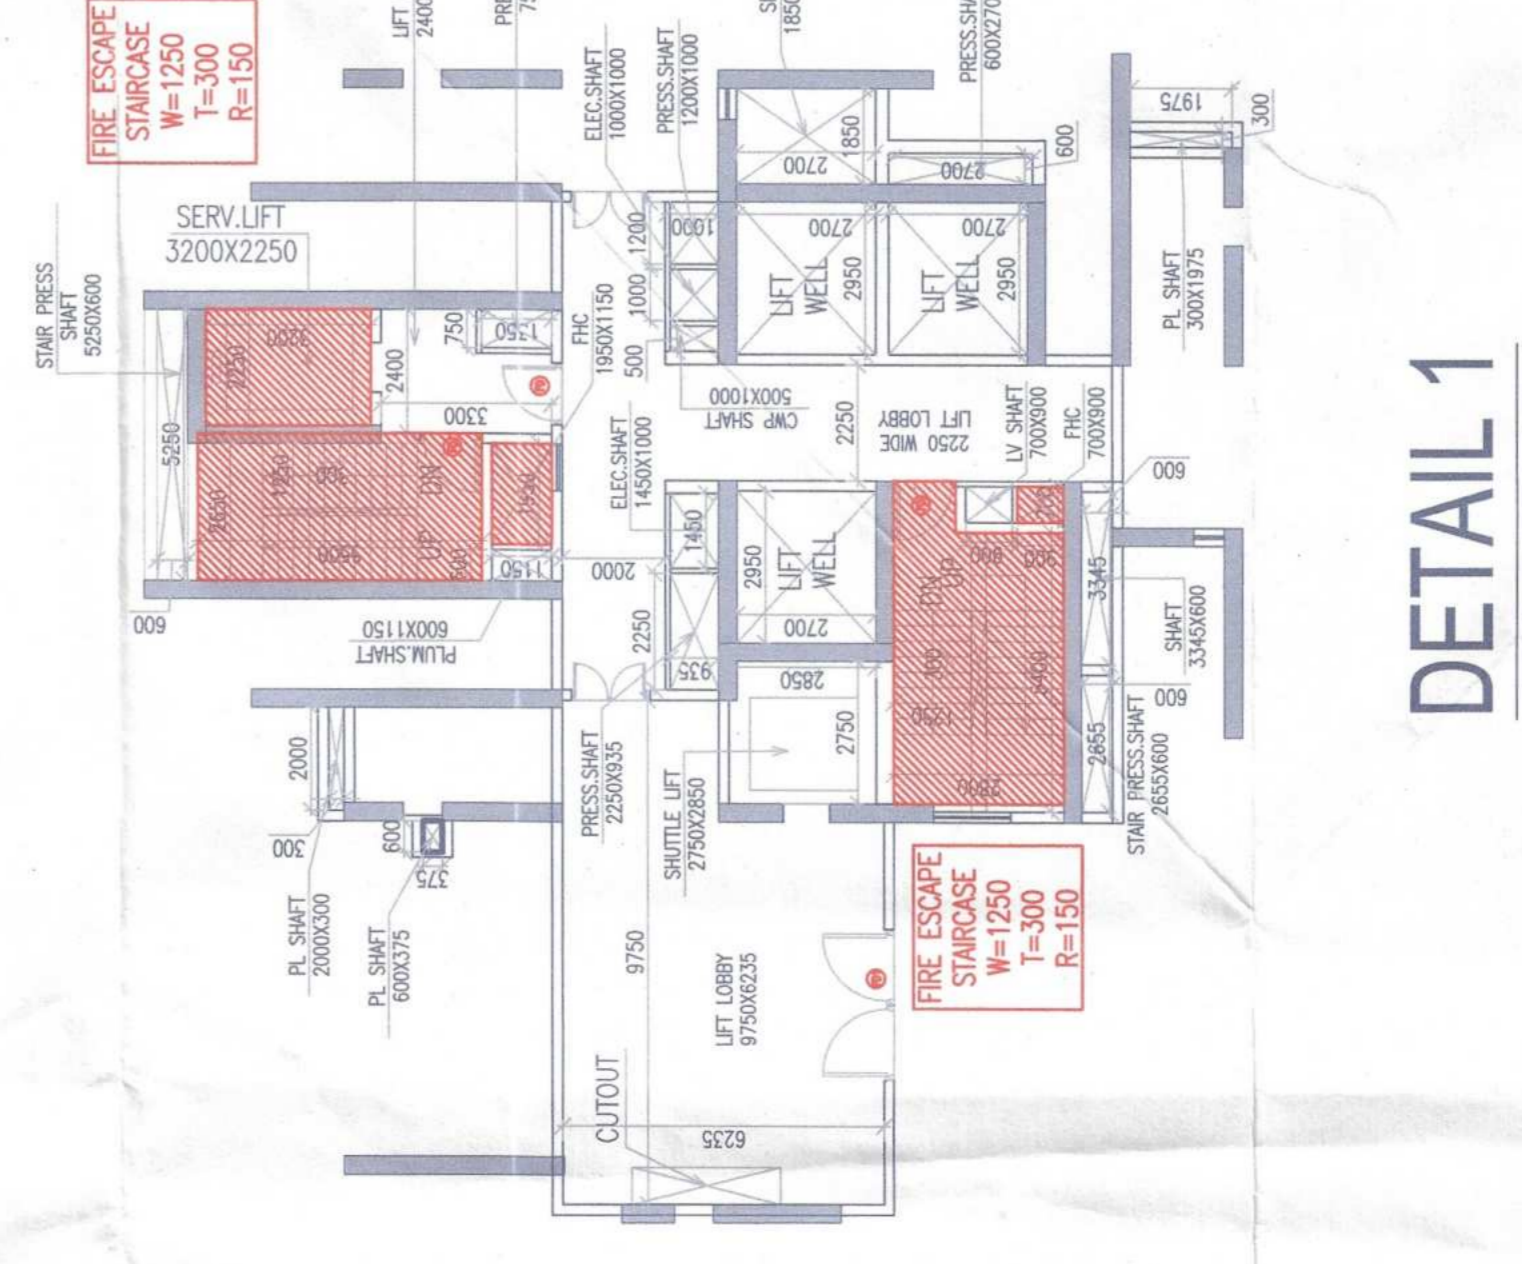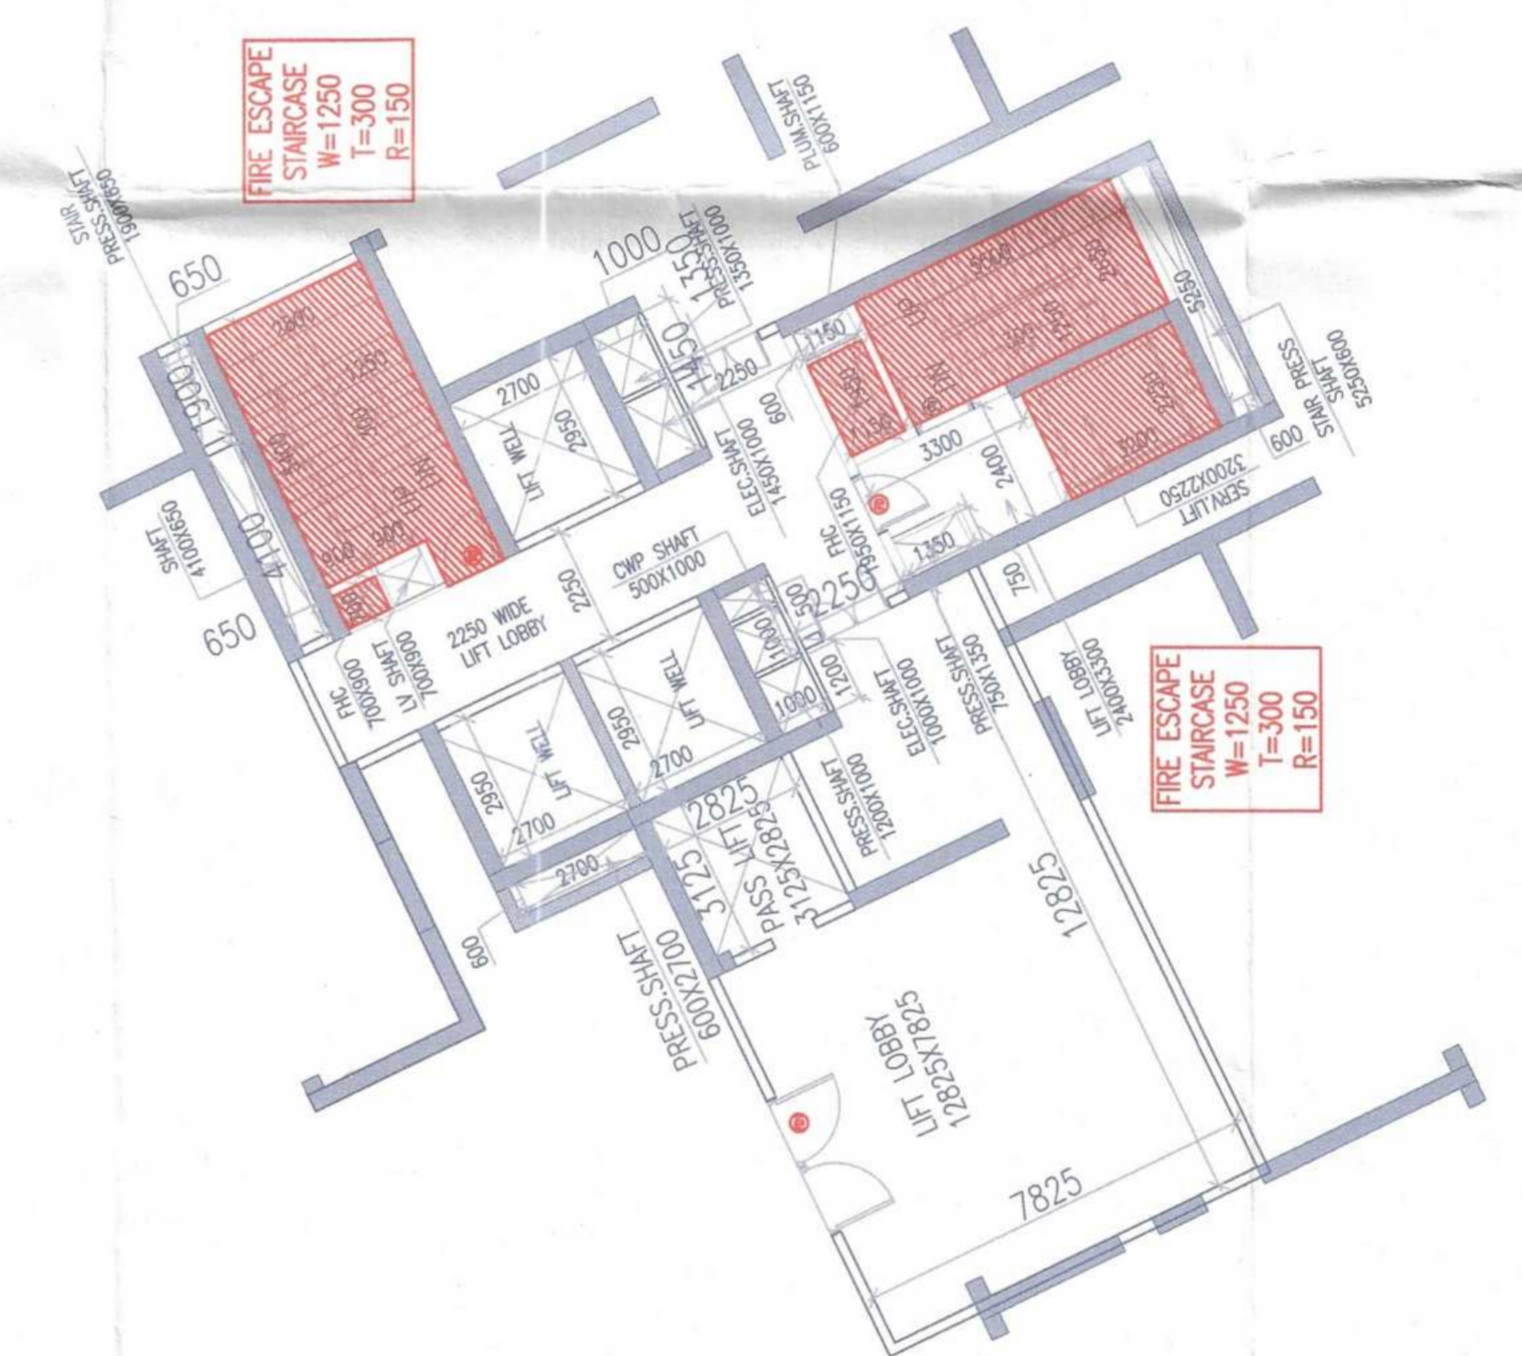

TO BE SANCTIONED WITH THE OFFICE
 MEMO NO. _____
 DATED: _____

FHC 600X900mm
 FHC 700X900mm
 FHC 600X900mm


PROJECT: DC (VT) PROPOSED BUILDING PLAN MEMBERSHIP COLONY MASHI-BAC 24.10 ACRES (LICENSE NO 80 OF 2012 DATED 17/08/2012) IN SECTOR 108, GURUGRAM MANESAR URBAN COMPLEX BEING DEVELOPED BY ARMO DEVELOPERS LTD. & OTHERS. OWNER'S SEAL & SIGNATURE: Armo Developers Limited, Armoed Strategies

ARCHITECT'S SEAL & SIGNATURE: ANANDHARATHNAM MADVA ARCHITECTS PVT. LTD. No. 45, P.H. Road, New Palam Vihar, Gurgaon

Scale: 1:300
 Drawing No: BA-01
 PHASE I - PLANS
 BASEMENT-1 - PLANS

Executive Engineer, WPS Gurgaon
 Executive Engineer-III, Gurgaon
 Executive Engineer, Gurgaon
 Chief Engineer, Gurgaon

1. BUILDINGS HAS AUTOMATIC SPRINKLER SYSTEM
WHATEVER REQUIRED IN NBC
2. BUILDING WILL BE EXPOSED TO STRUCTURES
AS PER PREVENT IS CORRECT FOR EARTHQUAKE RESISTANCE.

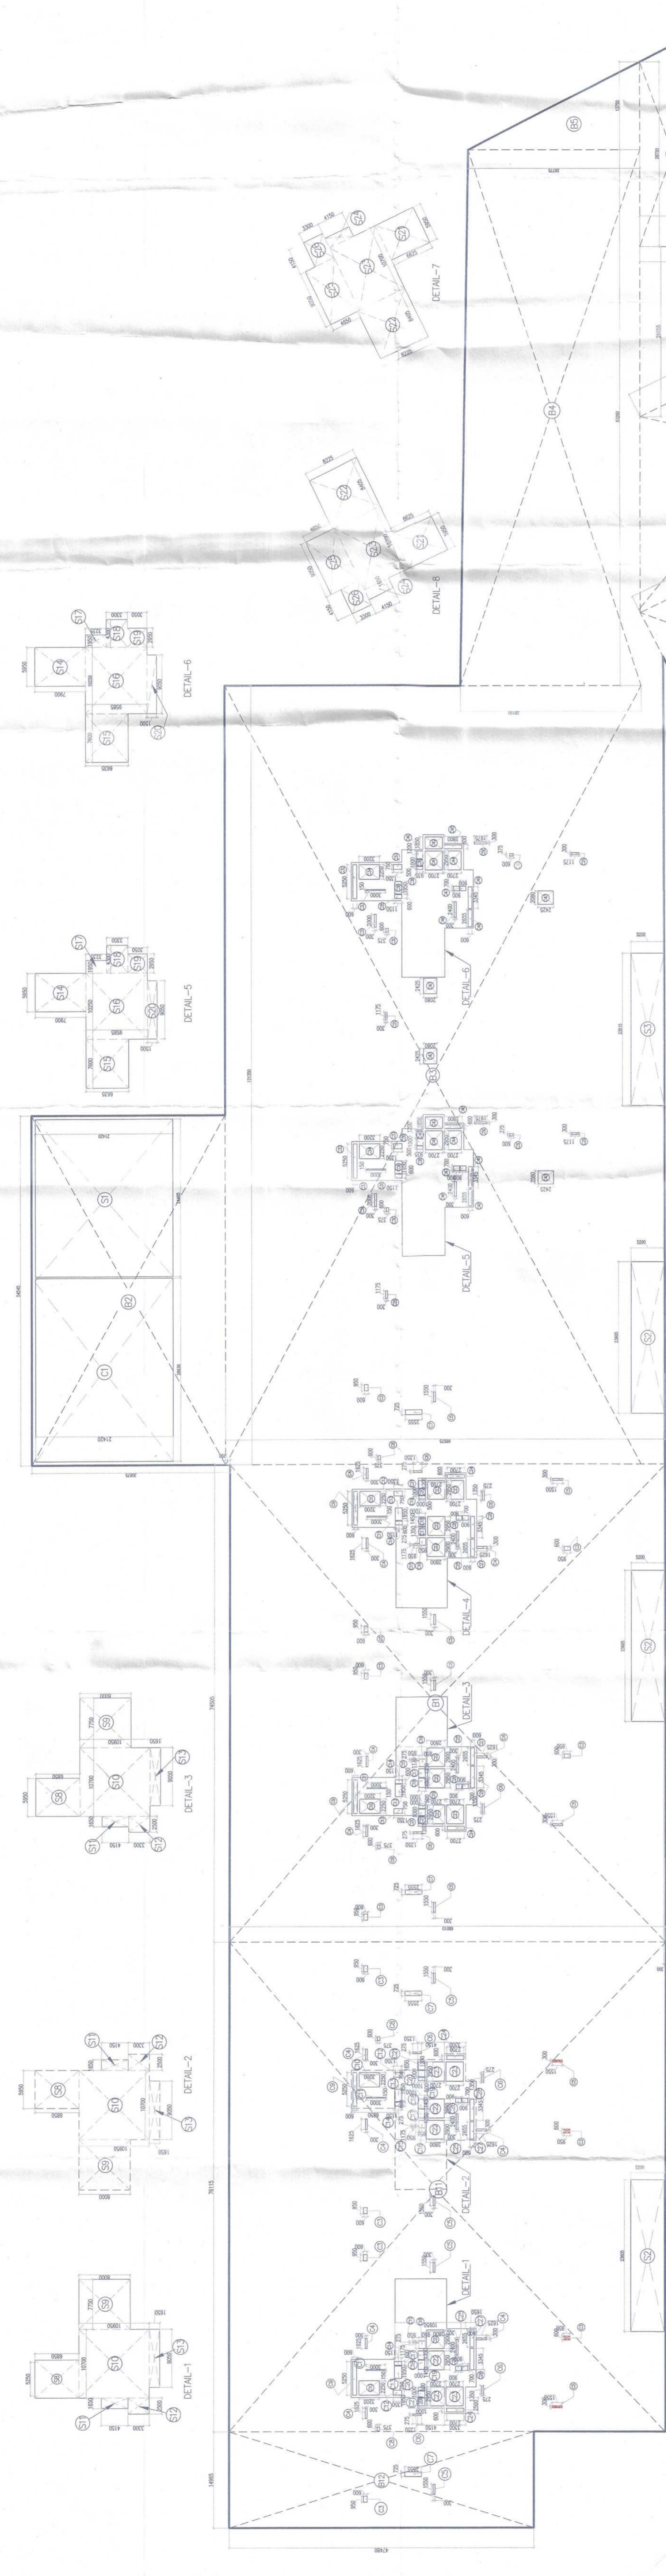

BASEMENT-01

GRID	NO	TYPE	AREA	UNIT	TOTAL AREA
101	1	X	68.172	SQ.M	68.172
102	1	X	68.172	SQ.M	68.172
103	1	X	68.172	SQ.M	68.172
104	1	X	68.172	SQ.M	68.172
105	1	X	68.172	SQ.M	68.172
106	1	X	68.172	SQ.M	68.172
107	1	X	68.172	SQ.M	68.172
108	1	X	68.172	SQ.M	68.172
109	1	X	68.172	SQ.M	68.172
110	1	X	68.172	SQ.M	68.172
111	1	X	68.172	SQ.M	68.172
112	1	X	68.172	SQ.M	68.172
113	1	X	68.172	SQ.M	68.172
114	1	X	68.172	SQ.M	68.172
115	1	X	68.172	SQ.M	68.172
116	1	X	68.172	SQ.M	68.172
117	1	X	68.172	SQ.M	68.172
118	1	X	68.172	SQ.M	68.172
119	1	X	68.172	SQ.M	68.172
120	1	X	68.172	SQ.M	68.172
TOTAL					818.064

GRID	NO	TYPE	AREA	UNIT	TOTAL AREA
121	1	X	68.172	SQ.M	68.172
122	1	X	68.172	SQ.M	68.172
123	1	X	68.172	SQ.M	68.172
124	1	X	68.172	SQ.M	68.172
125	1	X	68.172	SQ.M	68.172
126	1	X	68.172	SQ.M	68.172
127	1	X	68.172	SQ.M	68.172
128	1	X	68.172	SQ.M	68.172
129	1	X	68.172	SQ.M	68.172
130	1	X	68.172	SQ.M	68.172
TOTAL					818.064

GRID	NO	TYPE	AREA	UNIT	TOTAL AREA
131	1	X	68.172	SQ.M	68.172
132	1	X	68.172	SQ.M	68.172
133	1	X	68.172	SQ.M	68.172
134	1	X	68.172	SQ.M	68.172
135	1	X	68.172	SQ.M	68.172
136	1	X	68.172	SQ.M	68.172
137	1	X	68.172	SQ.M	68.172
138	1	X	68.172	SQ.M	68.172
139	1	X	68.172	SQ.M	68.172
140	1	X	68.172	SQ.M	68.172
TOTAL					818.064

GRID	NO	TYPE	AREA	UNIT	TOTAL AREA
141	1	X	68.172	SQ.M	68.172
142	1	X	68.172	SQ.M	68.172
143	1	X	68.172	SQ.M	68.172
144	1	X	68.172	SQ.M	68.172
145	1	X	68.172	SQ.M	68.172
146	1	X	68.172	SQ.M	68.172
147	1	X	68.172	SQ.M	68.172
148	1	X	68.172	SQ.M	68.172
149	1	X	68.172	SQ.M	68.172
150	1	X	68.172	SQ.M	68.172
TOTAL					818.064

GRID	NO	TYPE	AREA	UNIT	TOTAL AREA
151	1	X	68.172	SQ.M	68.172
152	1	X	68.172	SQ.M	68.172
153	1	X	68.172	SQ.M	68.172
154	1	X	68.172	SQ.M	68.172
155	1	X	68.172	SQ.M	68.172
156	1	X	68.172	SQ.M	68.172
157	1	X	68.172	SQ.M	68.172
158	1	X	68.172	SQ.M	68.172
159	1	X	68.172	SQ.M	68.172
160	1	X	68.172	SQ.M	68.172
TOTAL					818.064

EXECUTIVE ENGINEER-IV
W/S Division, CMDA
Chungnam

Executive Engineer-III
Sew. Division, CMDA,
Chungnam

TO BE SANCTIONED
MEMO NO. _____
DATED: _____

Chief Engineer,
Chungnam

24.10 MORS (LICENSE NO 83 OF
2018, DATED 17/09/2012)
IN SECTOR NO. CHUNGAM WANSUK URSAN
COMPLEX BEING DEVELOPED BY ARMED
DEVELOPERS LTD. & OTHERS.

OWNER'S SEAL
& SIGNATURE

ARCHITECT'S SEAL
& SIGNATURE

DR. HAN-JI
MEGASER
BPAC

DR. HAN-JI
MEGASER
BPAC

ARMED DEVELOPERS LIMITED
AUTHORITY'S SEAL
& SIGNATURE

ENGINEER-IN-CHARGE
CHUNGAM

ENGINEER-IN-CHARGE
CHUNGAM

ARMED DEVELOPERS LIMITED
AUTHORITY'S SEAL
& SIGNATURE

ENGINEER-IN-CHARGE
CHUNGAM

ENGINEER-IN-CHARGE
CHUNGAM

ARMED DEVELOPERS LIMITED
AUTHORITY'S SEAL
& SIGNATURE

PHASE-1
BASEMENT-1 AREA CHART

Scale: 1:500


Sheet No: BA-02

ARMED DEVELOPERS LIMITED
PROJECT NO. CHUNGAM
U.S.A. NO. 103, PHASE-1
AREA CHART

- 1. BUILDING HAS AUTOMATIC SPRINKLER SYSTEM WHEREVER REQUIRED BY NBC.
- 2. BUILDING WILL BE RECORDED AT THE LOCAL OFFICE AS PER RELEVANT IS CODES FOR EARTHQUAKE RESISTANCE.

DOUBLE STACK PARKING (44X2 = 88 Nos.)
SINGLE PARKING 462 Nos.


SCHEDULE OF DOORS + WINDOWS				
TYPE	SIZE	LOCATION	DESCRIPTION	LEVEL FROM FFL
FD	1200x2400	FG RM	FIRE DOOR	+2400
DC	RM/PLMP RM	DC RM/ACUSTICS DOOR		+2400
FD1	2930x2400	ELEC. RM/OVG RM		+100
FD2	1500x2300	STAIRCASE	FIRE DOOR	+2400
FD3	1100x2400	REFUGICE AREA	FIRE DOOR	+2400
FD4	1100x2400	STAIRCASE/LIFT LOBBY	FIRE DOOR	+2400
FD5	750x2300	ELECTRICAL/AV/LV/OWP	FIRE DOOR	+2400
FD6	500x2300	OWP	FIRE DOOR	+2400

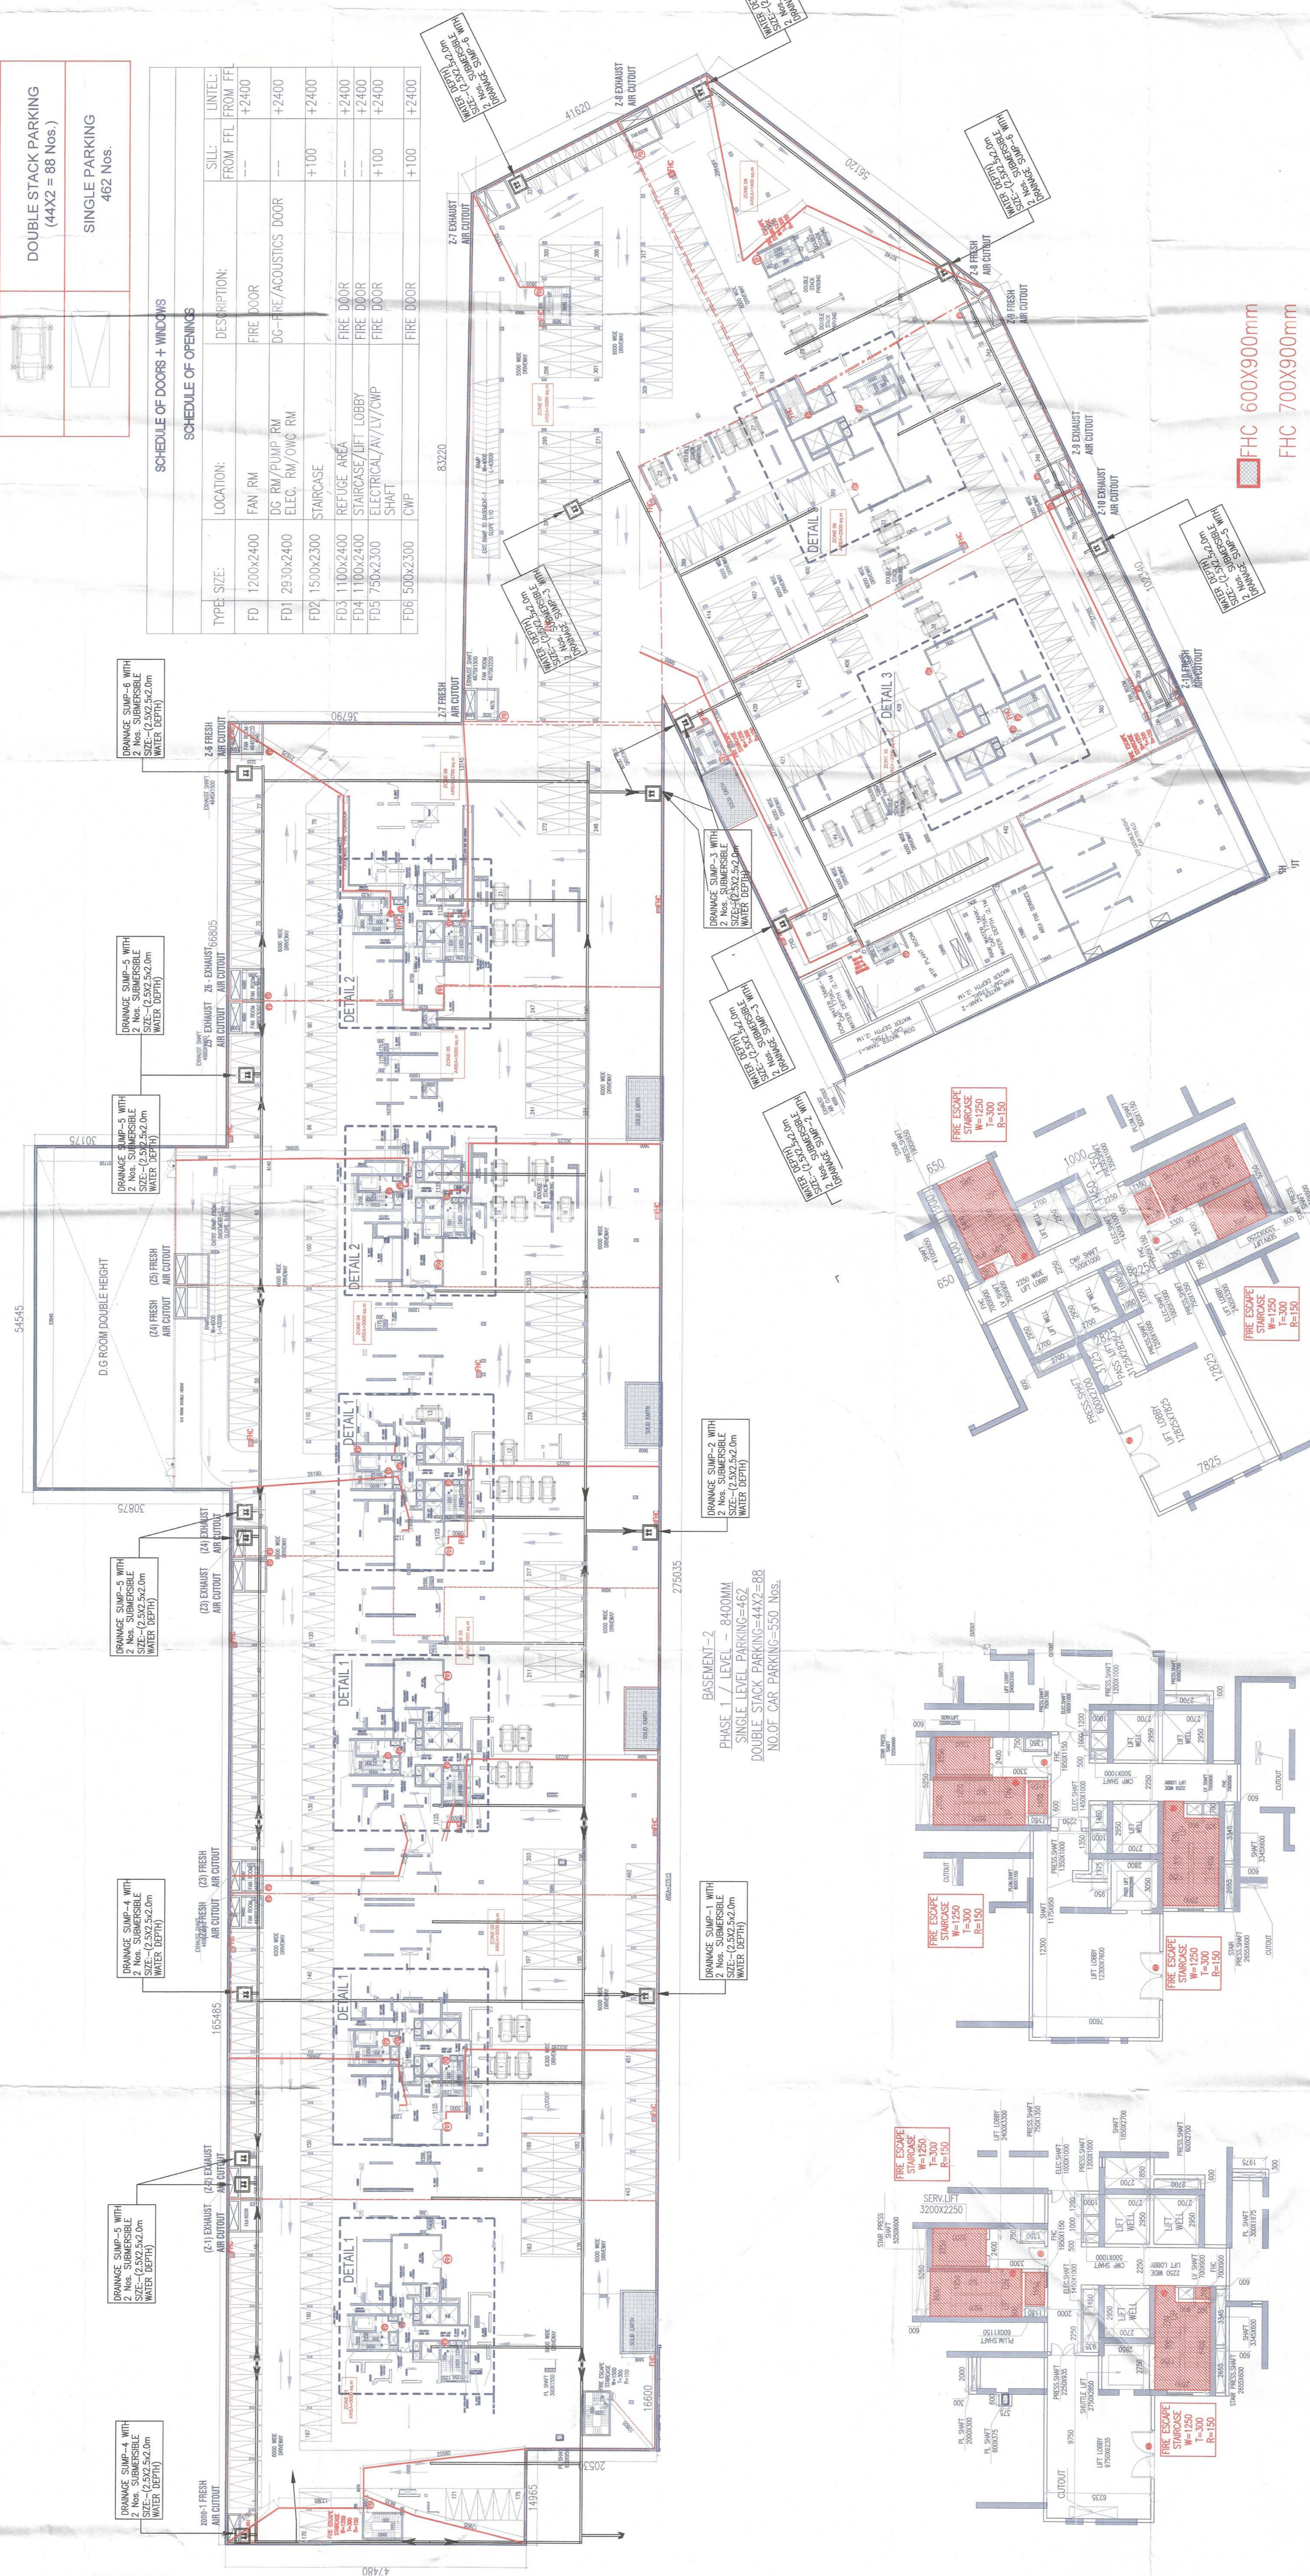


FHC 600X900mm
FHC 700X900mm
FHC 600X900mm



DETAIL 3

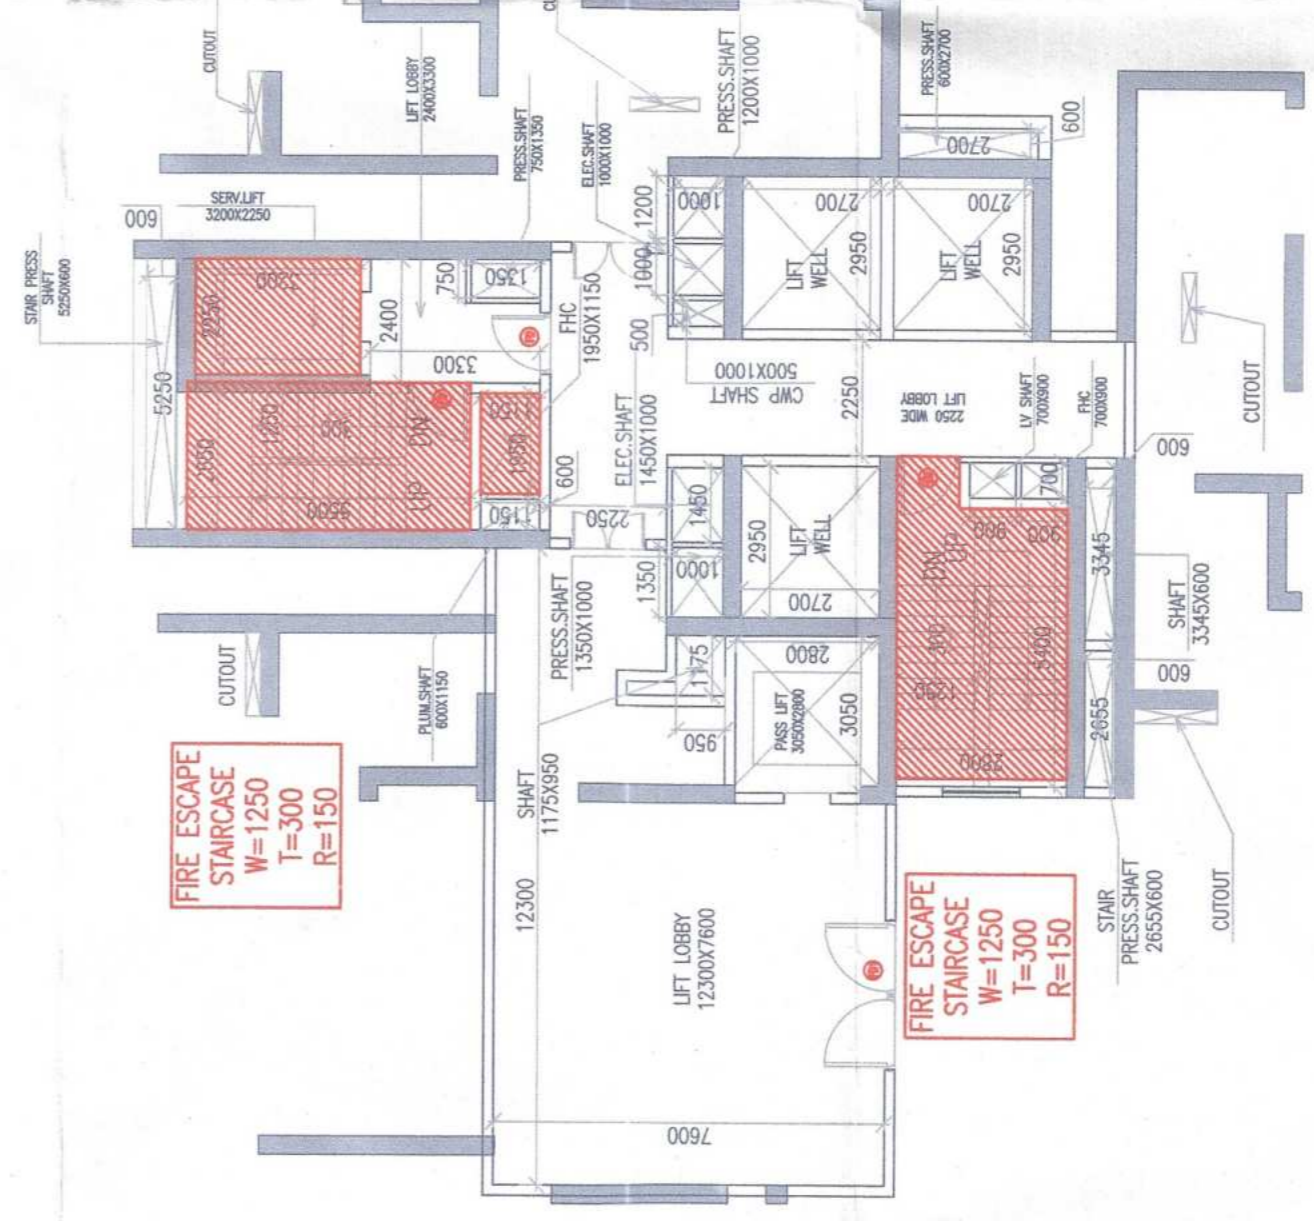

DETAIL 2

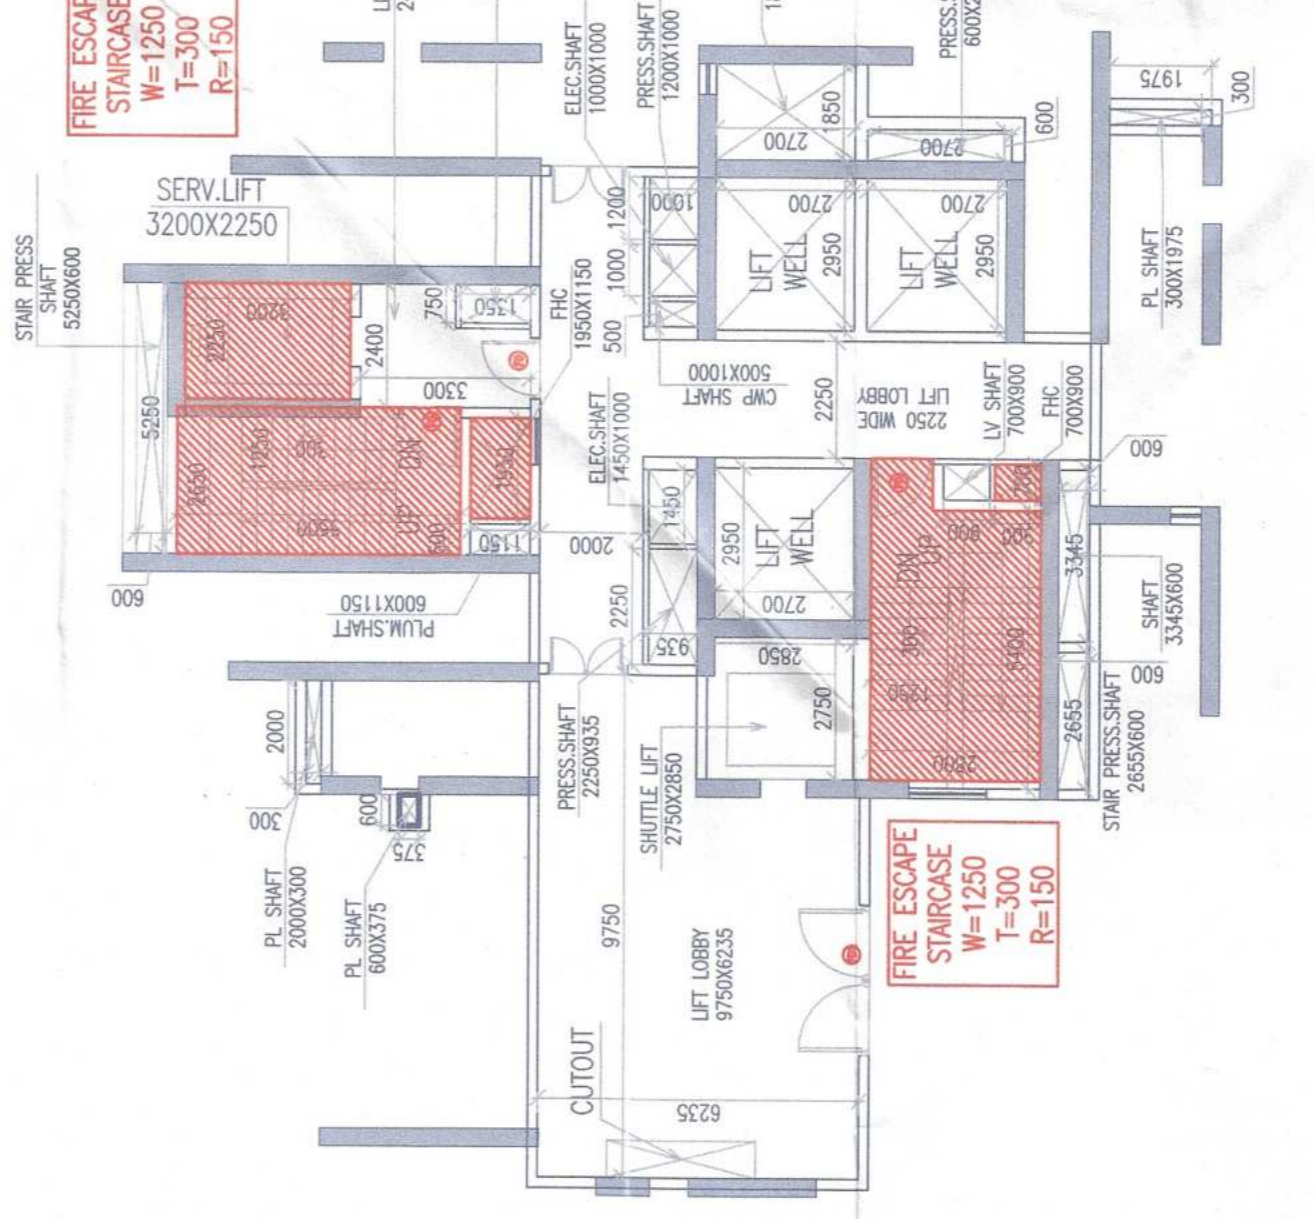

DETAIL 1

BASEMENT-2
PHASE 1 / LEVEL - 8400MM
SINGLE LEVEL PARKING=462
DOUBLE STACK PARKING=44X2=88
NO. OF CAR PARKING=550 NOS.

PROJECT: PROPOSED Building Plan GROUP HOUSING COLONY MANSIONING 24 TO ACRES (LICENCE NO 80 OF 2012 DATED 17/09/2012) IN SECTOR 106, GURGRAM MANSION LIRBAN COMPLEX BEING DEVELOPED BY ARMED DEVELOPERS LTD. & OTHERS. OWNER'S SEAL & SIGNATURE

ARMED DEVELOPERS LIMITED
ARCHITECTS: SEAL & SIGNATURE
ARCHITECT: ANAND KUMAR MAHIA
PROJ. NO. 462, PH 106/2000
New Phase Vihar, Gurugram

Scale: 1:300
Drawing No: AUG-2022
Drawing Title: PHASE 1 BASEMENT-2 PLANS
Drawing No: BA-03

Approved by:
Anand K. Mahia
Architect
Member
B.P.A.C.

Approved by:
Anand K. Mahia
Architect
Member
B.P.A.C.

Approved by:
Anand K. Mahia
Architect
Member
B.P.A.C.

Approved by:
Anand K. Mahia
Architect
Member
B.P.A.C.

Approved by:
Anand K. Mahia
Architect
Member
B.P.A.C.

Approved by:
Anand K. Mahia
Architect
Member
B.P.A.C.

Approved by:
Anand K. Mahia
Architect
Member
B.P.A.C.

Approved by:
Anand K. Mahia
Architect
Member
B.P.A.C.

Approved by:
Anand K. Mahia
Architect
Member
B.P.A.C.

Approved by:
Anand K. Mahia
Architect
Member
B.P.A.C.

Approved by:
Anand K. Mahia
Architect
Member
B.P.A.C.

Approved by:
Anand K. Mahia
Architect
Member
B.P.A.C.

Approved by:
Anand K. Mahia
Architect
Member
B.P.A.C.

Approved by:
Anand K. Mahia
Architect
Member
B.P.A.C.

Approved by:
Anand K. Mahia
Architect
Member
B.P.A.C.

Approved by:
Anand K. Mahia
Architect
Member
B.P.A.C.

Approved by:
Anand K. Mahia
Architect
Member
B.P.A.C.


Approved by:
Anand K. Mahia
Architect
Member
B.P.A.C.

Approved by:
Anand K. Mahia
Architect
Member
B.P.A.C.

Approved by:
Anand K. Mahia
Architect
Member
B.P.A.C.

Note:-
 1. BUILDINGS AUTOMATIC SPRINKLER SYSTEM WHEREVER REQUIRED BY N.E.C.
 2. BUILDING WILL BE DESIGNED (STRUCTURES) AS PER RELEVANT IS CODES FOR EARTHQUAKE RESISTANCE.

SCHEDULE OF DOORS + WINDOWS			
SCHEDULE OF OPENINGS			
TYPE/ SIZE:	LOCATION:	DESCRIPTION:	SILL FROM FFL TO UNITEL FROM FFL
FD 1200x2400	FAN RM	FIRE DOOR	+2400
FD1 2330x2400	DG RM/SHOPS RM ELEC. RM/OMC RM	DG-FIRE/ACOUSITUS DOOR	+2400
FD2 1500x2300	STAIRCASE	FIRE DOOR	+100
FD3 1100x2400	REFUGE AREA	FIRE DOOR	+2400
FD4 1100x2400	STAIRCASE/LIFT LOBBY	FIRE DOOR	+2400
FD5 750x2300	ELECTRICAL/LV/CWP SHAFT	FIRE DOOR	+100
FD6 500x2300	CWP	FIRE DOOR	+100

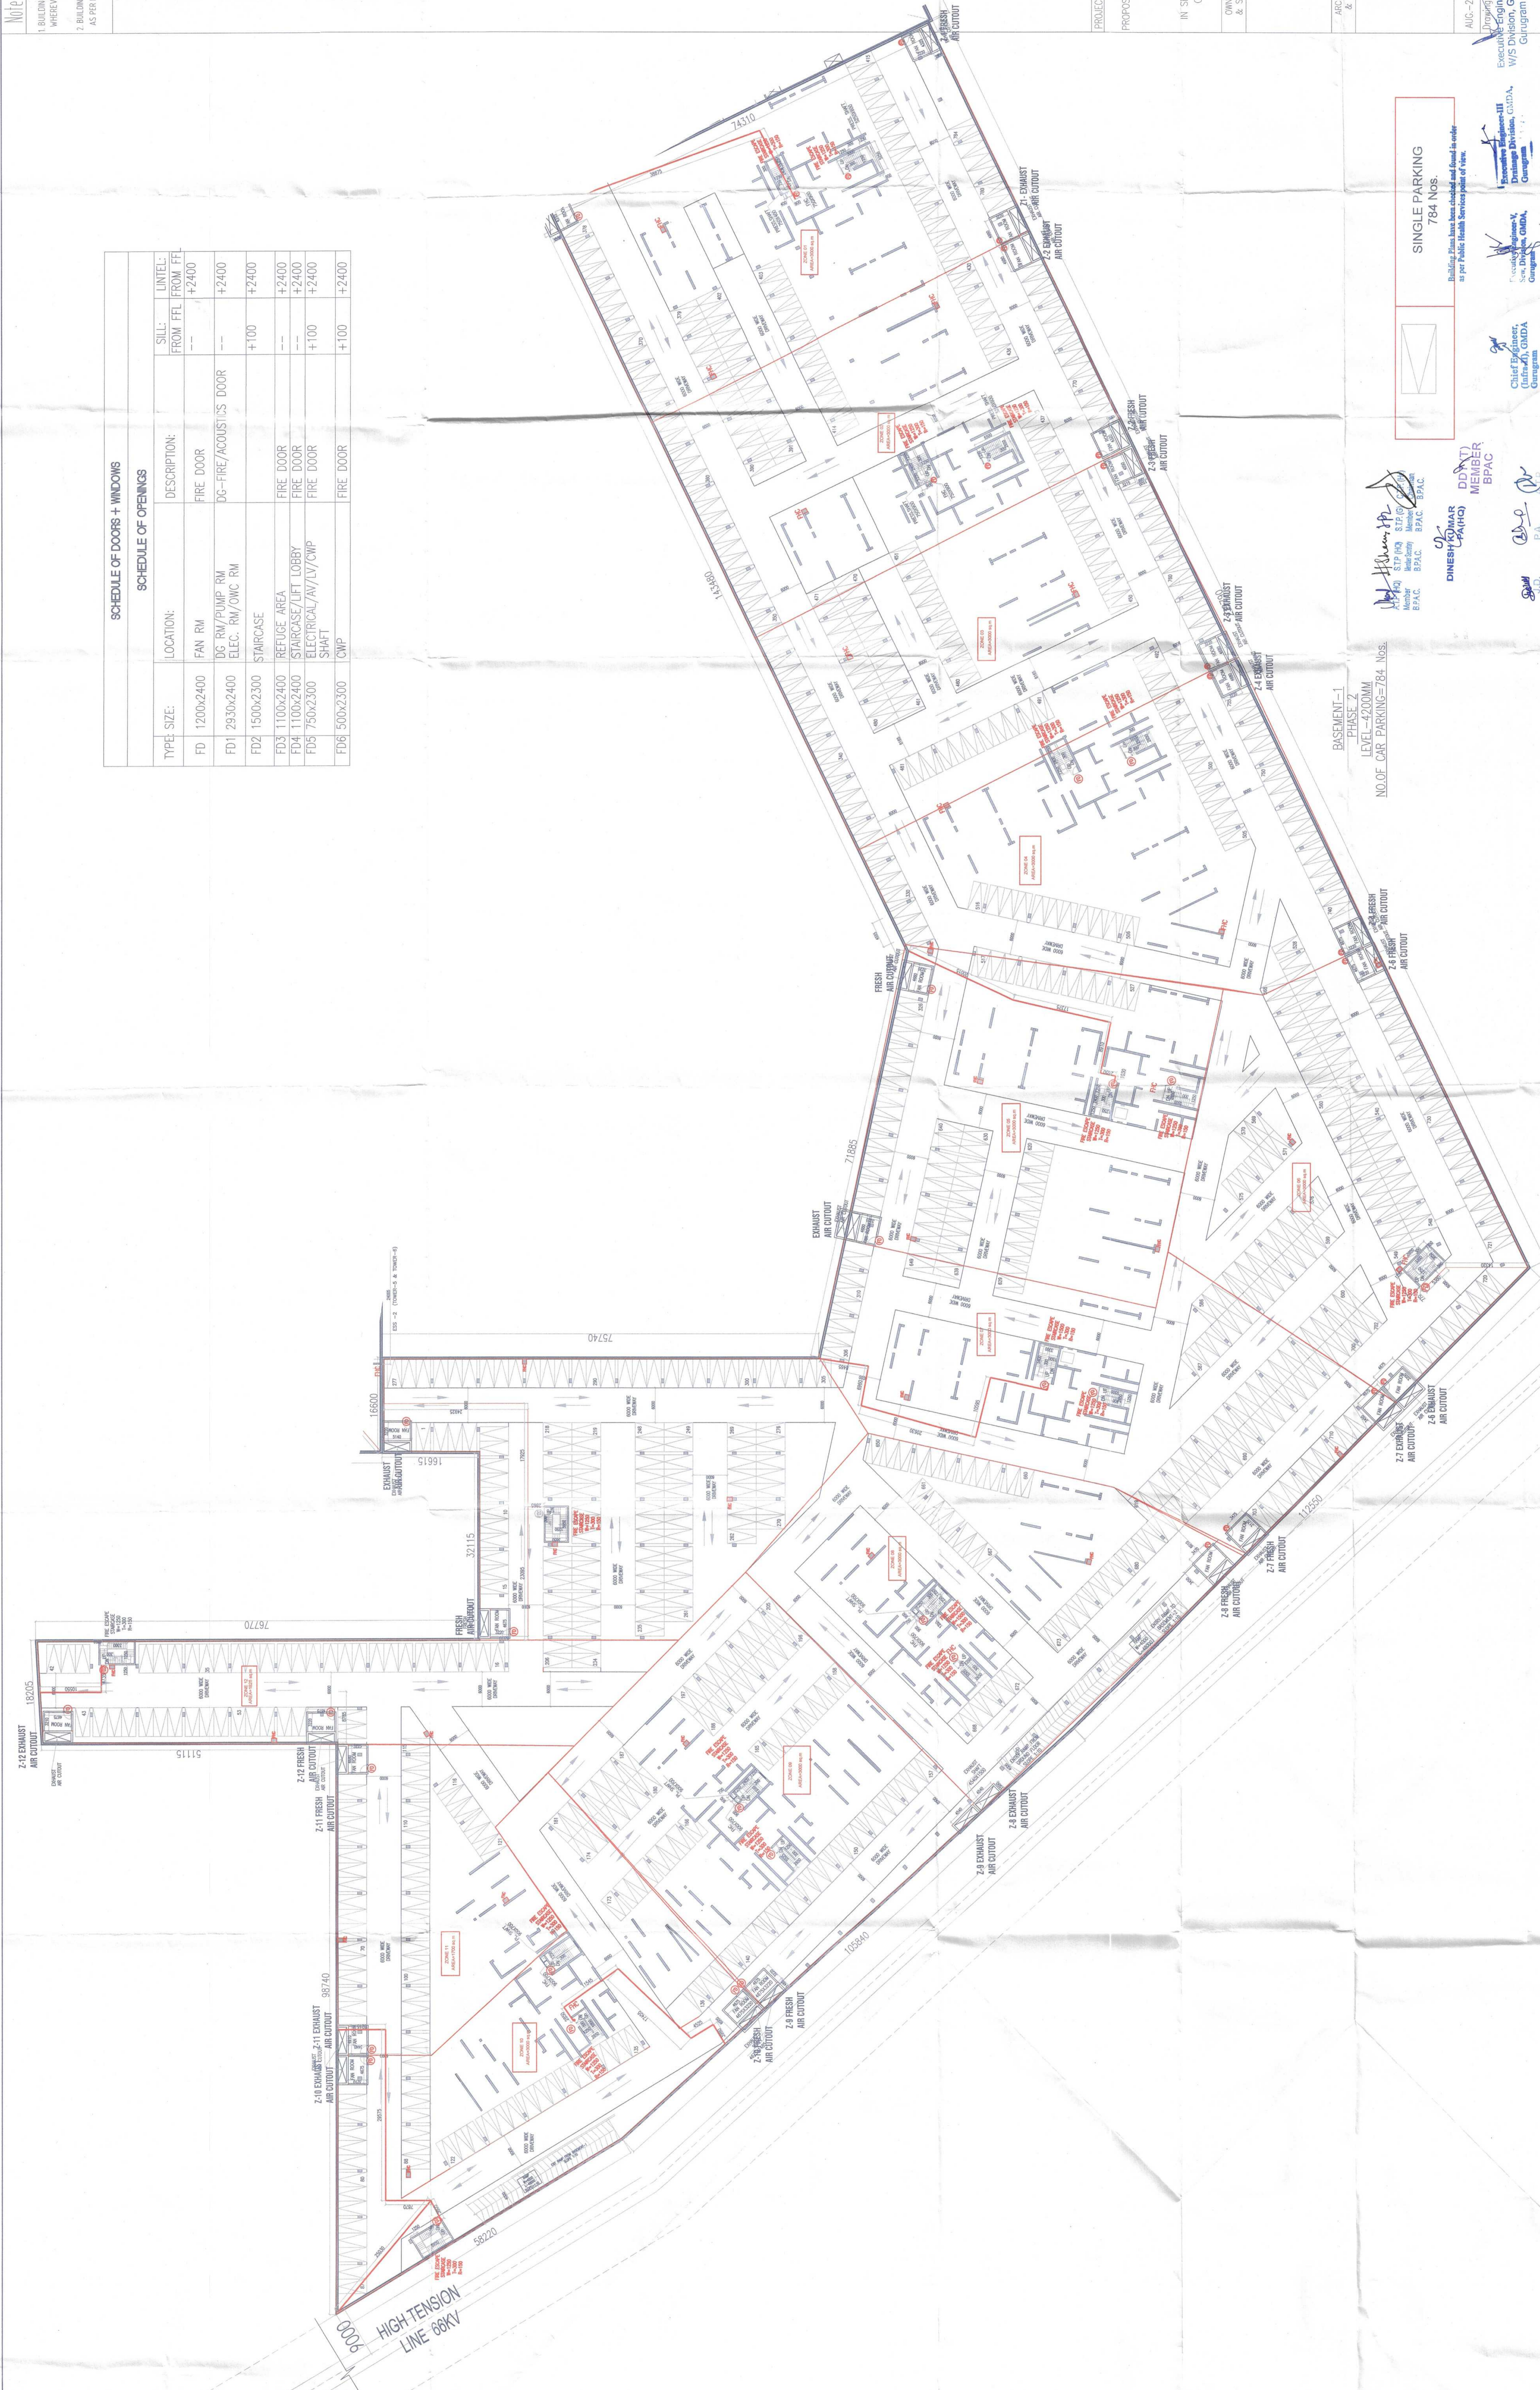

PROJECT:
 PROPOSED Building Plan Group Housing Colony
 MEASURING
 24.10 ACRES (LICENCE NO. 80 OF
 2012 DATED 17/08/2012)
 IN SECTOR 106, GURUGRAM MANESAR URBAN
 COMPLEX BEING DEVELOPED BY ARMD
 DEVELOPERS LTD. & OTHERS.
 OWNER'S SEAL
 & SIGNATURE

Armd Developers Limited
 Authorised Signatory

ARCHITECT'S SEAL
 & SIGNATURE
CAPIVIA
 ANKUSH CHANDRA VAIDYA
 Architect No. CP/150009
 New Phase Vihar, Gurugram

AUG-2022 Scale: 1:300
 Drawing No: BA-05

SINGLE PARKING
 784 NOS.
 Building Plans have been checked and found in order
 as per Public Health Service Code of Bye.

Approved by:
 Chief Engineer,
 Sanitation, GMDA,
 Gurugram

Approved by:
 Chief Engineer,
 (Infrastructure), GMDA,
 Gurugram

Approved by:
 DINESH KUMAR
 MEMBER
 BPAC

Approved by:
 S.P.A.
 P.A.

Approved by:
 S.P.A.
 P.A.

NO. OF CAR PARKING=784 Nos.
 BASEMENT-1
 LEVEL-GROUND
 SANCTIONED
 HEAD NO. WITH THIS OFFICE
 DATED:

Note:-
1. BUILDINGS AUTOMATIC SPRINKLER SYSTEM WHERE REQUIRED BY THE
2. BUILDINGS WILL BE DESIGNED STRUCTURES AS PER RELEVANT IS CODES FOR EARTH quake RESISTANCE.

SCHEDULE OF DOORS + WINDOWS			
SCHEDULE OF OPENINGS			
TYPE SIZE	LOCATION	DESCRIPTION	SILL FROM FF ₁ TO FF ₂
FD 1200x2400	FAN RM	FIRE DOOR	+2400
FD1 2930x2400	DC RM/PUMP RM ELEC. RM/OVC RM	DC-FIRE/ACOUSTICS DOOR	+2400
FD2 1500x2300	STAIRCASE	FIRE DOOR	+100
FD3 1100x2400	REFURGE AREA	FIRE DOOR	+2400
FD4 1100x2400	STAIRCASE/LIFT LOBBY	FIRE DOOR	+2400
FD5 750x2300	ELECTRICAL/AV/LV/CWP SHAFT	FIRE DOOR	+100
FD6 500x2300	CWP	FIRE DOOR	+100

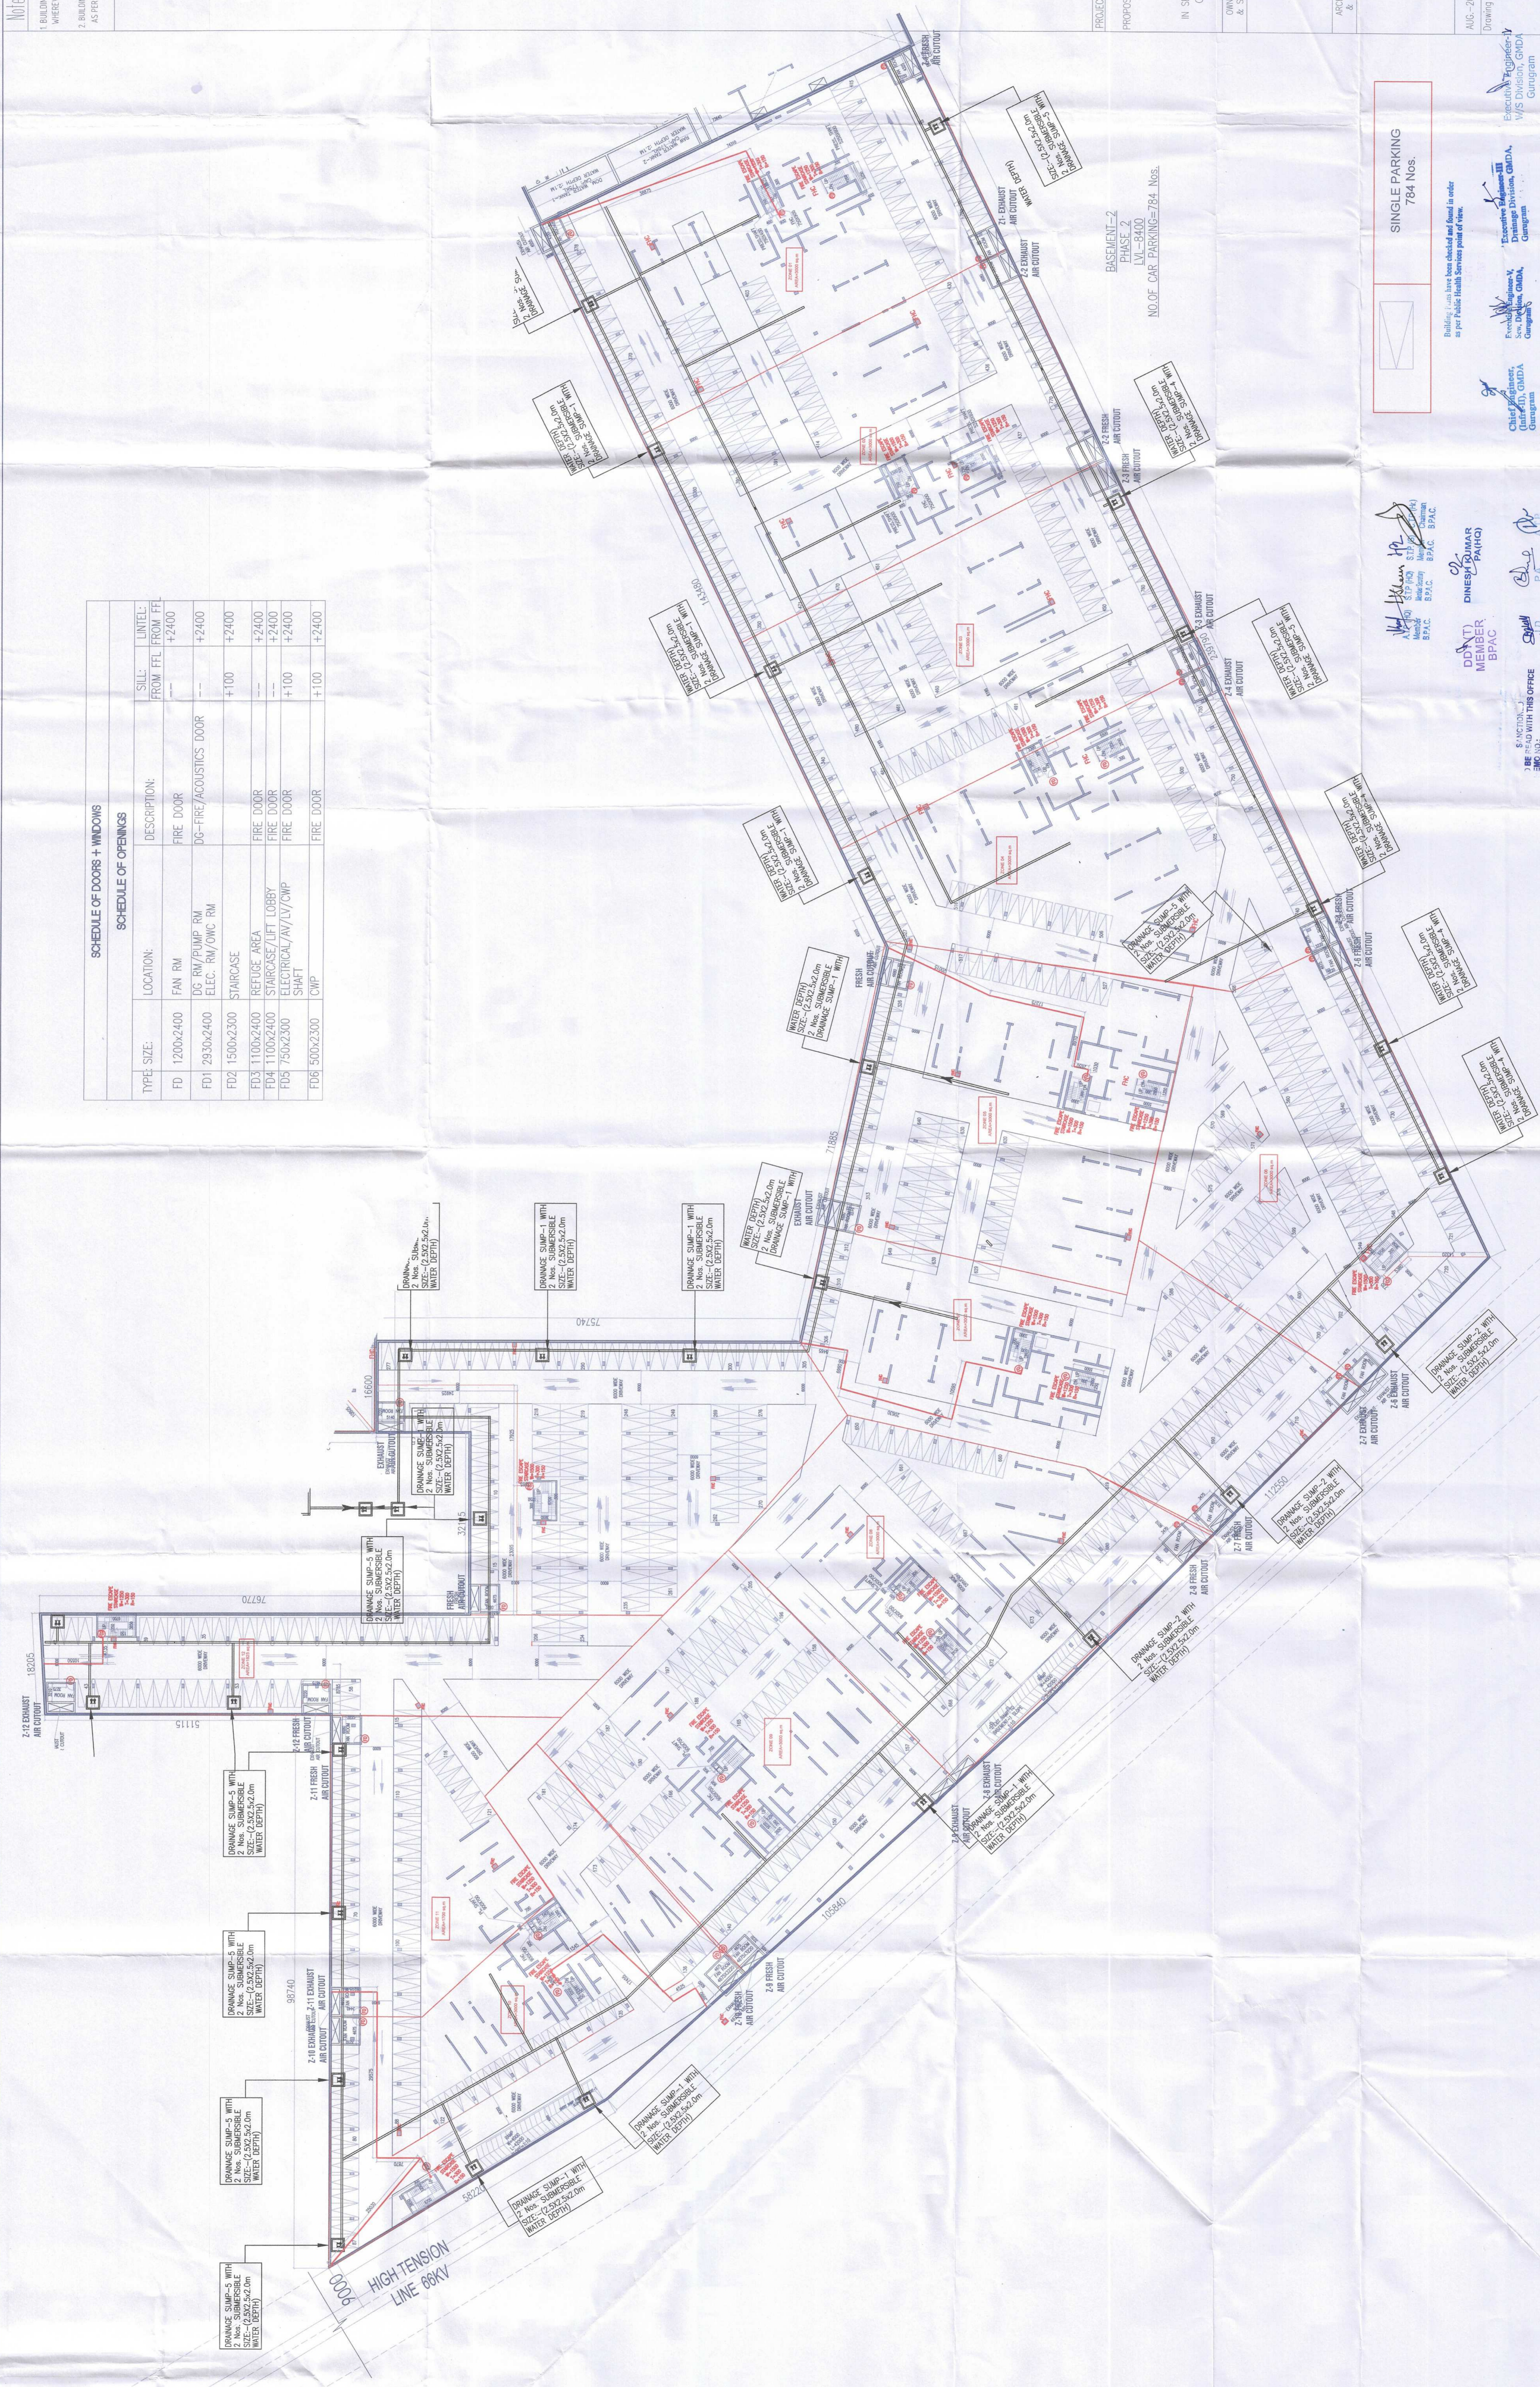

PROJECT:
PROPOSED Building Plan GROUP HOUSING COLONY
MEASURING
24.10 ACRES (LICENCE NO. 80 OF
2012 DATED 17/09/2012)
IN SECTOR 106, GURUSAM MANESAR URBAN
COMPLEX BEING DEVELOPED BY ARJUN
DEVELOPERS LTD. & OTHERS.

OWNER'S SEAL
& SIGNATURE

Architect's Seal
& SIGNATURE

Limited Developer's Limited
Architect's Seal
& SIGNATURE

AVINASH CHANDRA VAIDYA
ARCHITECTS
New Patna Vihar, Gurgaon

Scale : 1:300
Drawing Title: PHASE 2 PRESENT-02
Drawing No: BA-07

Building Plans have been checked and found in order
as per Public Health Services point of view.

Executive Engineer,
W/S Division, GHDA,
Gurgaon

Executive Engineer,
W/S Division, GHDA,
Gurgaon

Chief Engineer,
GHDA,
Gurgaon


Sd/-
P.E.
Sd/-
P.E.

Sanjay Kumar
BPAAC
DINESH KUMAR
BPAAC
MEMBER
BPAAC

Sd/-
P.E.
Sd/-
P.E.

NOTE:-
BUILDINGS AUTOMATIC SPRINKLER SYSTEM
WHEREVER REQUIRED BY NBC.
2 BUILDINGS SHALL BE PROVIDED STRUCTURES
AS PER RELEVANT IS CODES FOR EARTHQUAKE RESISTANCE.

BASEMENT-02 AREA CALCULATION													
GROSS - 1													
B1	=	0.5	X	1	X	1,010	X	18,175	=	9,178	SQM		
B2	=	1	X	1	X	18,175	X	51,115	=	929,015	SQM		
B3	=	0.5	X	1	X	42,550	X	70,110	=	1,491,590	SQM		
B4	=	1	X	1	X	74,365	X	70,110	=	5,213,730	SQM		
B5	=	1	X	1	X	16,260	X	16,915	=	275,038	SQM		
B6	=	0.5	X	1	X	29,315	X	28,010	=	425,214	SQM		
B7	=	1	X	1	X	45,075	X	29,010	=	1,307,626	SQM		
B8	=	1	X	1	X	48,715	X	74,475	=	3,629,050	SQM		
B9	=	0.5	X	1	X	15,350	X	70,225	=	539,977	SQM		
B10	=	0.5	X	1	X	74,880	X	122,660	=	4,592,390	SQM		
B11	=	0.5	X	1	X	26,350	X	74,330	=	979,298	SQM		
B12	=	1	X	1	X	239,495	X	74,330	=	17,801,663	SQM		
TOTAL											=	37,191,770	SQM
SERVICE AREA													
GROSS - 2													
S1	=	1	X	4	X	7,100	X	4,250	=	120,700	SQM		
S2	=	1	X	6	X	3,200	X	5,900	=	113,280	SQM		
S3	=	1	X	6	X	6,600	X	4,000	=	156,400	SQM		
S4	=	1	X	1	X	6,600	X	5,000	=	33,000	SQM		
S5	=	1	X	1	X	3,200	X	6,750	=	21,600	SQM		
S6	=	1	X	1	X	2,750	X	1,200	=	3,300	SQM		
TOTAL											=	460,280	SQM
NET AREA OF BASEMENT - 02											GROSS - 1	37,191,770	SQM
SERVICE AREA OF BASEMENT - 02											GROSS - 2	460,280	SQM
TOTAL											GROSS - 1	37,191,770	SQM
NET PARKING AREA OF BASEMENT - 02											GROSS - 1	37,191,770	SQM
TOTAL											367,41,490	SQM	
NO OF CAR ACHIEVABLE OF BASEMENT - 02											367,41,490	CARS	
OR SAY											11,48,172	CARS	
											32	CARS	

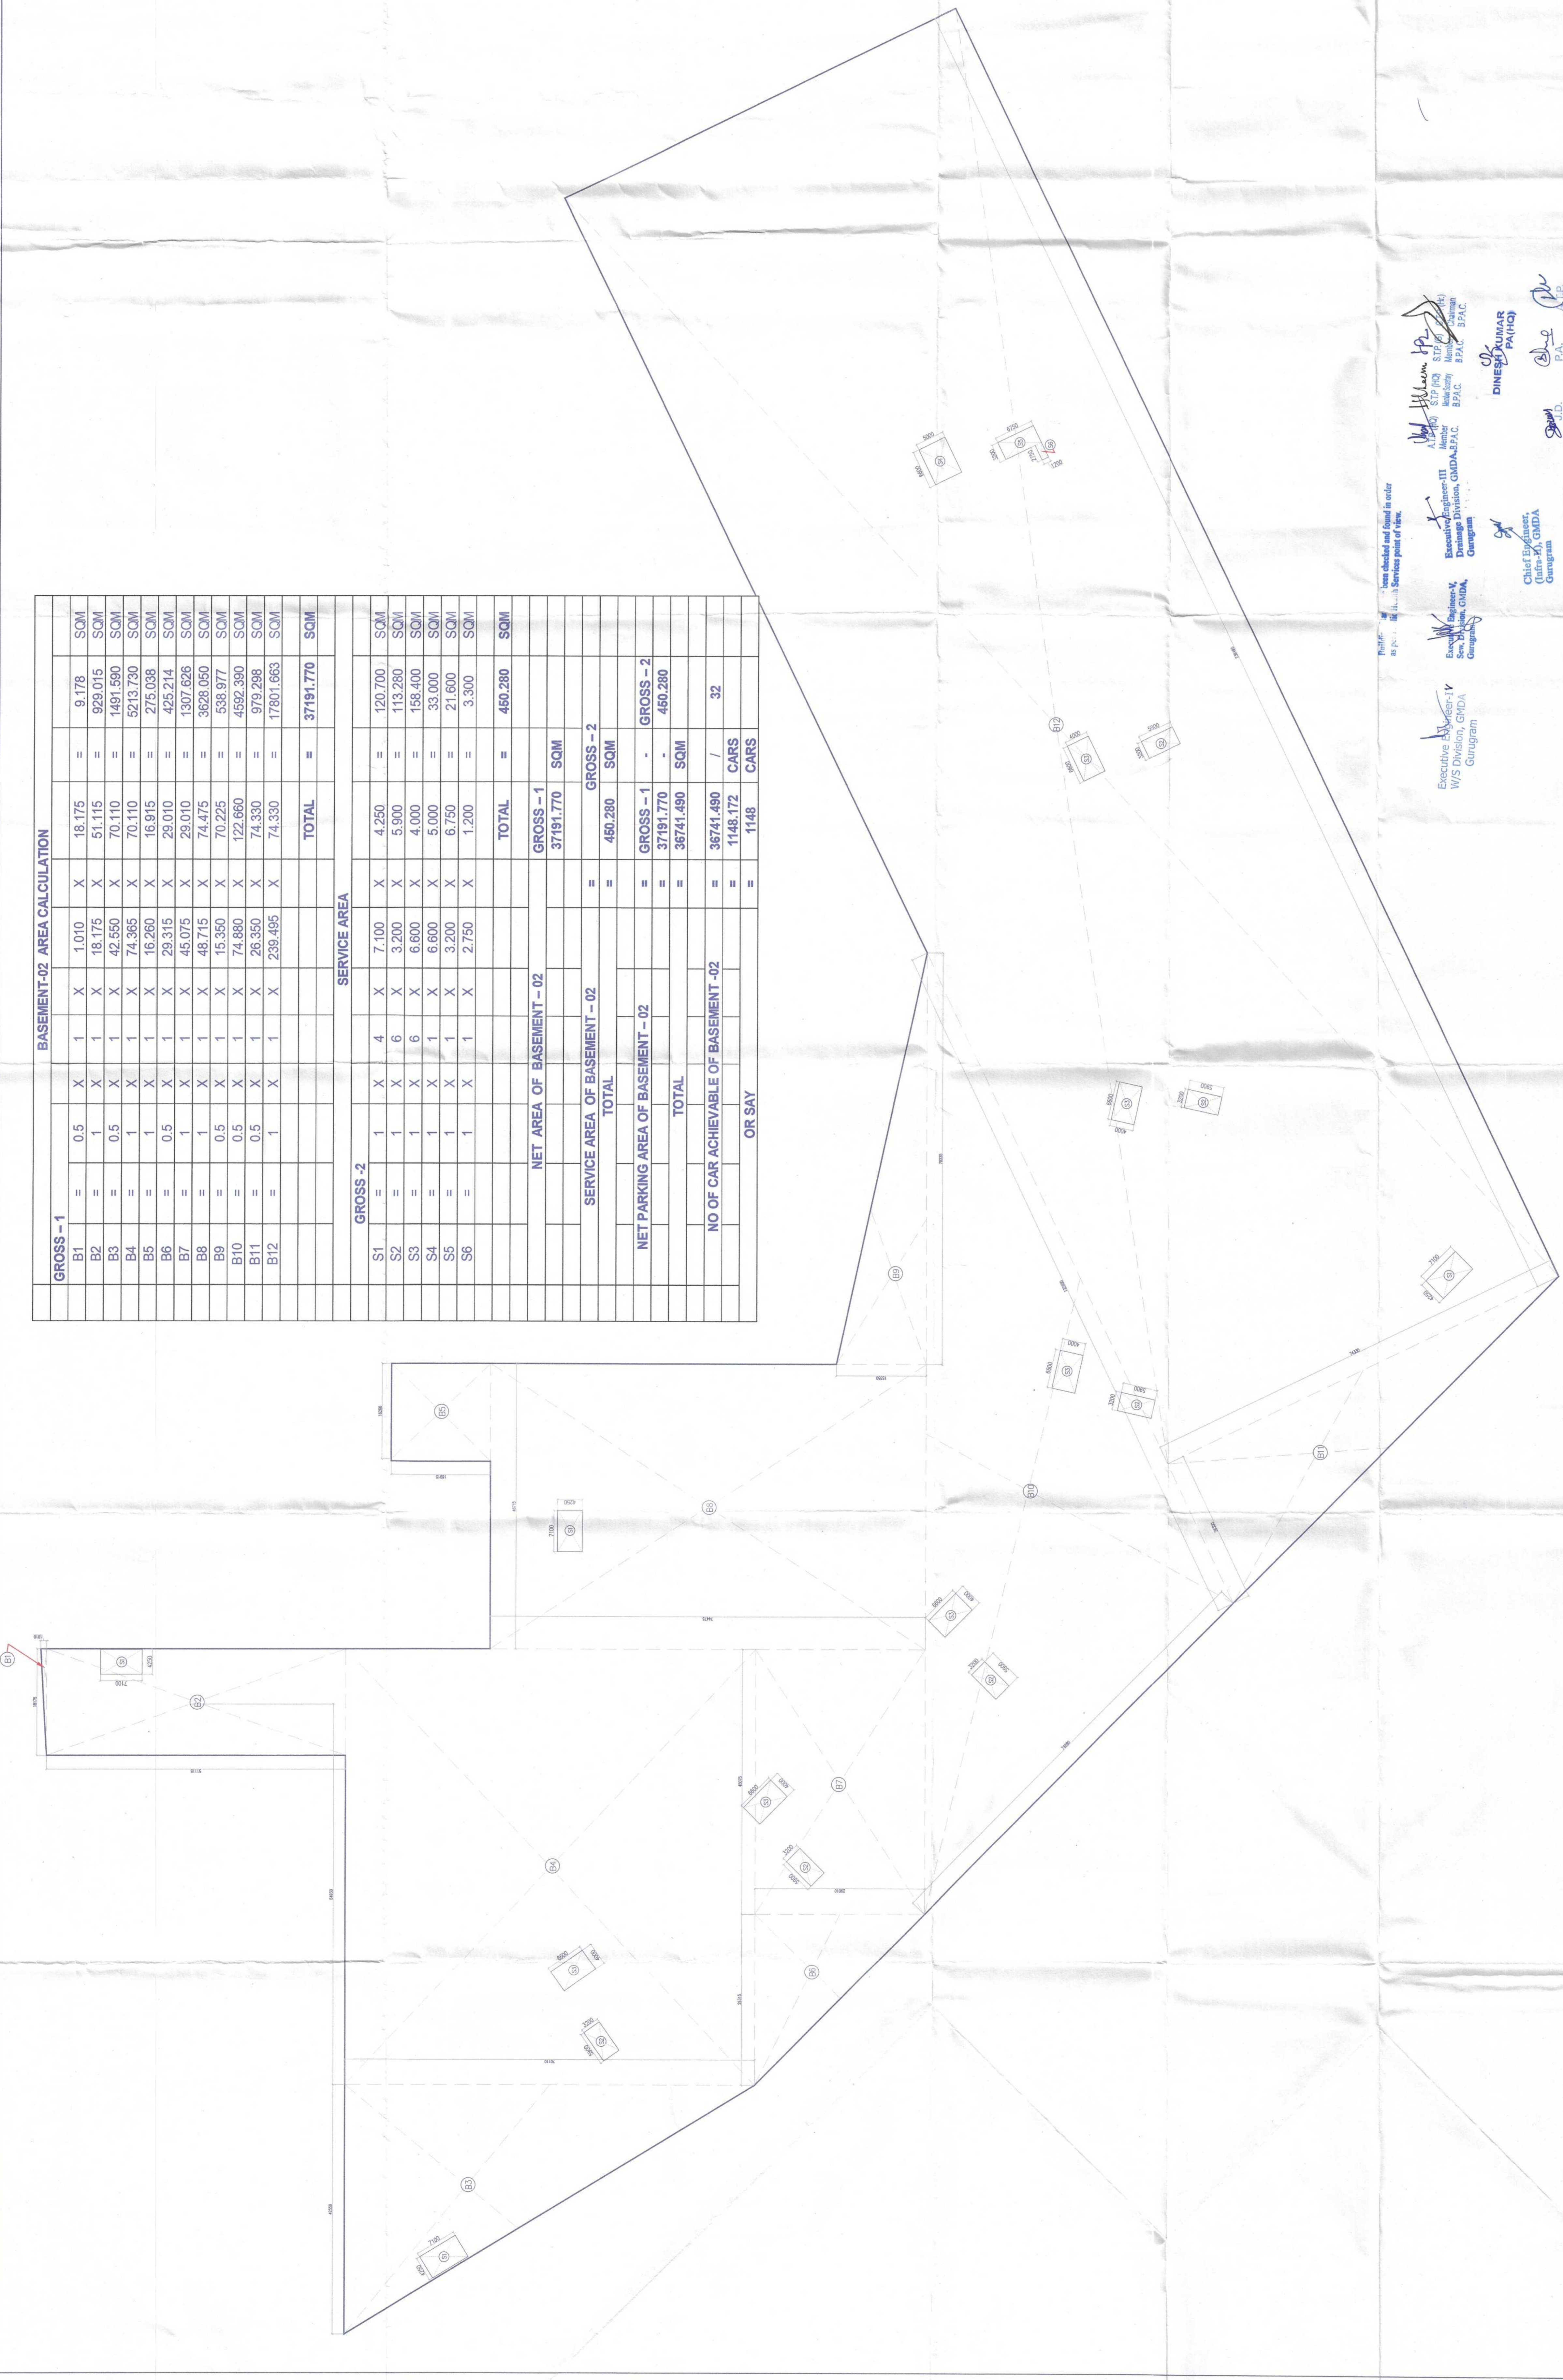

PROJECT:
PROPOSED Building Plan GROUP HOUSING COLONY
IN SECTOR 106, GURGRAM, MANESAR URBAN
COMPLEX BEING DEVELOPED BY ARMO
DEVELOPERS LTD. & OTHERS.
OWNER'S SEAL
& SIGNATURE
Architect's SEAL
& SIGNATURE
Armo Developers Limited
Authorized Signatory
AVINASH CHATURVEDI
Architect (No. 143, Phd)
New Palm Vihar, Gurgram
AUG-2022. Scale: 1:500. Drawing No.: PHASE 2 AREA OF BASEMENT-1 BS-08

Executive Engineer - V
W/S Division, GMDA
Gurgram

Executive Engineer - III
Drainage System, GMDA, Gurgram

Chief Engineer,
GMDA
Gurgram


Executive Engineer - III
Water Supply, GMDA, Gurgram

Executive Engineer - III
Municipal Corporation,
Gurgram

DINESH KUMAR
PANCHI
P.A.

DD (CT)
MEMBER
BPAC

SEAL OF ARCHITECT'S OFFICE
BY:

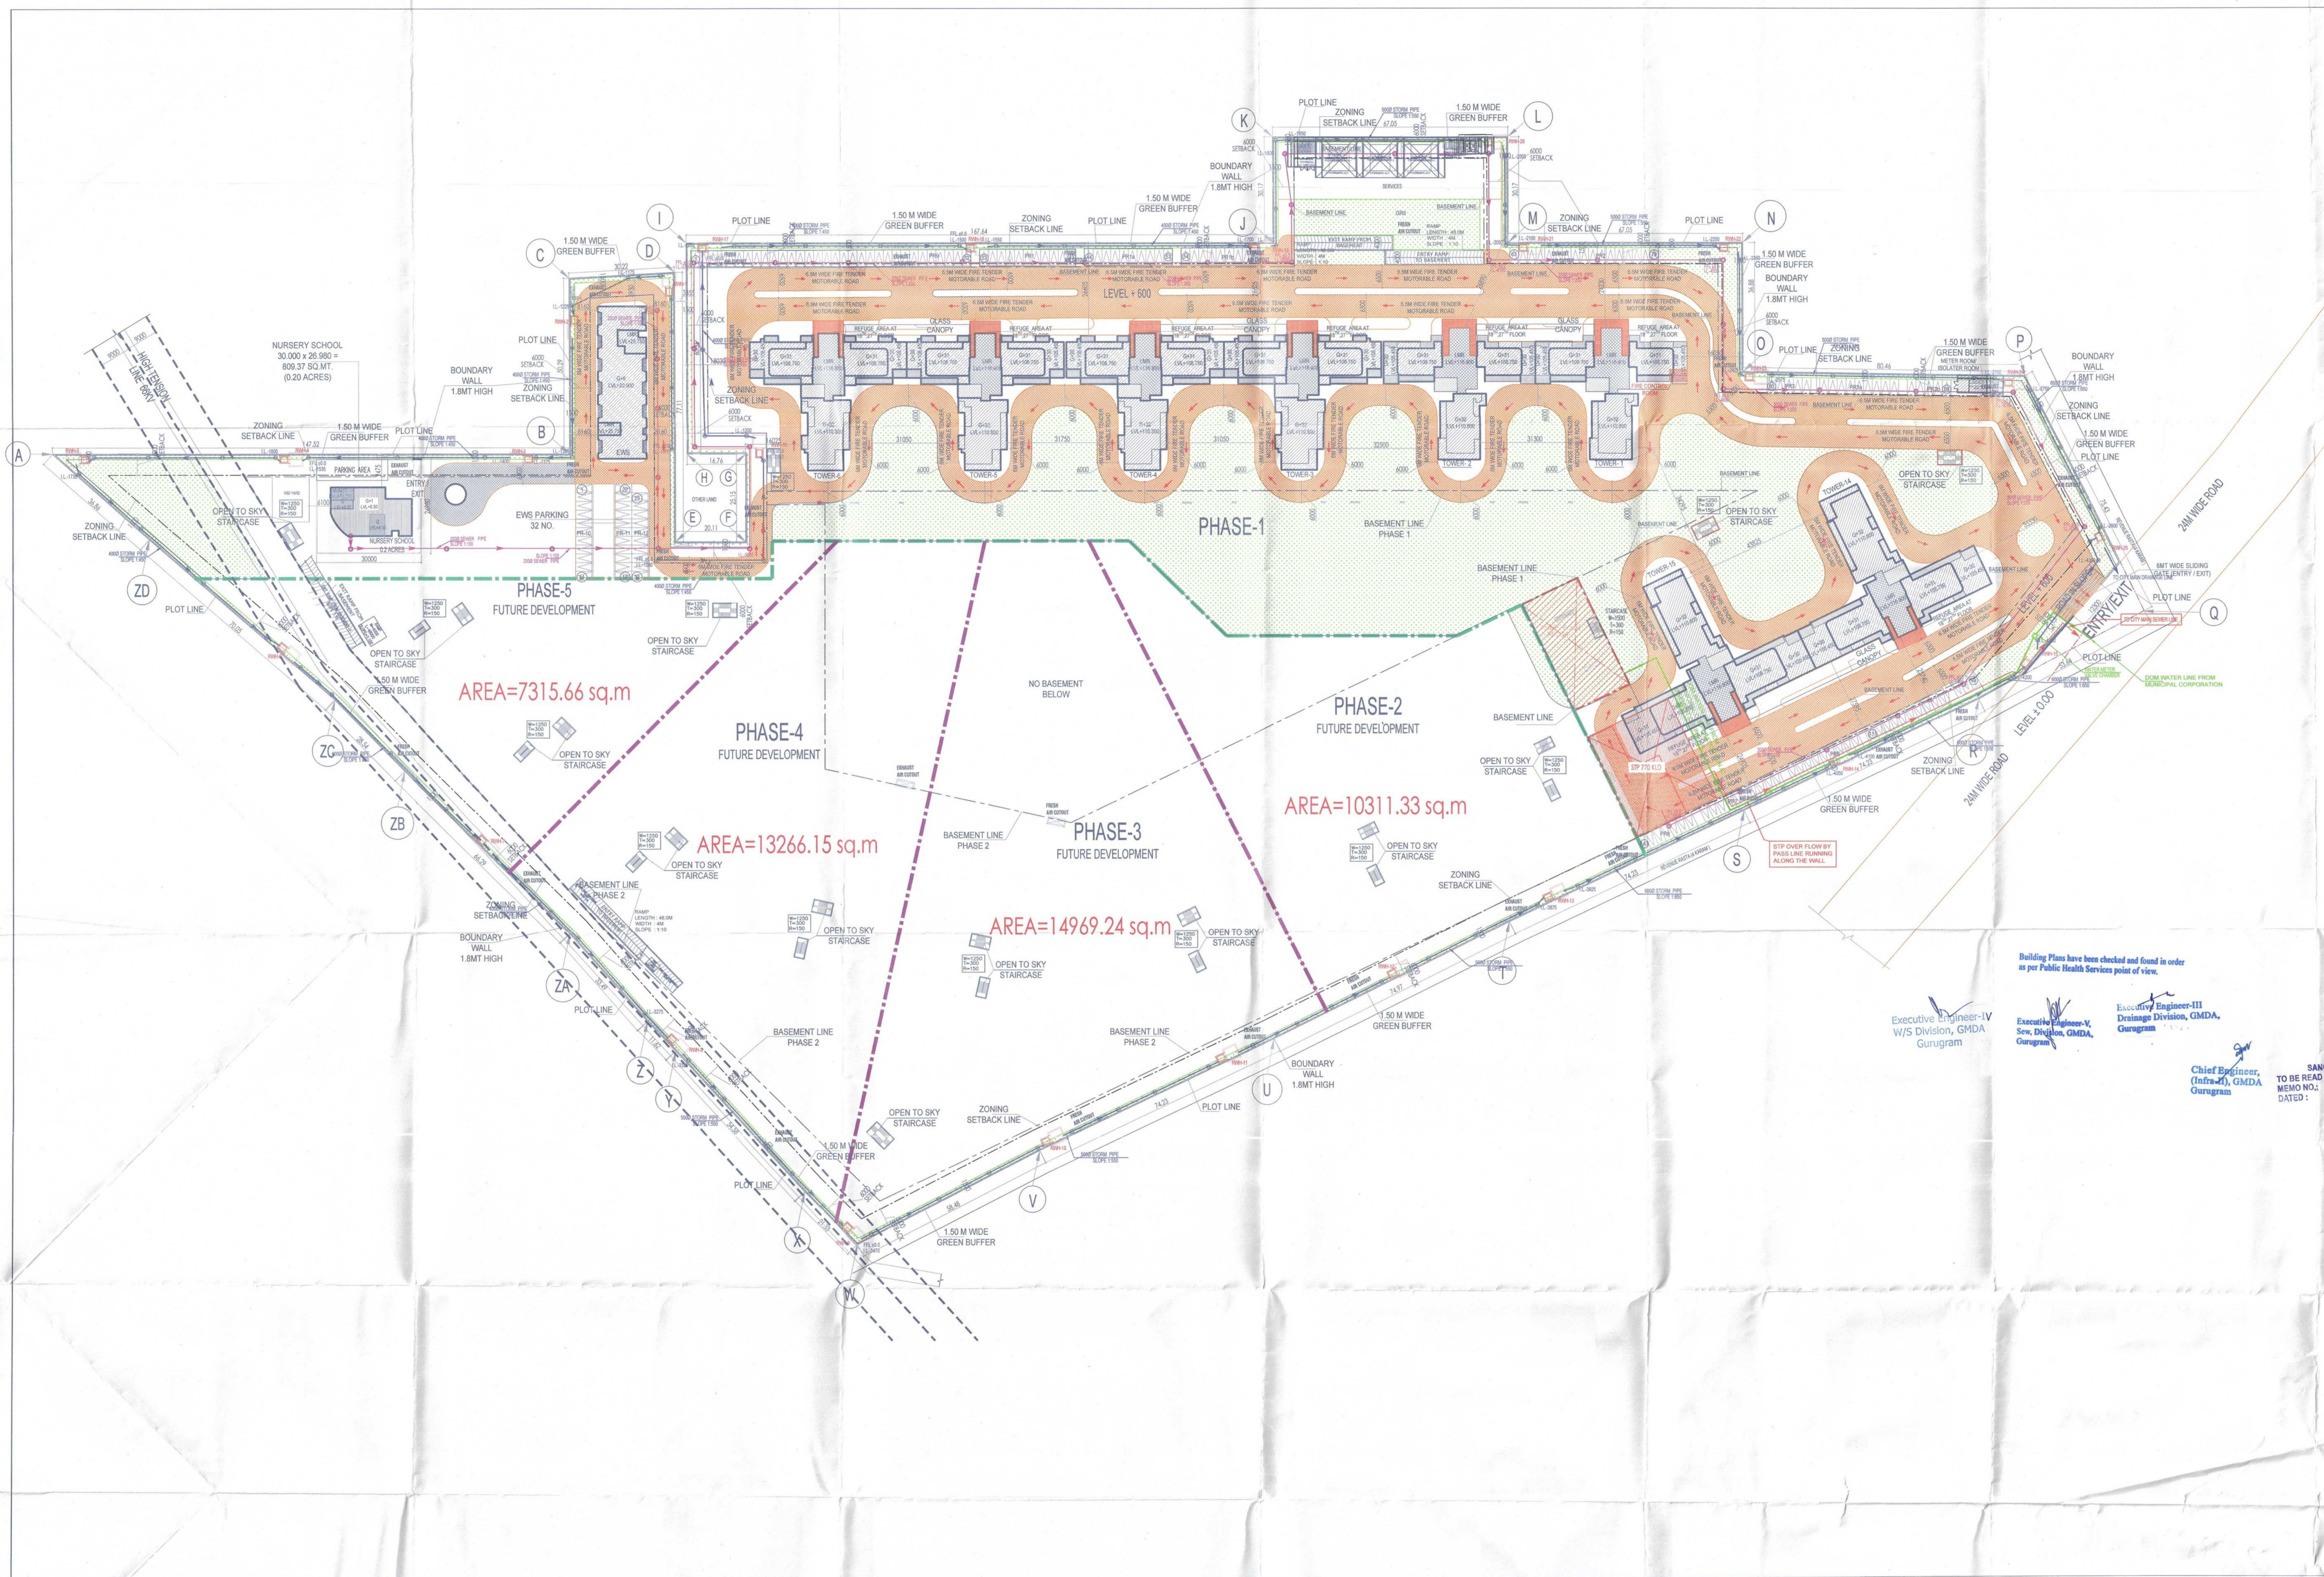

AREA=7315.66 sq.m

AREA=13266.15 sq.m

AREA=14969.24 sq.m

AREA=10311.33 sq.m

Note :-

1. BUILDING HAS AUTOMATIC SPRINKLER SYSTEM WHEREVER REQUIRED BY NBC.
2. BUILDING WILL BE DESIGNED (STRUCTURES) AS PER RELEVANT IS CODES FOR EARTH QUAKE RESISTANCE.

PROJECT:
 PROPOSED BUILDING PLAN OF GROUP HOUSING COLONY MEASURING 24.10 ACRES (LICENCE NO 80 OF 2012 DATED 17/08/2012) IN SECTOR 106, GURUGRAM MANESAR URBAN COMPLEX BEING DEVELOPED BY ARMD DEVELOPERS LTD. & OTHERS.

Building Plans have been checked and found in order as per Public Health Services point of view.

Executive Engineer-IV
 W/S Division, GMDA
 Gurugram

Executive Engineer-IV
 Sew. Division, GMDA,
 Gurugram

Chief Engineer,
 (Infra-4), GMDA,
 Gurugram

SANCTIONED TO BE READ WITH THIS OFFICE MEMO NO. DATED -

ATP (HO) Member B.P.A.C.
 S.T.P. (HO) Member B.P.A.C.
 S.T.P. (O) Member B.P.A.C.
 Chairman B.P.A.C.

DINESH KUMAR PA(HO) DD(T) MEMBER BPAC



OWNER'S SEAL & SIGNATURE

ARCHITECT'S SEAL & SIGNATURE

ARMED DEVELOPERS LIMITED
 ARCHITECT'S SIGNATURE
 ANIRASH CHANDRA WADYA
 Archt No. CA/75/22006
 H. No. 103, PH-II
 New Palam Vihar, Gurugram

AUG 2022 Scale: 1:600
 Drawing title: Drawing No.:

SITE PLAN SERVICES SF-03